

DESIGN DATA

AIRPORT CATEGORY - TRANSPORT

RUNWAY CATEGORY - NON-PRECISION

RUNWAY SURFACE - ASPHALT CONCRETE

RUNWAY LENGTH

RUNWAY WIDTH


6500

- 6900'X 195'

- X50'

STATE OF ALASKA DEPARTMENT OF TRANSPORTATION. AND


PUBLIC FACILITIES SOUTHEASTERN REGION DESIGN AND CONSTRUCTION DIVISION

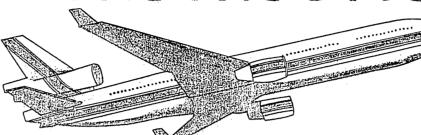

SITKA AIRPORT IMPROVEMENTS

NO. 69612

RUNWAY PAVING, GROOVING AND MISCELLANEOUS AIRPORT IMPROVEMENTS

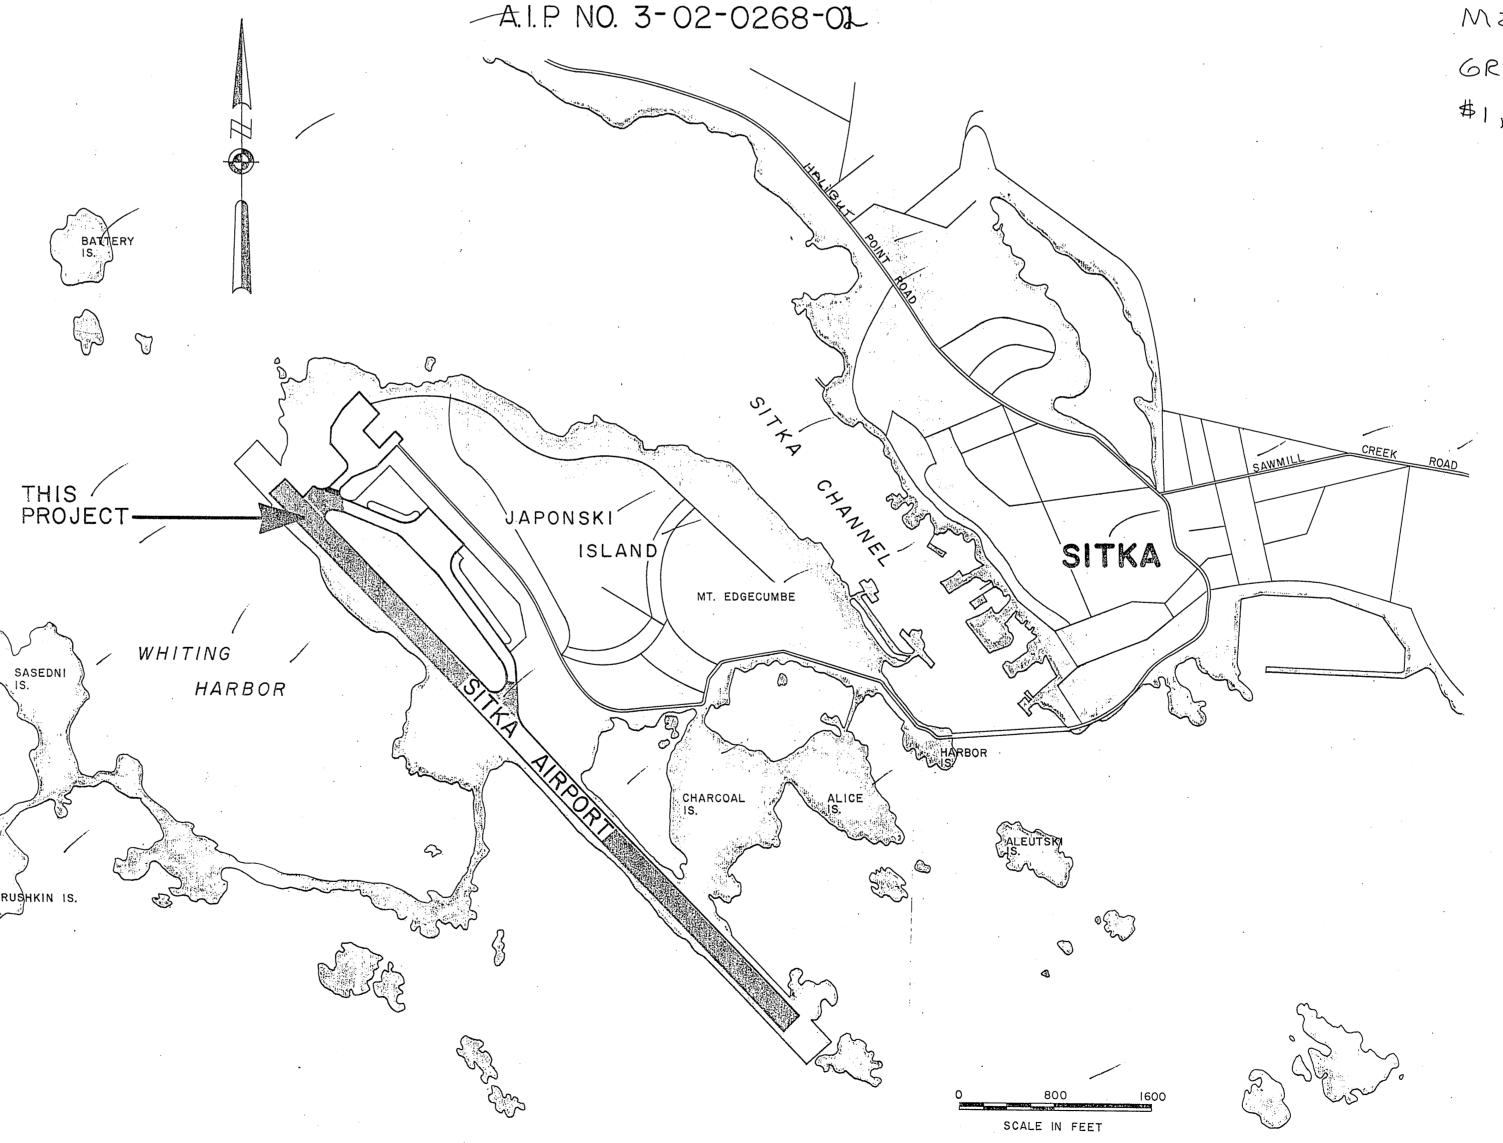

A CONTRACTOR OF THE CONTRACTOR	INDEX OF SHEETS							
SHEET NO.	DESCRIPTION							
	TITLE SHEET							
2	SITE PLAN, ESTIMATE OF QUANTITIES, BASIS OF ESTIMATE							
<u></u>	TYPICAL SECTIONS -							
<u>/</u> 4	TAXIWAY DETAILS							
~ 5	STRIPING DETAILS							
<u>6</u>	TAXIWAY GUIDANCE SIGN DETAILS							
<u></u>	SIGN DETAIL SHEET, INLET DETAIL							
<u>8</u>	RUNWAY CLOSURE PLAN —							
THE PROPERTY OF THE PROPERTY O								

GREG BROWNING \$1,174,985.00

> STATE OF ALASKA DEPARTMENT OF TRANSPORTATION AND

PUBLIC FACILITIES

SOUTHEASTERN REGION DESIGN SECTION

7-20-88

_Date 7-20-88


ENGINEER'S STAMP

APPROVED

E. W. Dannell
Director, S.E. Region Design & Construction

PROJECT NUMBER: 69612 DATE: 6-30-88

SHEET I OF 8

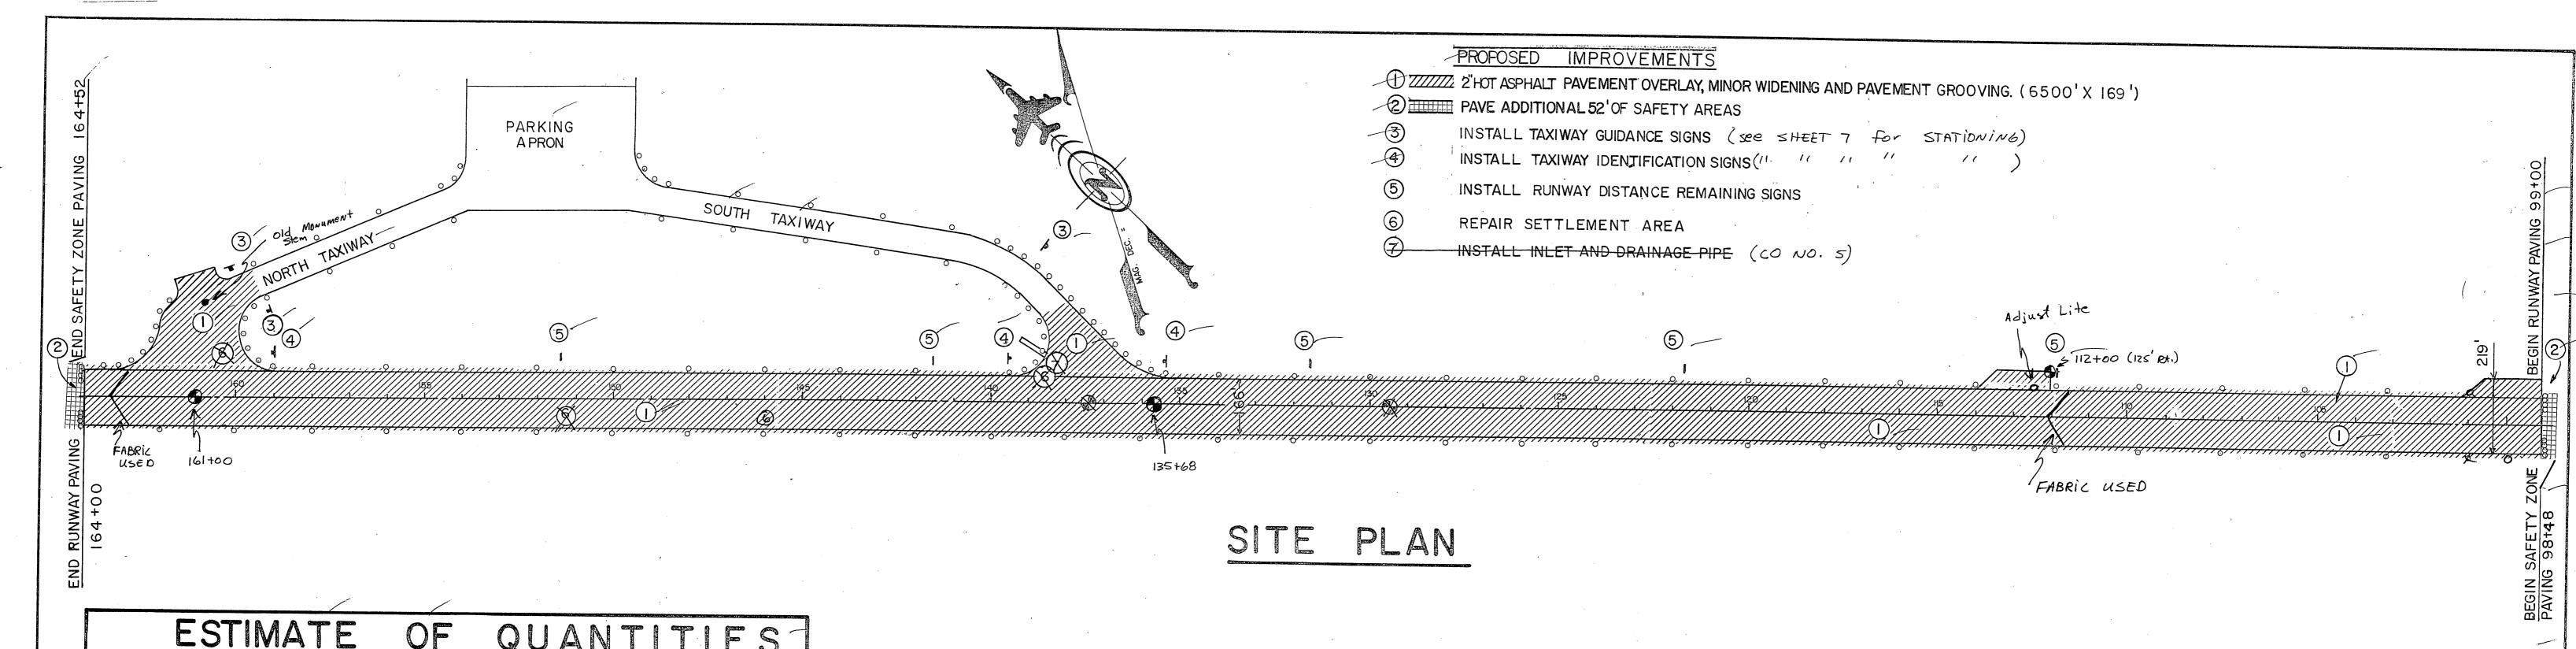

	ESIMATE OF QUAN		
ITEM NO	ITEM .	UNIT	AMOUNT
90 —	MBE & WBE ADJUSTMENTS	C.S.	ALL REQ'D.
100	MOBILIZATION & DEMOBILIZATION	L.S. /	ALL REQ'D.
		A CONTRACTOR OF THE CONTRACTOR	
121	CONSTRUCTION SURVEYING BY THE CONTRACTOR	L.S. —	ALL REQ'D.
125	ENGINEERING TRANSPORTATION	L.S -	ALL REQ'D
13-0-	ENGINEER'S FIELD OFFICE & LABORATORY (DELETE CO #2)		
280 —	PAVEMENT GROOVING -	g	ALL REQ'D.
3.40	LINEAR GRADING	S. Y.	135,300 134,2
400 a	CORRUGATED METAL PIPE 24", 12 GA., STEEL (DELETE CO#5)	L. S.	ALL REQ'D
470	INLET (DELETE CO #5)		100
510 a	CRUSHED AGGREGATE BASE ((CO #/)	EACH	
552		TON-	17 0 0 / 47
600 a		S,Y.	8100-790
	BITOWINGOO THINE COAT, COTBACK	TON -	18.1 /2, 23
610 /	BITUMINOUS TACK COAT	TON-	51.0 38.2
660 a	ASPHALT CONCRETE (co#1,3,4; Dir. A)	TON-	16,500 /6,9
660c	ASPHALT CEMENT, AC-5	TON -	1073 963 3
700c	STATE TRAFFIC MARKING PAINT -	L. S.	ALL REQ'D.
1000r	LIGHTED RUNWAY / TAXIWAY SIGN	EACH -	
1000s	THRESHOLD LIGHT BASE EXTENSION	EACH	17-
131	REIMBURSEMENT FOR ENGINEERS		111 000
660e	OFFICE AND LABORATORY (C.O.# 2) CREDIT FOR LASAR DELETION (C.O. # 4 , Dir. A)	L.S. L.S.	All Rea
·		2.3.	ATT XCX
		SEC DESCRIPTION OF THE PROPERTY OF THE PROPERT	-
		222	11.00
			Z. A. P.

	BASIS OF	ESTIMATE
ITEM NO.	ITEM	ESTIMATING FACTOR
510a	CRUSHED AGG. BASE COURSE	1.96 TONS/C.U. YDS.
600a/	BITUMINOUS PRIME COAT, MC-30.	0.3 GAL/SY. AT 256 GAL/TON
610/	BITUMINOUS TACK COAT, CSS-I	O. IO GAL/SY AT 240GAL/ TON
	ASPHALT CONCRETE	(II6 LBS./SY. (I"DEPTH)
660c	d	6.5% OF ITEM 660 a

GENERAL NOTES


- THE EXISTING RUNWAY CENTERLINE GRADE & CROSS SLOPE SHALL BE USED AS CONTROL FOR THE NEW ASPHALT PAVEMENT OVERLAY. THE CONTRACTOR SHALL BE RESPONSIBLE FOR DETERMINING THE LOCATION OF THE EXISTING CENTERLINE TO THE SATISFACTION OF THE ENGINEER.
- 2. THE CONTRACTOR SHALL LOCATE ALL SURVEY MONUMENTS AND CASES IN THE PAVEMENT OVERLAY AREA AND SHALL ADJUST THE CASE 1/4" BELOW FINISHED GRADE. THIS WORK SHALL BE CONSIDERED INCIDENTAL TO OTHER ITEMS OF WORK AND NO SEPARATE PAYMENT SHALL BE MADE.
- 3 THE ESTIMATE OF QUANTITIES INCLUDES AN ADDITIONAL 1355 SY. OF PAVING GEOTEXTILE THAT SHALL BE PLACED AS DIRECTED BY THE ENGINEER. FABRIC MAY BE NEEDED IN OTHER AREAS ALONG THE RUNWAY THAT HAVE LARGE CRACKS IN THE PAVEMENT SURFACE.
- 4. ALL PAVEMENT SURFACES IN THE AREA OF THE RUNWAY/TAXIWAY INTERSECTION SHALL BE FREE DRAINING.
- 5. ALL NEW ASPHALT PAVEMENT SURFACES SHALL BE GROOVED AS DETAILED ON SHEET 3 AND AS SPECIFIED IN SECTION 280 OF THE SPECIFICATIONS.
- 6. ONLY NIGHT TIME CLOSURES WILL BE ALLOWED FOR THE PAVING OPERATION. FOR MORE INFORMATION, SEE RUNWAY CLOSURE PLAN AND SECTION 40 OF THE SPECIFICATIONS. THESE CLOSURES ARE FOR LARGER (JET TYPE) AIRCRAFT AND ARE LIMITED AS INDICATED IN THE SPECIFICATIONS.

Moore

y ₃				STATE OF ALASKA
2 114				DEPARTMENT OF TRANSPORTATION
<u></u>				- 8 PUBLIC FACILITIES
	BY	DATE	DESCRIPTION OF CHANGE	
A/F	*************************************	R	ECORD OF REVISIONS	SOUTHEAST REGION DESIGN & CONSTRUCTION

SITKA AIRPORT IMPROVEMENTS
project no. 69612 ESTIMATE OF QUANTITIES


APPROVED BY Movil 7-20-88 DESIGN CHIEF DATE	DESIGNED BY: M.J. Coffey
RECOMMENDED BY: DESIGN ENGINEER, GROUP "8" DATE	DRAWN BY: C.S. Anderson
PREPARED BY PROJECT MANAGER PROJECT MANAGER LEAD DESIGNER	CHECKED BY: T. W. Moore

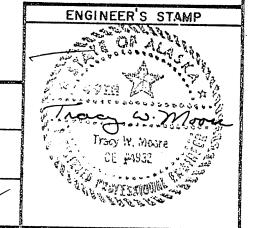


1"= 200'

6-30-88

SHEET 2 OF 8

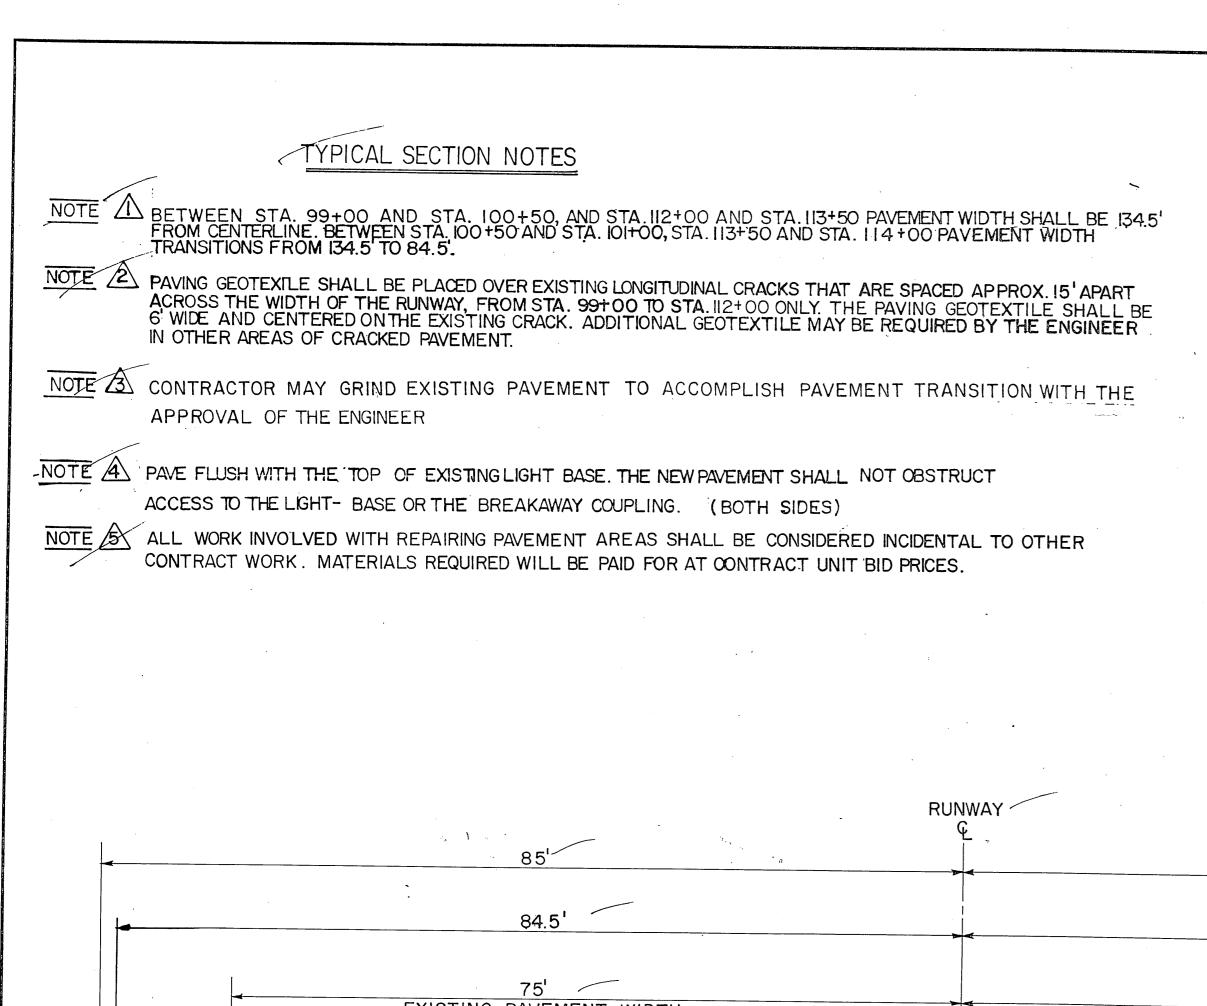

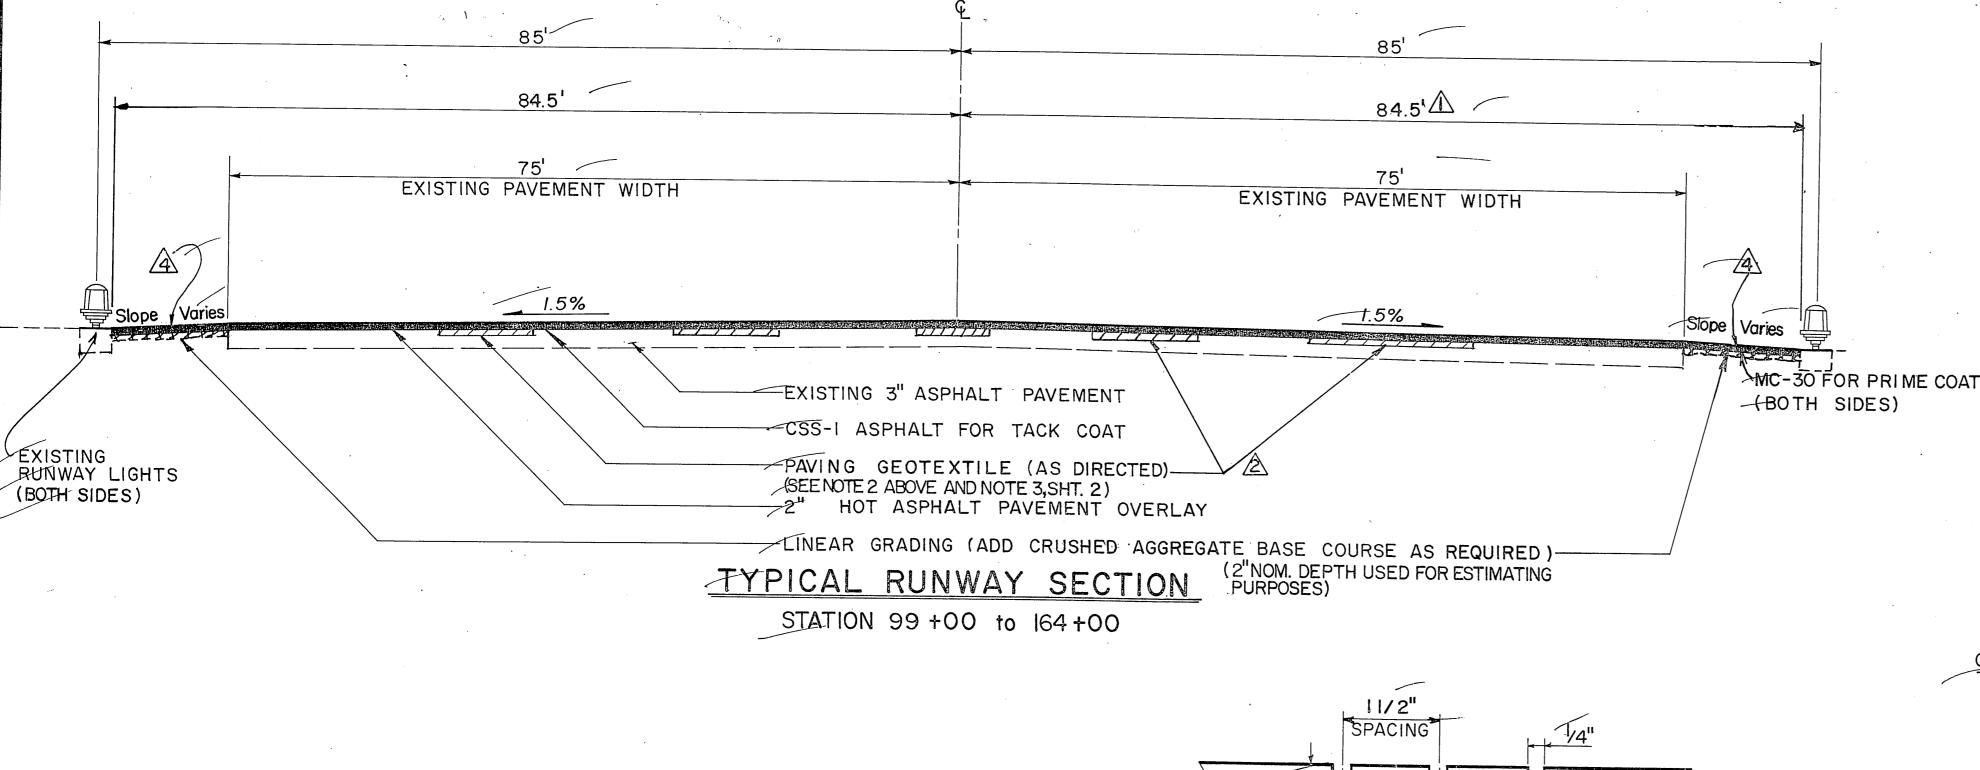

SPACING 1/4"


SEE SECTION 280 OF THE SPECIAL PROVISIONS AND CONSTRUCTION SPECIFICATIONS FOR DETAILS OF THE GROOVING OPERATION.

TYPICAL GROOVE SECTION

project no. 69612

TYPICAL SECTIONS


SITKA AIRPORT IMPROVEMENTS

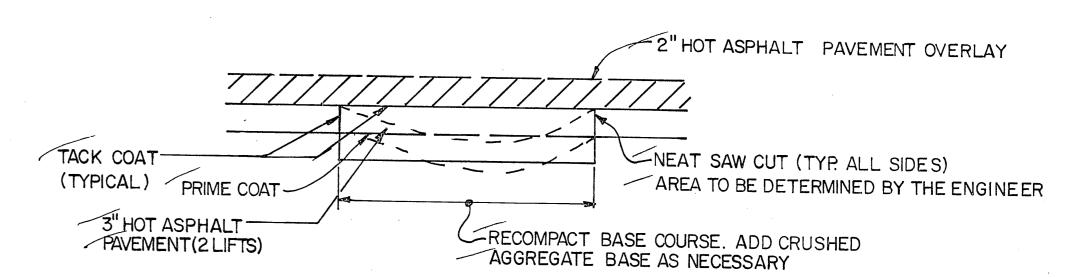


		
PAVEMENT REDAID DETAIL 5	SUMMA	RY OF
PAVEMENT REPAIR DETAIL 5	REPAIR	AREAS
	STATION	OFFSET
	1 38+5 €	1 1.5' RT .
146+00	150+00	3 8 ′ LT.
	1 60-30	150'RT.
	STATIONS AN	DOFFSET

ARE APPROXIMATE

Tracy W. Moore
CE 14932

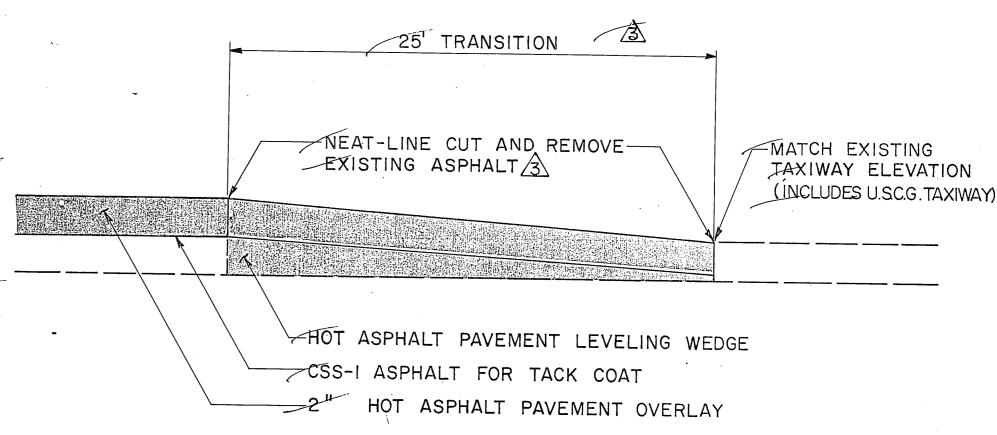


END PAVEMENT TRANSITION DETAIL

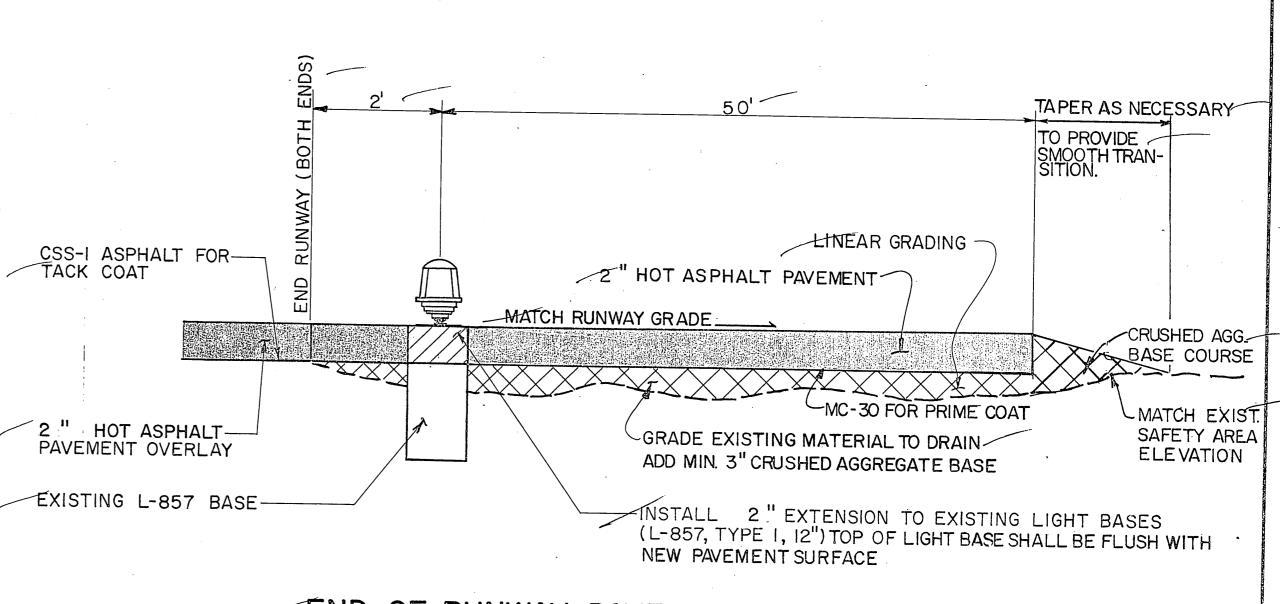



END OF RUNWAY PAVEMENT TRANSITION NO SCALE BOTH ENDS


APPROVED BY: 7-20-88	DESIGNED BY:	SCALE:
RECOMMENDED BY:	M. J. Coffey _	NONE
Dan W. Denny 7-20-88	DRAWN BY:	DATE:
PREPARED BY: DESIGN ENGINEER, GROUP "B" DATE	R.B.Snyder	6-30-88
Tran Moore Hotel all -	CHECKED BY:	CHEET 3 OF O
PROJECT MANAGER	T.W. Moore	SHEET 3 OF 8

	,		
			STATE OF ALASKA
			DEPARTMENT OF TRANSPORTATION
BY	DATE	DESCRIPTION OF CHANGE	8 PUBLIC FACILITIES
	l	ECORD OF REVISIONS	SOUTHEAST REGION DESIGN & CONSTRUCTION

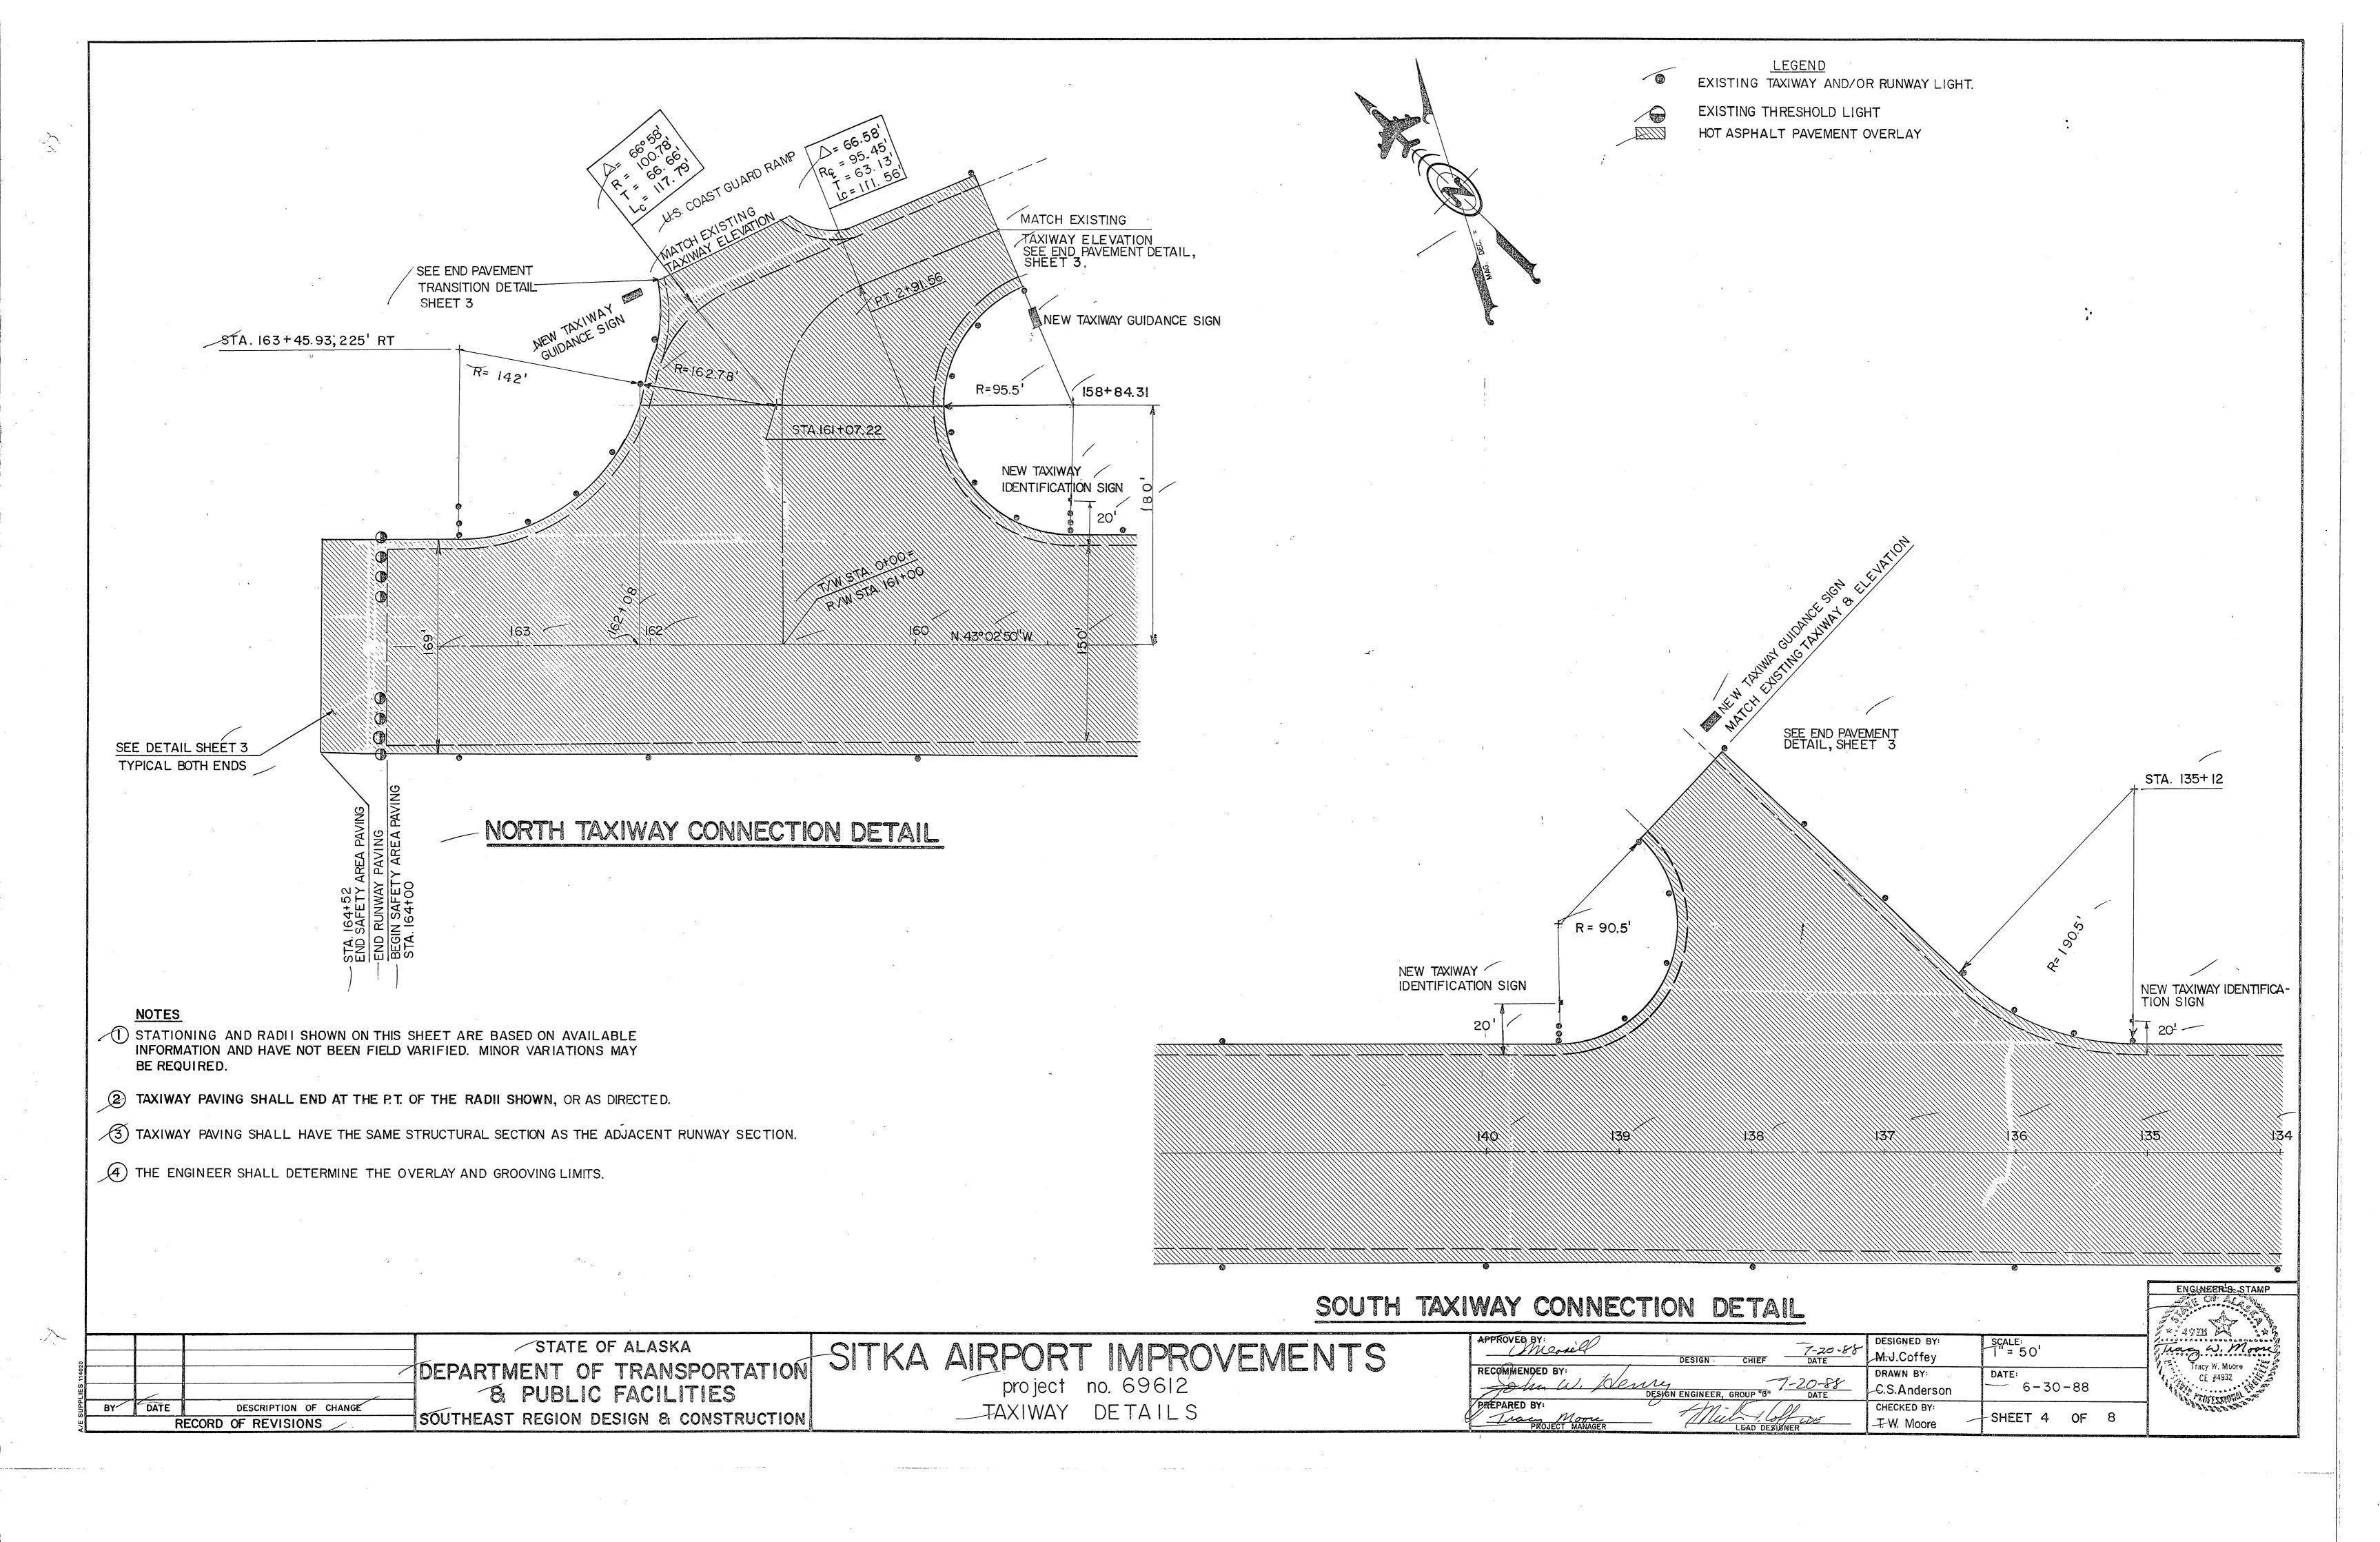


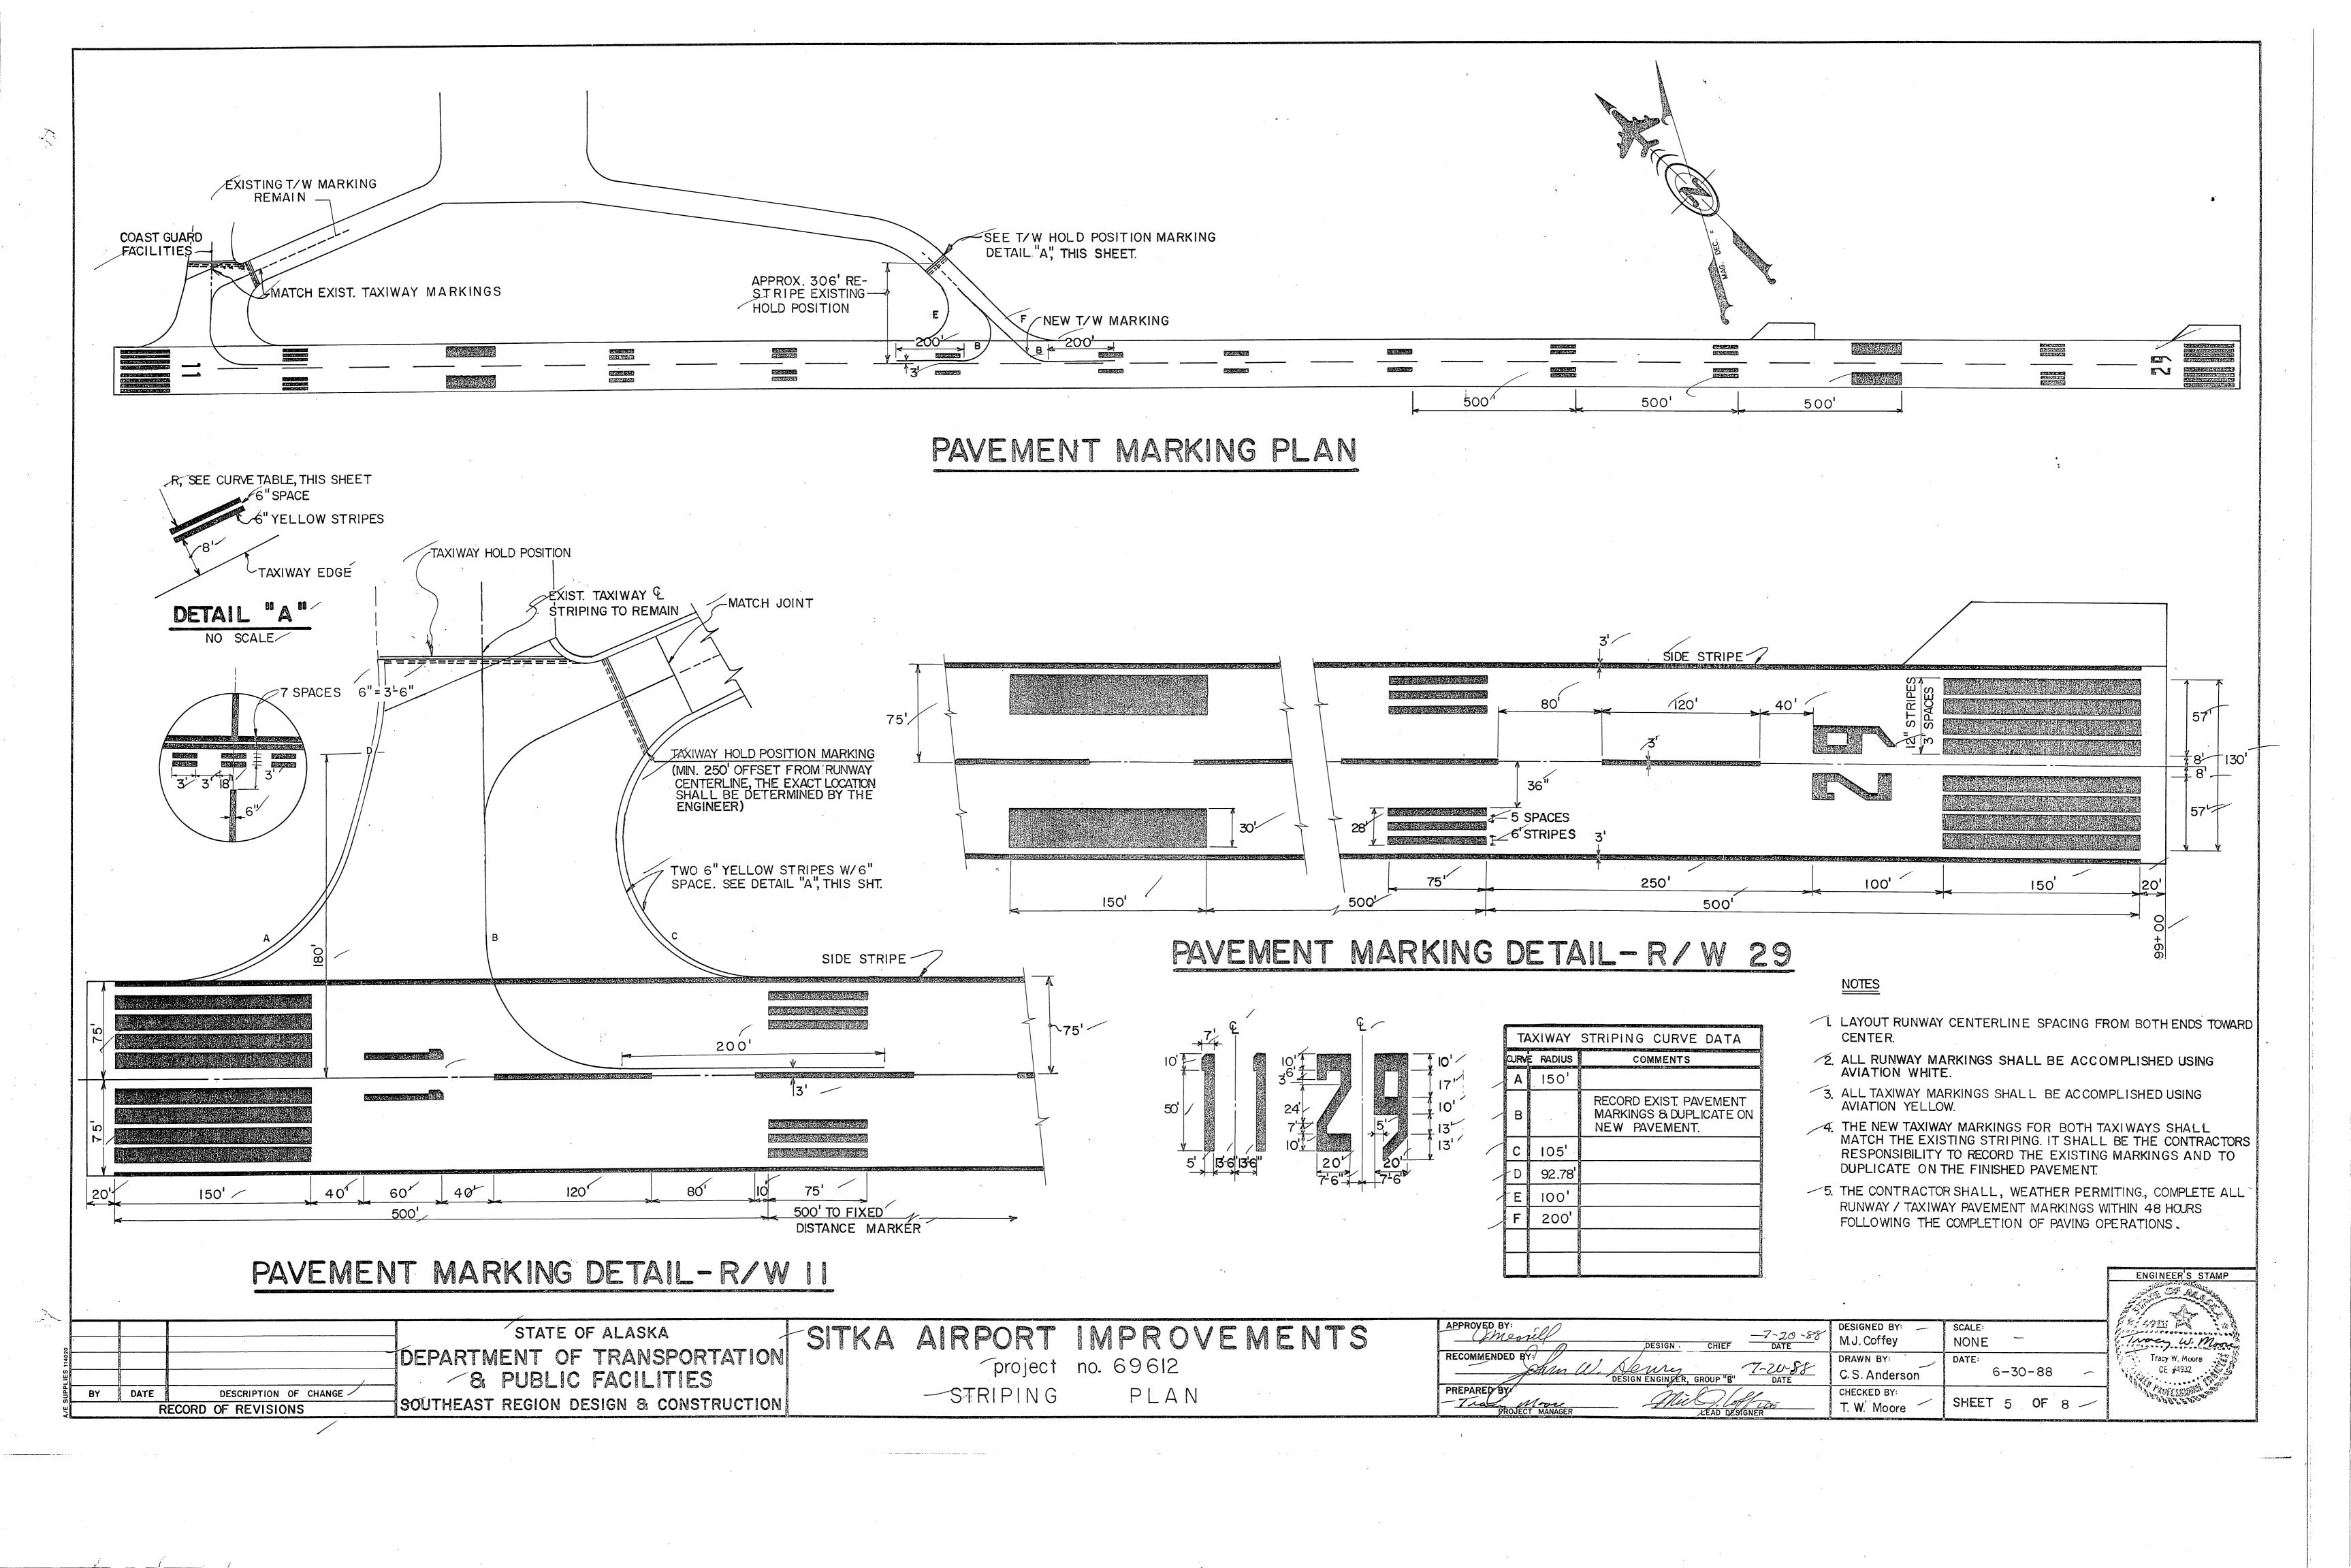

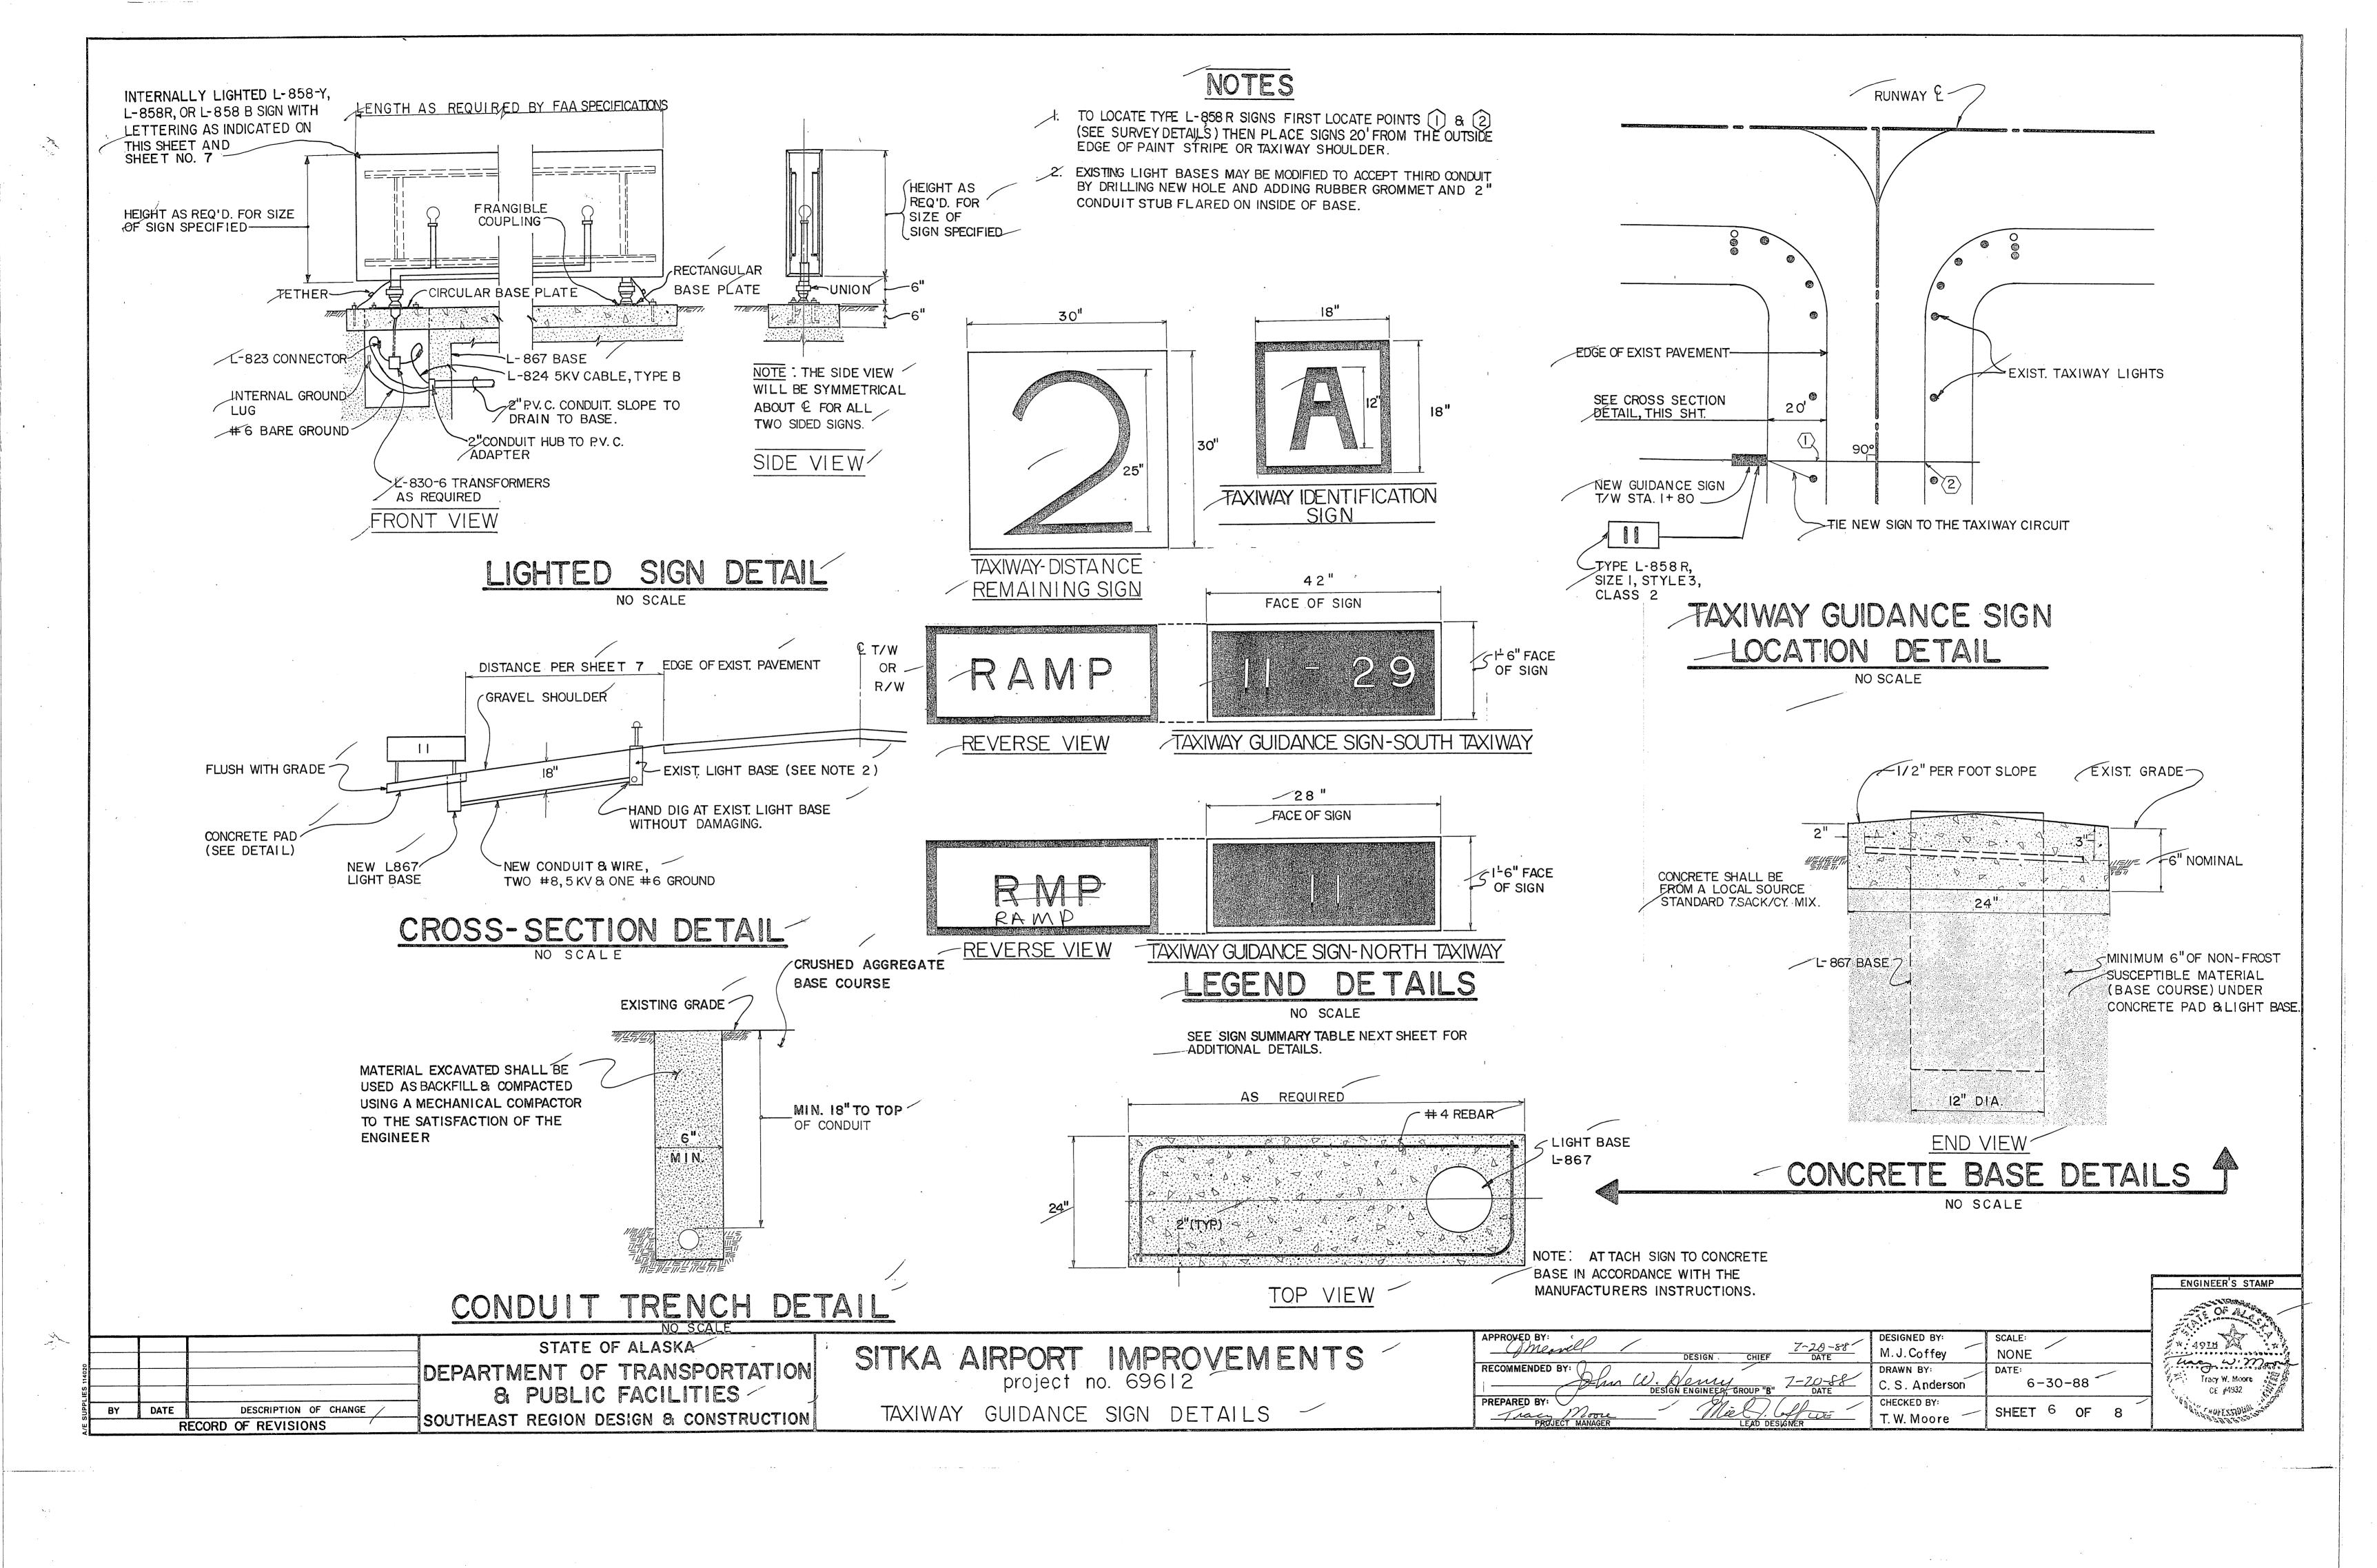

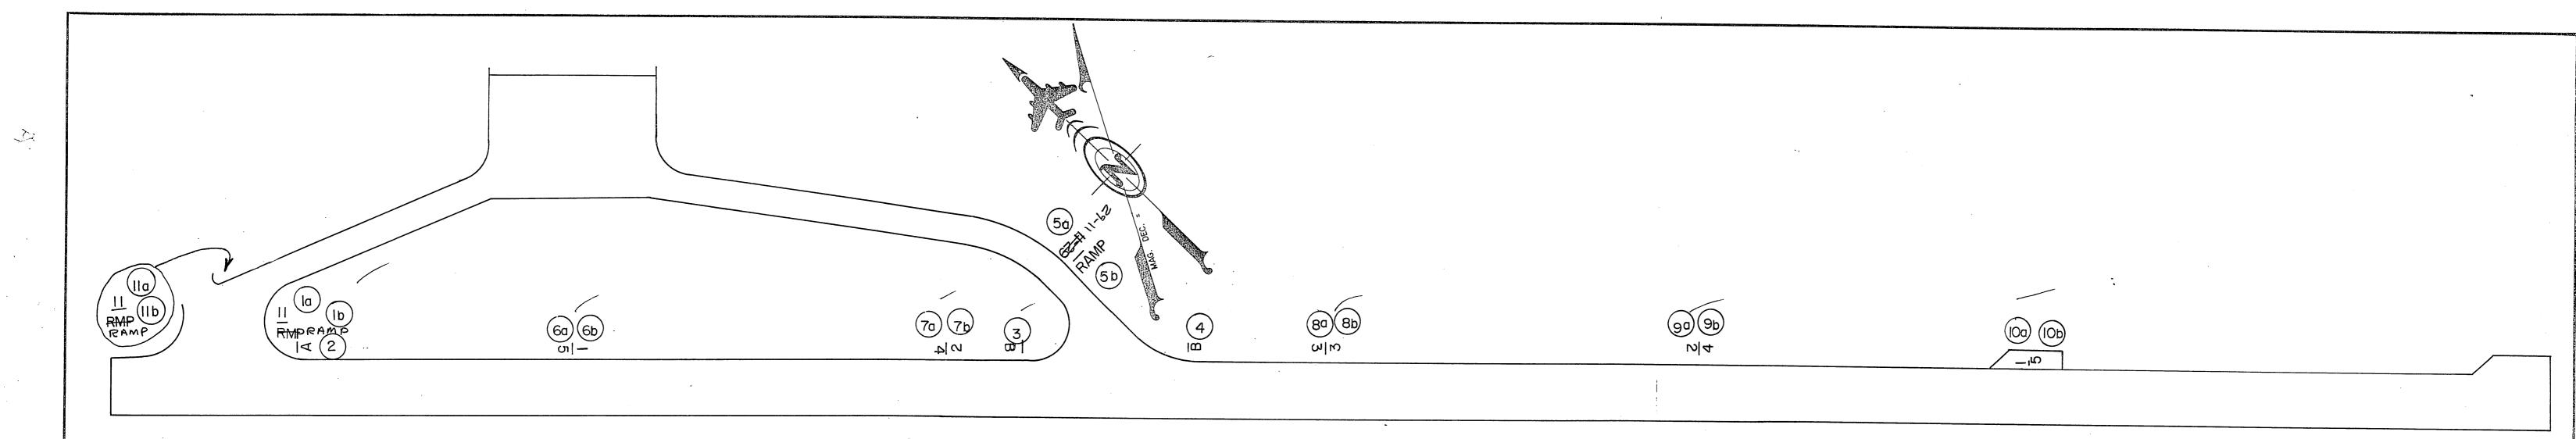

SIGNING PLAN

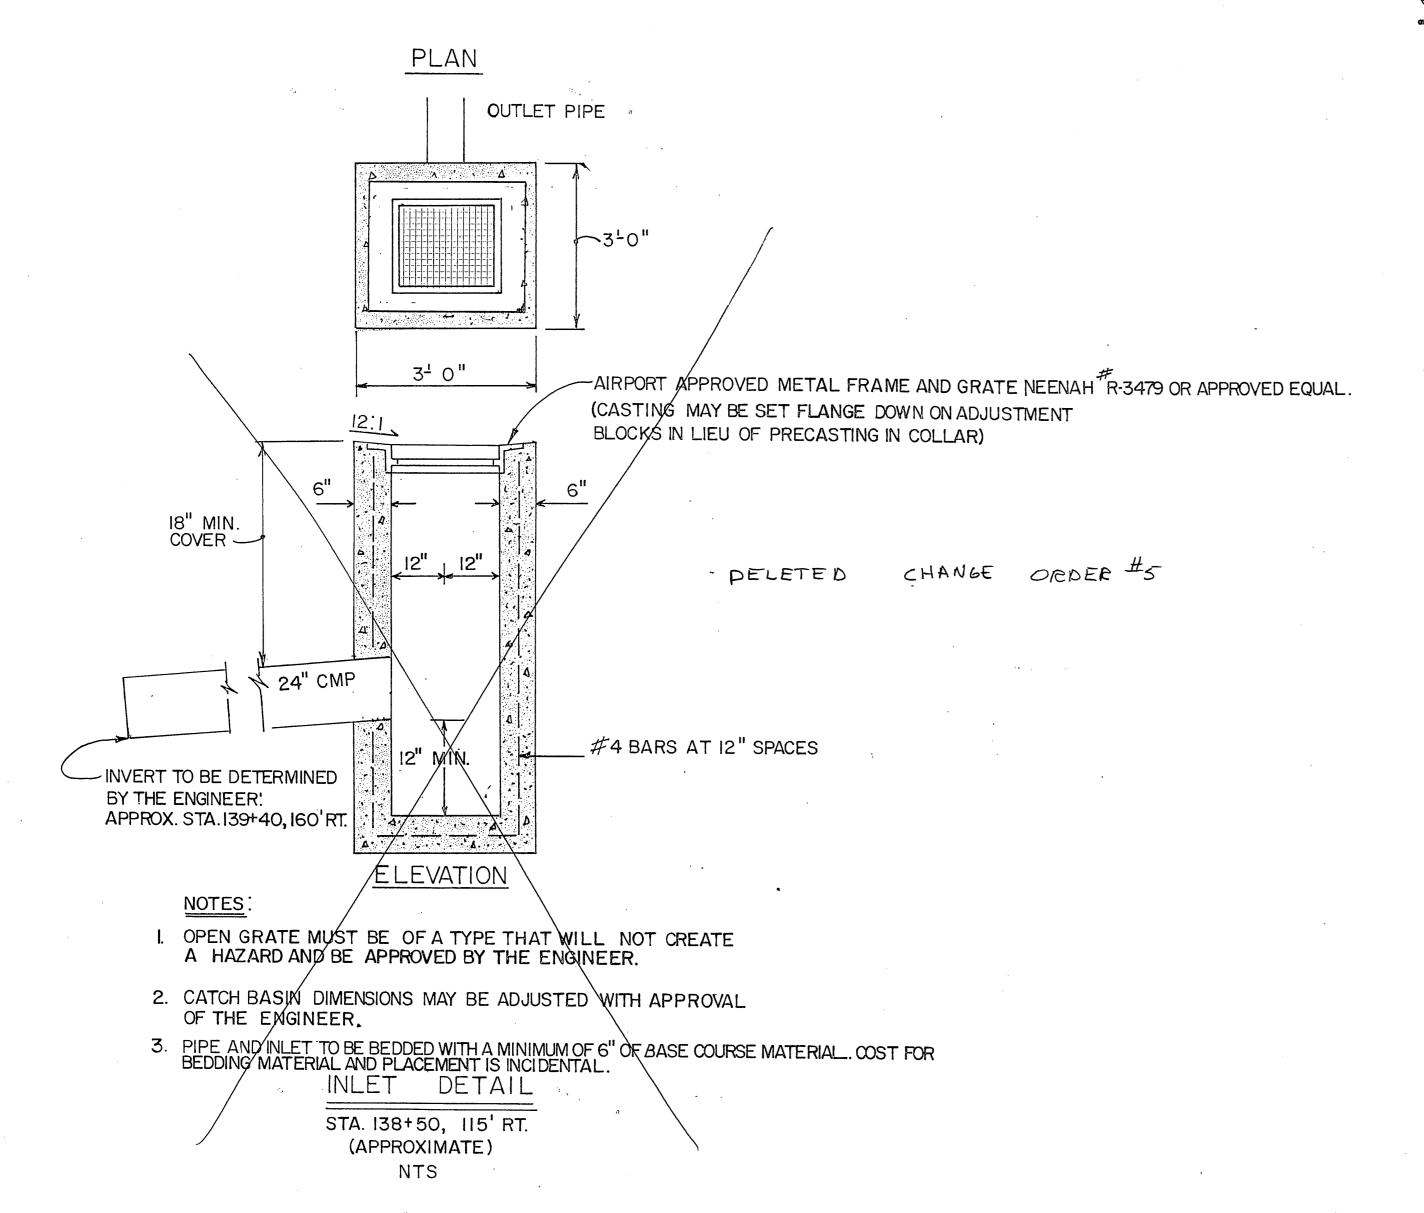

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							MM	AD\	
end Calcilla on the Common of the Angel					4		VIIVI		INFORMATION ONLY (USE CURRENT SIGN DESIGN SPECIFICATION
SIGN NO.	LEGEND	SIGN FACE SIZE	LETTER SIZE 8. COLOR	BACKGRND. COLOR	TYPEA	LEGEND .	STATION	R/W ^Q OFFSET	REMARKS
(1)a ~	11	28 X 18 /	12 WHITE	· · · · · · · · · · · · · · · · · · ·	M -	N.E.	T/W 1+80	204	
(i)b-	RMP	28 X 18 /	12"BLACK	YELLOW	- 1/	S. W.	T/W 1100	20 from exist. T/W shoulder	INSTALL PARALLEL TO T/W HOLD LINE
(2)	A -	18 X 18 -		YELLOW		S. W.	158+84/		INSTALL PARALLEL TO T/W HOLD LINE
(3)	В -	18 X 18 -	12"BLACK			N/	139+40	95' RT. /	
(4)	B ′	18 X 18 ,	12"BLACK	YELLOW	- /	s /	135+12	 	100
(5) a/	11-29	42 X 18 /	12"WHITE	RED 🚁	M /	N. E.	As directed	20'from exist	INSTALL PARALLEL TO T/W HOLD LINE
5 b	RAMP	42X 18 ~	12"BLACK	YELLOW	- 1/	S. W. /	As directed	17 W Shoulder	и и и и и и
6 a	5 ′	30 X 30 /	25"WHITE	BLACK	. /	N -	151+50	100'RT.	
(6) b		30 X 30	25"WHITE	BLACK	1/	s -		100'RT.	
7 0	4-	30 X 30 /	25"WHITE	BLACK	- =1/	N _	141+50	100'RT.	·
(7) b	2-	30 X 30/	25" WHITE	BLACK -	- 1/	S	142+00 141+50	100'RT. /	
(8) a	3-	30 X 30	25"WHITE	BLACK	- 1/	N	131+50	100' RT. ~	
(8) b	3 /	30 X 30	25"WHITE	BLACK	. 1	S	131+50	100' RT	
9 a	2/	30 X 30	25"WHITE	BLACK	1	N /	121+50	100' RT.	
9 b	4	30 X 30	25"WHITE	BLACK	1/	S ./	121+50	100' RT.	-
(10) a	1/		25"WHITE	BLACK -	1	N /	111+50	100' RT.	
(10) b	5 /	30 X 30 1			- 1/	s /	110100		
(II) a /	11	28 X 18 ~	12" WHITE		M	N			INSTALL PARALLEL TO HOLDLINE
(I) b	BMP	28 X 18	12" BLACK		- -		COAST GUARD		
							17 40 0.30		

ENGINEER'S STAMP

M = MANDATORY

I = INFORMATIONAL

			STATE OF ALASKA
			DEPARTMENT OF TRANSPORTATION
BY	DATE	DESCRIPTION OF CHANGE	- 8 PUBLIC FACILITIES / /
	RE	CORD OF REVISIONS	SOUTHEAST REGION DESIGN & CONSTRUCTION

SITKA AIRPORT IMPROVEMENTS

project no. 69612

INLET AND SIGN DETAIL SHEET

	APPROVED BY:			DESIGNED BY:	SCALE:				winds the state of the
	- marily	DESIGN CHIEF	7-20-88 DATE	M. J. Coffey	NONE		_		
ALCOHOLOGICAL CONTRACTOR CONTRACT	RECOMMENDED BY:	16/2	7 2 2 2 6	DRAWN BY:	DATÉ:	·		·	
		DESIGN ENGINEER, GROUP "B"	7-20-83 DATE	C. S. Anderson	6-	30-8	88		
A PROPERTY.	PREPARED BY	_ Meel. 6	off was	CHECKED BY:	SHEET	7	OF	8	
	PROJECT MANAGER	LEAD DESI	ØNER	T.W. Moore					_

