

DATE

REGIONAL PRECONSTRUCTION ENGINEER

DATE

AVIATION DESIGN SECTION CHIEF

DATE

PROJECT MANAGER

DATE

REGIONAL CONSTRUCTION ENGINEER

**DEPARTMENT OF TRANSPORTATION** AND PUBLIC FACILITIES **CENTRAL REGION** 4111 AVIATION AVE., ANCHORAGE ALASKA 99502 PHONE (907) 269-0590

NUNAPITCHUK AIRPORT NUNAPITCHUK, ALASKA NUNAPITCHUK AIRPORT IMPROVEMENTS

PROJECT No. CFAPT00427

AIP No. 3-02-0446-00X-20XX

VICINITY MAP

06/27/2019

SHEET: TITLE, SIGNATURES, LOCATION MAP AND

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PROJECT DRAW	INGS	PROJECT DR	AWINGS	APPENDIX DRAWINGS		
SHEET TITLE	SHEET NO.	SHEET TITLE	SHEET NO.	SHEET TITLE	SHEET NO.	
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				CULVERT PIPE & ARCH INSTALLATION DETAILS	D-01.02	
				PIPE AND ARCH TABLES	D-04.21	
				CULVERT END SECTION	D-06.10	
				CULVERT MARKER POSTS	D-09.00	
				SIGN FRAMING AND POST SPACING	S-00.11	
				BRACING FOR SIGNS MOUNTED ON SINGLE POST	S-01.01	

STATE OF				STANTEC CONSULTING SERVICES INC.
DEPARTMENT OF TR				725 EAST FIREWEED LANE. SUITE 200
				ANCHORAGE, AK 99503-2245
CENTRAL F				(907) 276-4245
4111 AVIATION AVE., ANCH				CERTIFICATE OF AUTHORIZATION #
PHONE (907)	REVISION	DATE	BY	126386

SHEET TITLE	SHEET NU.	
CULVERT PIPE & ARCH INSTALLATION DETAILS	D-01.02	
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OF ALASKA
<b>TRANSPORTATION</b>
IC FACILITIES
AL REGION
NCHORAGE ALASKA 99502
907) 269-0590

NUNAPITCHUK AIRPORT NUNAPITCHUK, ALASKA NUNAPITCHUK AIRPORT IMPROVEMENTS PROJECT No. CFAPT00427 AIP No. 3-02-0446-00X-20XX INDEX

ATE:

06/27/2019 SHEET:

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LEGEND	LEGEND	ABBREVIATIONS
DESCRIPTION EXISTING PROPOSED	DESCRIPTION EXISTING PR	OPOSED
DESCRIPTION     EXISTING     PROPOSED       RULARD     0     0       AULDING     0     0       JULARINO LIMITS     0     0       JULARINO LIMITS     0     0       JULARINO LIMITS     0     0       JULARINO LIMITS     0     0       JULARINO ELMITS     0     0       ILCTIRICAL PEDALSTAL     23     0       ILS SUPE LIMITS     0     0       JANOR CONTOUR	TAXIWAY LIGHT TAXIWAY OBJECT FREE AREATOFA TAXIWAY SAFETY AREATSA THRESHOLD LIGHT UTILITY POLE WATER EDGE WIND CONE	OPOSED     16.     NUMPTCHUK ARPORT     KIN     MERUKU       AP     ARPORT IMPROVEMENT PROJECT     KIRL     MERUKU MEDISTY RUMMAY LIGHTIM       BOP     BECKINNE OF PROJECT     NUL     MERUKU MEDISTY RUMMAY LIGHTIM       BPG     BECKIN VERTICAL CURVE STATION     NO     NORTH AMERICAN DETICAL       BPGC     CRIST VERTICAL CURVE STATION     NO     NORTH AMERICAN RETUCAL DURY       CV     CURVE RETURNE     NORTH AMERICAN RETUCAL DURY     NORTH AMERICAN RETUCAL DURY       CV     CURVERTANCE     CORRECATE SUFFACE COURSE     NTP     NORTH AMERICAN RETUCAL DURY       CV     CURVERTANCE     CORRECATE SUFFACE COURSE     NTP     NORT N AMERICAN RETUCAL DURY       CV     CURVERTANCE     CORRECATE SUFFACE COURSE     NTP     NORT N AMERICAN RETURNE AT RUMAY SUFFACE       CV     CURVE CORRECATE SUFFACE     OR     OR     NORT N AMERICAN RETURNE AT RUMAY SUFFACE       CV     CURVERTANCE TRANSFORTION & PUBLIC FACILITIES     PC     ORACH PERTURNET OF RUMAY SUFFACE       CV     CURVERTANCE UNERSPECTION & PUBLIC FACILITIES     PC     PORT OF VERTICAL UNIT CONCRETE       E     EAST/LOSTING     RUMAY SUFFACE     PORT OF VERTICAL UNIT CONCRETE       E     EAST/LOSTING     RUMAY SUFFACE     PORT OF VERTICAL UNIT CONTROL PLAN       E     EXAT/LOSTING     RUMAY SUFFACE     PORT
	STANTEC CONSULTING SERVICES INC.	STATE OF ALASKA NUNAPITCHUK AIRPORT DATE: DEPARTMENT OF TRANSPORTATION NUMAPITCHUK, ALASKA 06/27

AT	E		

# **ESTIMATED QUANTITIES**

No.	ITEM	UNIT	QTY	No.	ITEM	UNIT	QTY	No.	
D701.010.0036	CS PIPE, 36-INCH	LF	160	L125.030.0000	MEDIUM INTENSITY RUNWAY EDGE AND THRESHOLD LIGHT, L-861 AND L-861E	EACH	36		
G100.010.0000	MOBILIZATION AND DEMOBILIZATION	LS	ALL REQ'D	125.040.0000	TAXIWAY EDGE LIGHT, L-861T	EACH	32		
G115.010.0000	WORKER MEALS AND LODGING, OR PER DIEM	LS	ALL REQ'D						
G130.010.0000	FIELD OFFICE	LS	ALL REQ'D		REMOVE RUNWAY AND TAXIWAY LIGHT	EACH	70		
G130.020.0000	FIELD LABORATORY	LS	ALL REQ'D		HANDHOLE, L-867, SIZE B	EACH	6		
G130.060.0000	NUCLEAR TESTING EQUIPMENT STORAGE SHED	EACH	1		JUNCTION BOX, TYPE II	EACH	5		
G130.090.0000	ENGINEERING COMMUNICATIONS	CS	ALL REQ'D	L125.170.0000		CS	All REQ'D		
G131.010.0000	ENGINEERING TRANSPORTATION (TRUCK)	EACH	2	L125.400.0000	ADJUST HANDHOLE	EACH	8		
G131.020.0000	ENGINEERING TRANSPORTATION (ATV)	EACH	1	P151.010.0000	CLEARING	ACRE	6		
G135.010.0000	CONSTRUCTION SURVEYING BY THE CONTRACTOR	LS	ALL REQ'D	P152.010.0000	UNCLASSIFIED EXCAVATION	CY	2,700		
G135.020.0000	EXTRA THREE PERSON SURVEY PARTY	HR	80	P152.200.0000	BORROW	TON	12,700		
G300.010.0000	CPM SCHEDULING	LS	ALL REQ'D	P167.010.0000	DUST PALLIATIVE	SY	51,100		
	AIRPORT FLAGGER	CS	ALL REQ'D	P299.020.0000	CRUSHED AGGREGATE SURFACE COURSE	TON	20,800		
	HIGHWAY TRAFFIC MAINTENANCE	LS	ALL REQ'D	P640.020.0000	SEGMENTED CIRCLE (PANEL-TYPE)	LS	ALL REQ'D		
	ROTATING BEACON, MEDIUM INTENSITY, L-801A	EACH	ALL ILLO D	P641.010.0000	EROSION, SEDIMENT, AND POLLUTION CONTROL ADMINISTRATION	LS	ALL REQ'D		
			·	P641.030.0000	TEMPORARY EROSION, SEDIMENT, AND POLLUTION	LS	ALL REQ'D		
	30-FEET HINGED POLE BEACON TOWER	EACH	1	D641.040.0000	TEMPORARY EROSION, SEDIMENT, AND POLLUTION	05			
	8-FEET LIGHTED WIND CONE, IN PLACE UNDERGROUND CABLE #8 AWG, COPPER, 5KV FAA TYPE	EACH	1	P641.040.0000	CONTROL ADDITIVES	CS	ALL REQ'D		
L108.010.2008	C, L-824	LF	7,300	P641.060.0000	WITHHOLDING	CS	ALL REQ'D		
L108.030.0006	#6 BARE COPPER GROUND CONDUCTOR	LF	7,400	P641.070.0000	SWPPP MANAGER	LS	ALL REQ'D		
L108.050.1008	UNDERGROUND CABLE #8 AWG, COPPER, 600V, TYPE C, L-824	LF	1,200	P650.020.0000	SOIL ANCHOR TIE-DOWN	SET	2		
L108.070.0000		EACH	11	P660.030.0000	REFLECTIVE MARKER, TYPE II	EACH	26		E
L109.040.0000	INSTALLATION OF ELECTRICAL EQUIPMENT IN NEW OR	EACH	1	P661.020.0000	STANDARD SIGN	EACH	1		
	EXISTING STRUCTURE			T901.020.0000	SEEDING	LB	135	No.	IT
L110.030.1002	RIGID STEEL CONDUIT, 2-INCH	LF	90					P-152	BOR
L110.080.1002	HDPE CONDUIT, 2-INCH	LF	7,480					P-299	CRUS
L125.020.0000	REGULATOR, L-828	EACH	1					T-901	SEED

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Date Revised: -ayout Name:

STANTEC CONSULTING SERVICES INC.				STATE OF
725 EAST FIREWEED LANE, SUITE 200				DEPARTMENT OF 1
ANCHORAGE, AK 99503-2245				AND PUBLIC
(907) 276-4245				CENTRAL
CERTIFICATE OF AUTHORIZATION #				4111 AVIATION AVE., AND
126386	BY	DATE	REVISION	PHONE (907

Т	Е	Μ

# **ESTIMATING FACTORS**

# ITEM

# FACTOR

### ORROW

RUSHED AGGREGATE SURFACE COURSE

EEDING


1.85 TON/CY 1.96 TON/CY

1	LB/1000	SF

NUNAPITCHUK AIRPORT NUNAPITCHUK, ALASKA NUNAPITCHUK AIRPORT IMPROVEMENTS PROJECT No. CFAPT00427 AIP No. 3-02-0446-00X-20XX ESTIMATED QUANTITIES

06/27/2019

SHEET: 4 OF 28

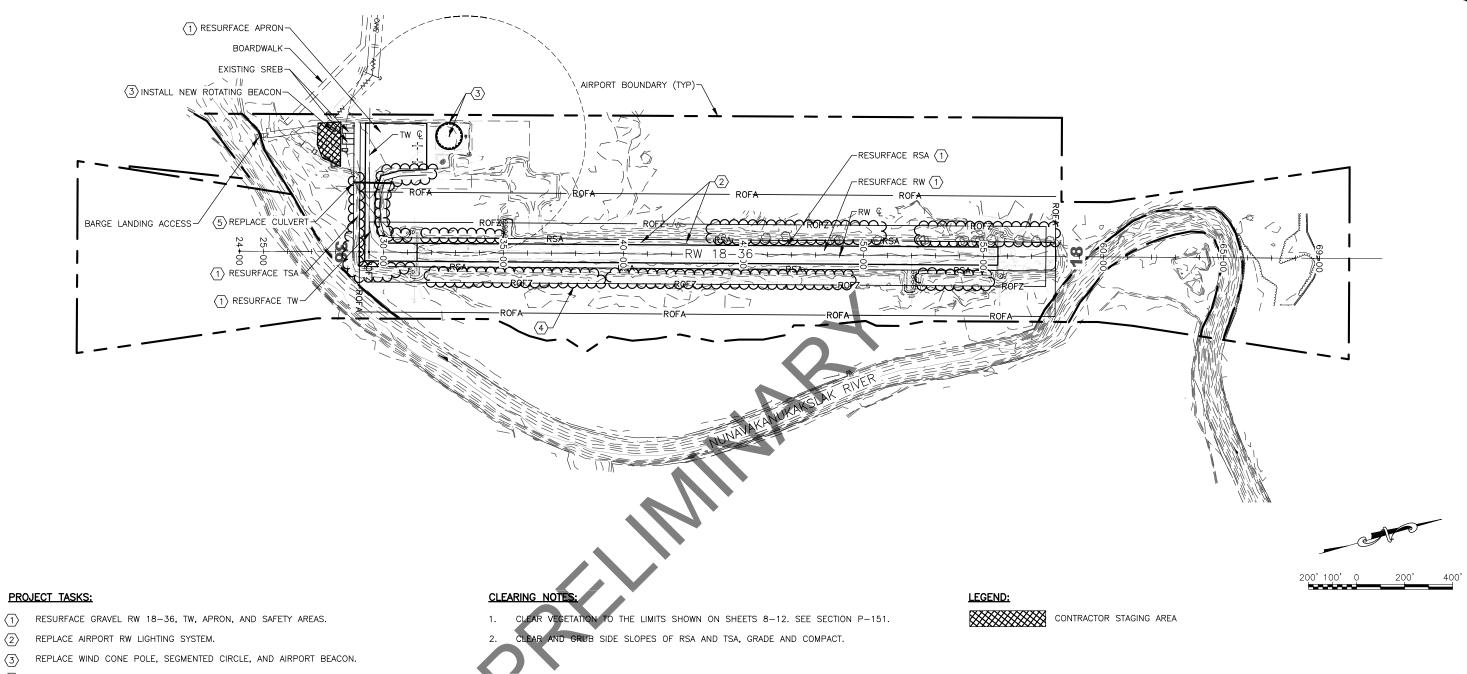

 $\langle 4 \rangle$  CLEAR VEGETATION.

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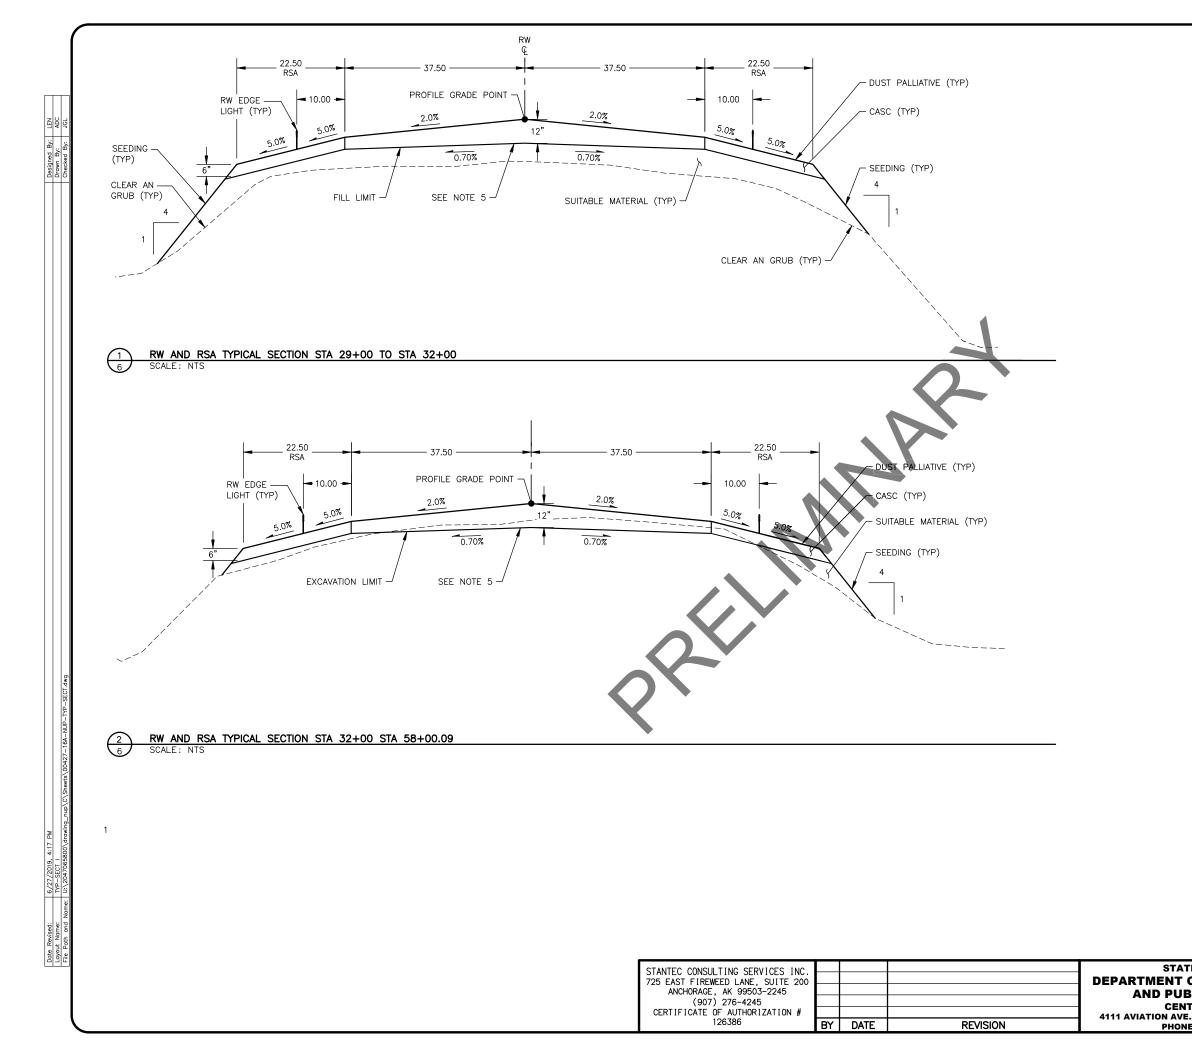
5 REPLACE CULVERT.

STANTEC CONSULTING SERVICES INC 725 EAST FIREWEED LANE, SUITE 200 ANCHORAGE, AK 99503-2245 (907) 276-4245				STATE OF AI DEPARTMENT OF TR AND PUBLIC F
CERTIFICATE OF AUTHORIZATION # 126386	BY	DATE	REVISION	CENTRAL RI 4111 AVIATION AVE., ANCHO PHONE (907) 2

ALASKA	NUNAPITCHUK AIRPORT	DATE:
RANSPORTATION	NUNAPITCHUK, ALASKA NUNAPITCHUK AIRPORT IMPROVEMENTS	06/2
FACILITIES	PROJECT No. CFAPT00427	SHEET:
REGION	AIP No. 3-02-0446-00X-20XX	
IORAGE ALASKA 99502 269-0590	PROJECT LAYOUT PLAN	5

/27/2019

of **28** 



### TYPICAL SECTION NOTES:


- 1. CLEAR AND GRUB ALL SIDE SLOPES PRIOR TO REGRADING.
- 2. SEE GRADING SHEETS FOR LAYOUT AND DEFINITION OF VARIABLE DIMENSIONS SHOWN ON THE TYPICAL SECTIONS.
- 3. APPLY DUST PALLIATIVE TO ALL NEW CASC SURFACES, AND AS DIRECTED.
- 4. APPLY SEEDING TO ALL NEW SOIL SLOPES AND OTHER AREAS OF SOIL DISTURBANCE THAT REQUIRE STABILIZATION, AND AS DIRECTED.
- 5. THE CASC LAYER ON THE RW TYPICAL SECTION VARIES IN THICKNESS FROM 12 INCHES AT THE CENTERLINE, TO 6 INCHES THICK AT 37.5 FEET LEFT AND RIGHT. THE SURFACE CROSS SLOPE IS MAINTAINED AT 2.00%, AND THE SUBGRADE CROSS SLOPE IS MAINTAINED AT 0.70% AS SHOWN.
- 6. THE EDGE OF THE TW SAFETY AREA (TSA) MAINTAINS A CONSTANT WIDTH OF 22 FEET AS MEASURED FROM THE EDGE OF TW. SEE PLAN VIEW FOR LAYOUT OF THE TW EDGE TAPERS AND GRADING POINTS.

### NUNAPITCHUK AIRPORT NUNAPITCHUK, ALASKA NUNAPITCHUK AIRPORT IMPROVEMENTS PROJECT NO. CFAPTO0427 AIP NO. 3-02-0446-00X-20XX TYPICAL SECTIONS I

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SHEET:

06/27/2019

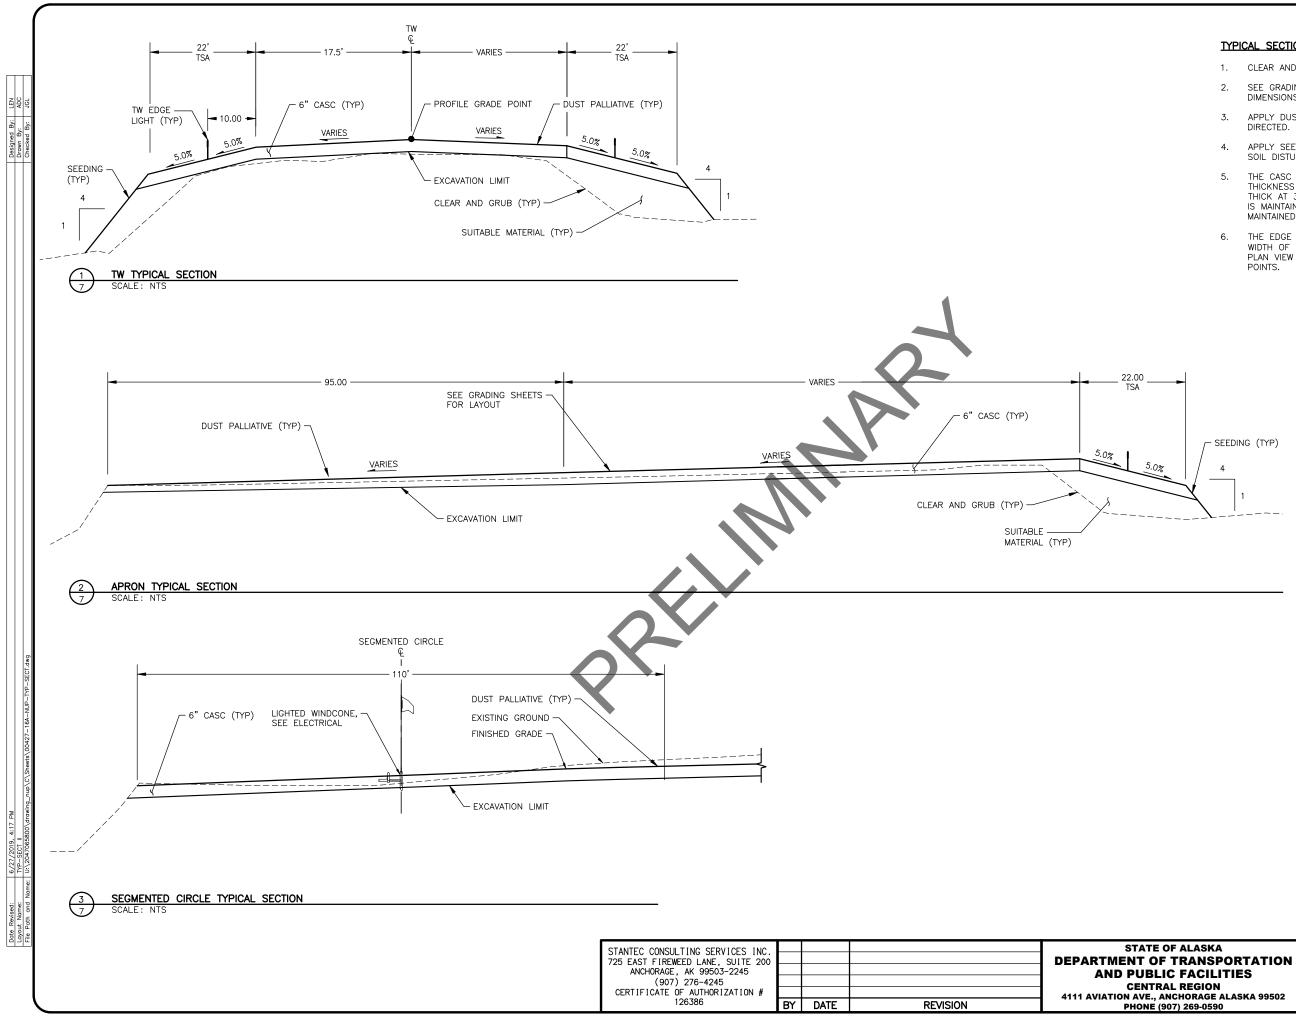

### TYPICAL SECTION NOTES:


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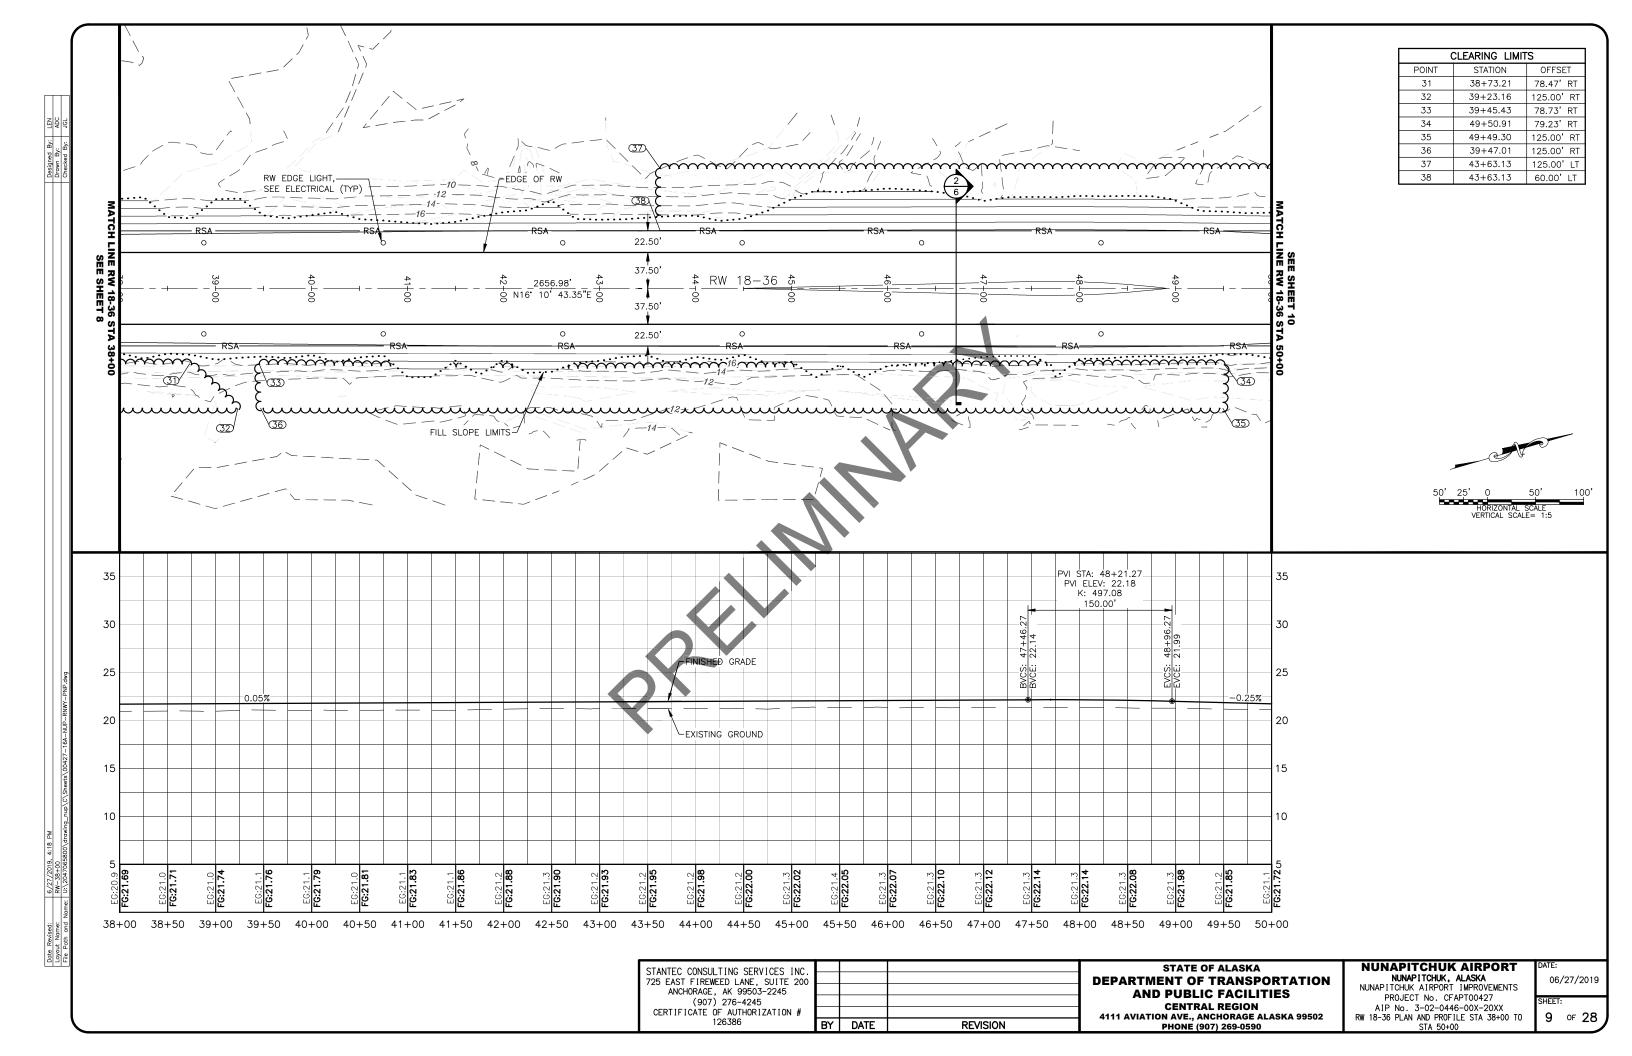
### NUNAPITCHUK AIRPORT NUNAPITCHUK, ALASKA NUNAPITCHUK AIRPORT IMPROVEMENTS PROJECT No. CFAPT00427 AIP No. 3-02-0446-00X-20XX TYPICAL SECTIONS II


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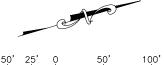
06/27/2019





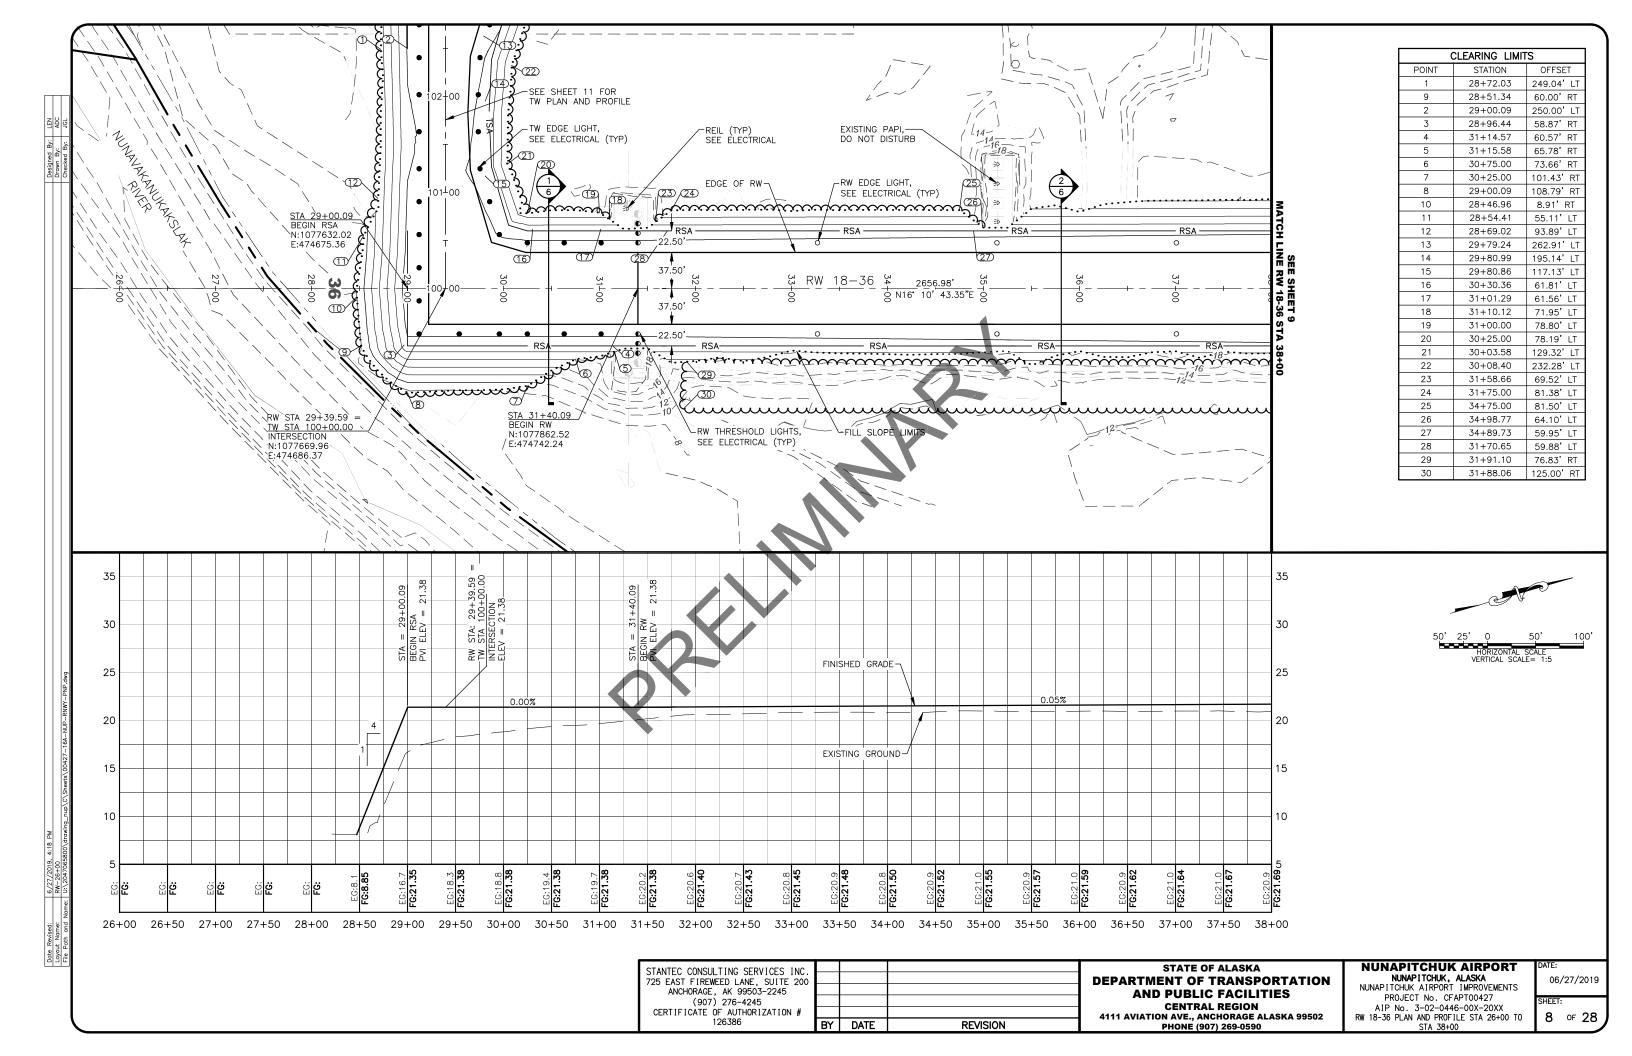

CLEARING LIMITS						
POINT	STATION	OFFSET				
39	50+74.53	125.00' LT				
40	50+74.53	64.80'LT				
41	52+31.05	125.00' LT				
42	57+99.55	125.00' LT				
43	58+00.09	60.00' LT				
44	52+31.05	56.59'LT				
45	52+30.06	74.40' RT				
46	52+73.60	67.19'RT				
47	53+19.83	74.35' RT				
48	55+20.28	76.76'RT				
49	55+31.01	125.00' RT				
50	52+38.38	125.00' RT				

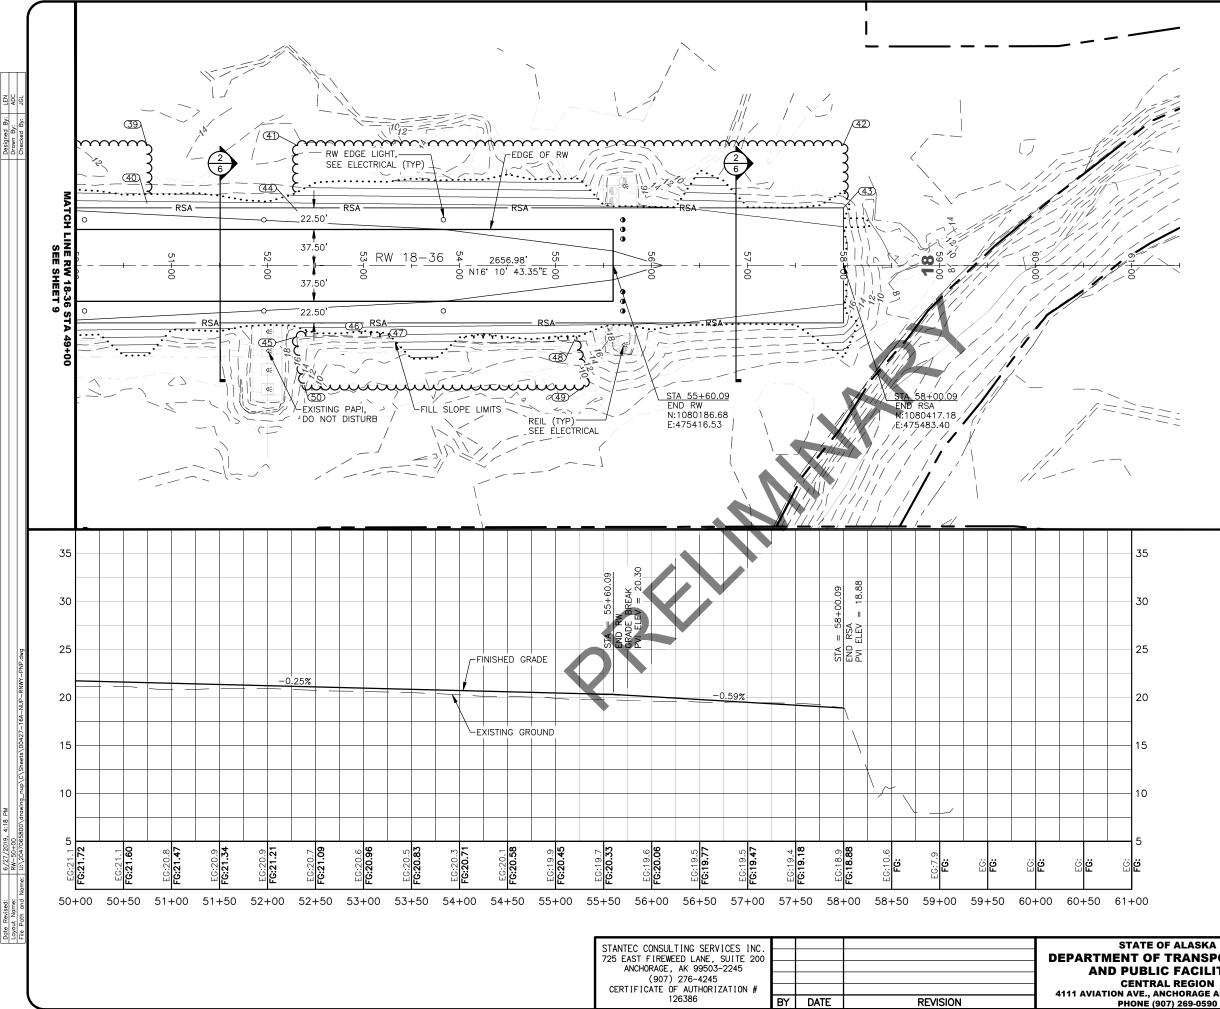



**DEPARTMENT OF TRANSPORTATION** AND PUBLIC FACILITIES **CENTRAL REGION** 4111 AVIATION AVE., ANCHORAGE ALASKA 99502 PHONE (907) 269-0590


NUNAPITCHUK AIRPORT NUNAPITCHUK, ALASKA NUNAPITCHUK AIRPORT IMPROVEMENTS PROJECT No. CFAPT00427 AIP No. 3-02-0446-00X-22XX


RW 18-36 PLAN AND PROFILE STA 50+00 TO STA 61+00


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E ADC


Designed By: Drawn By:

NUNAPITCHUK AIRPORT NUNAPITCHUK, ALASKA NUNAPITCHUK AIRPORT IMPROVEMENTS PROJECT No. CFAPT00427 AIP No. 3-02-0446-00X-20XX SEGMENTED CIRCLE DETAIL I

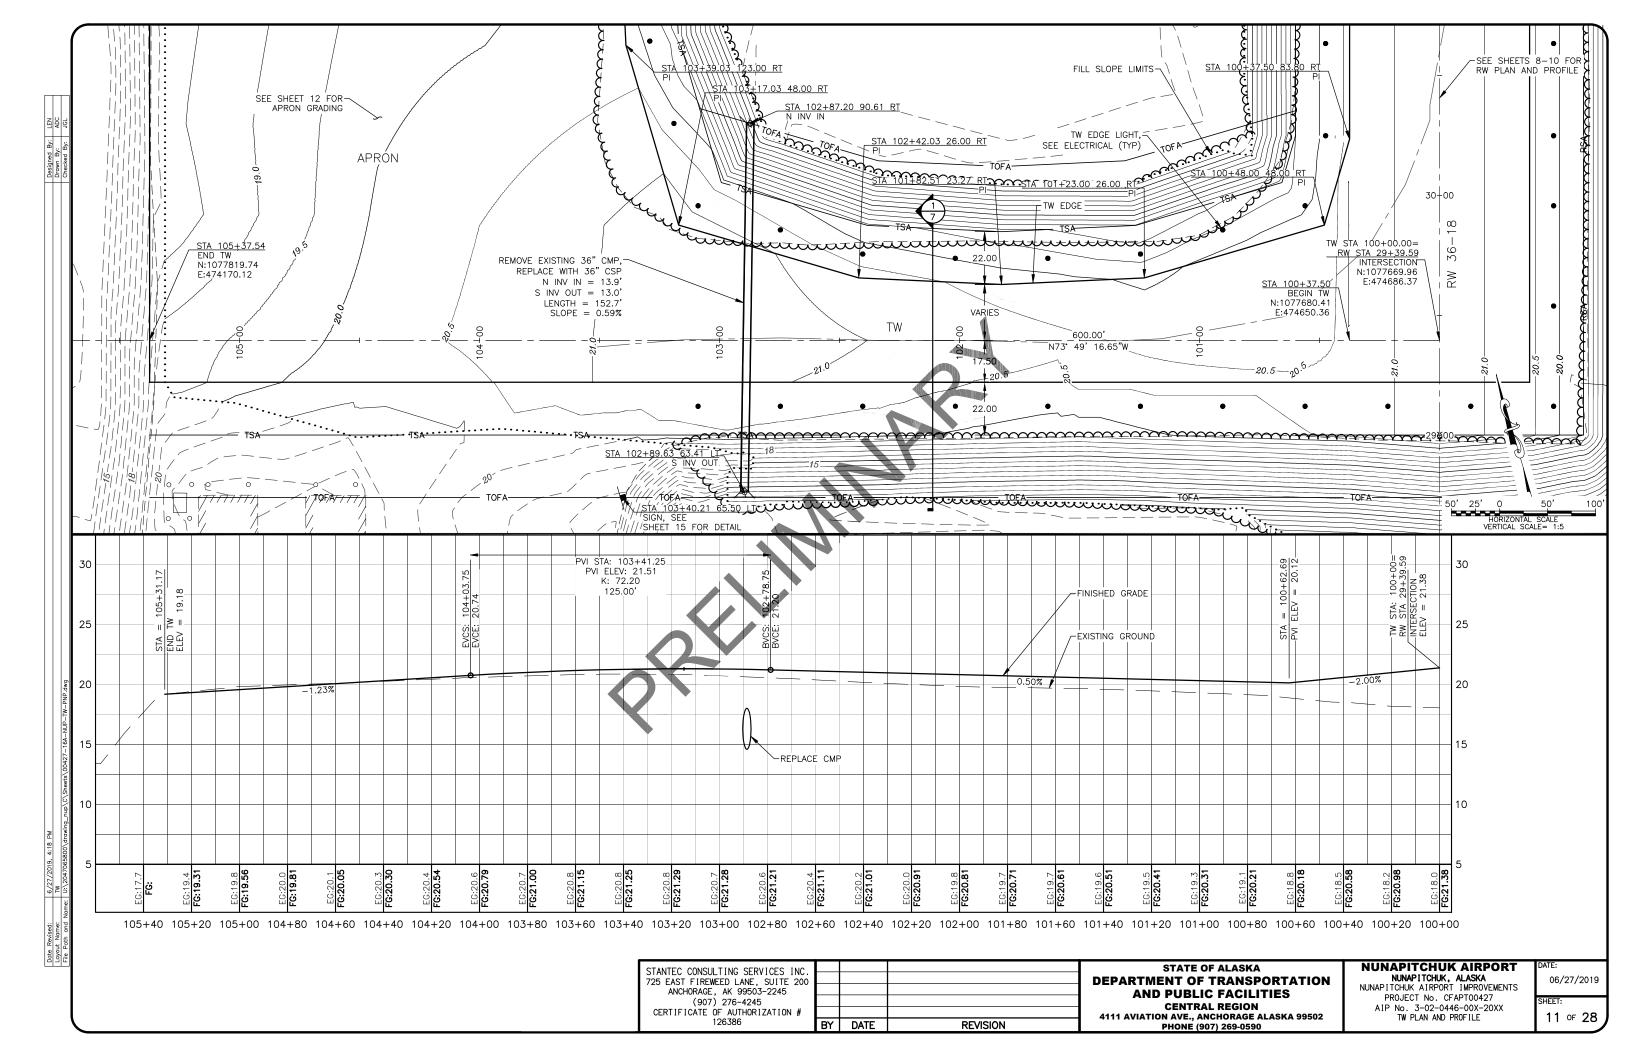SHEET:

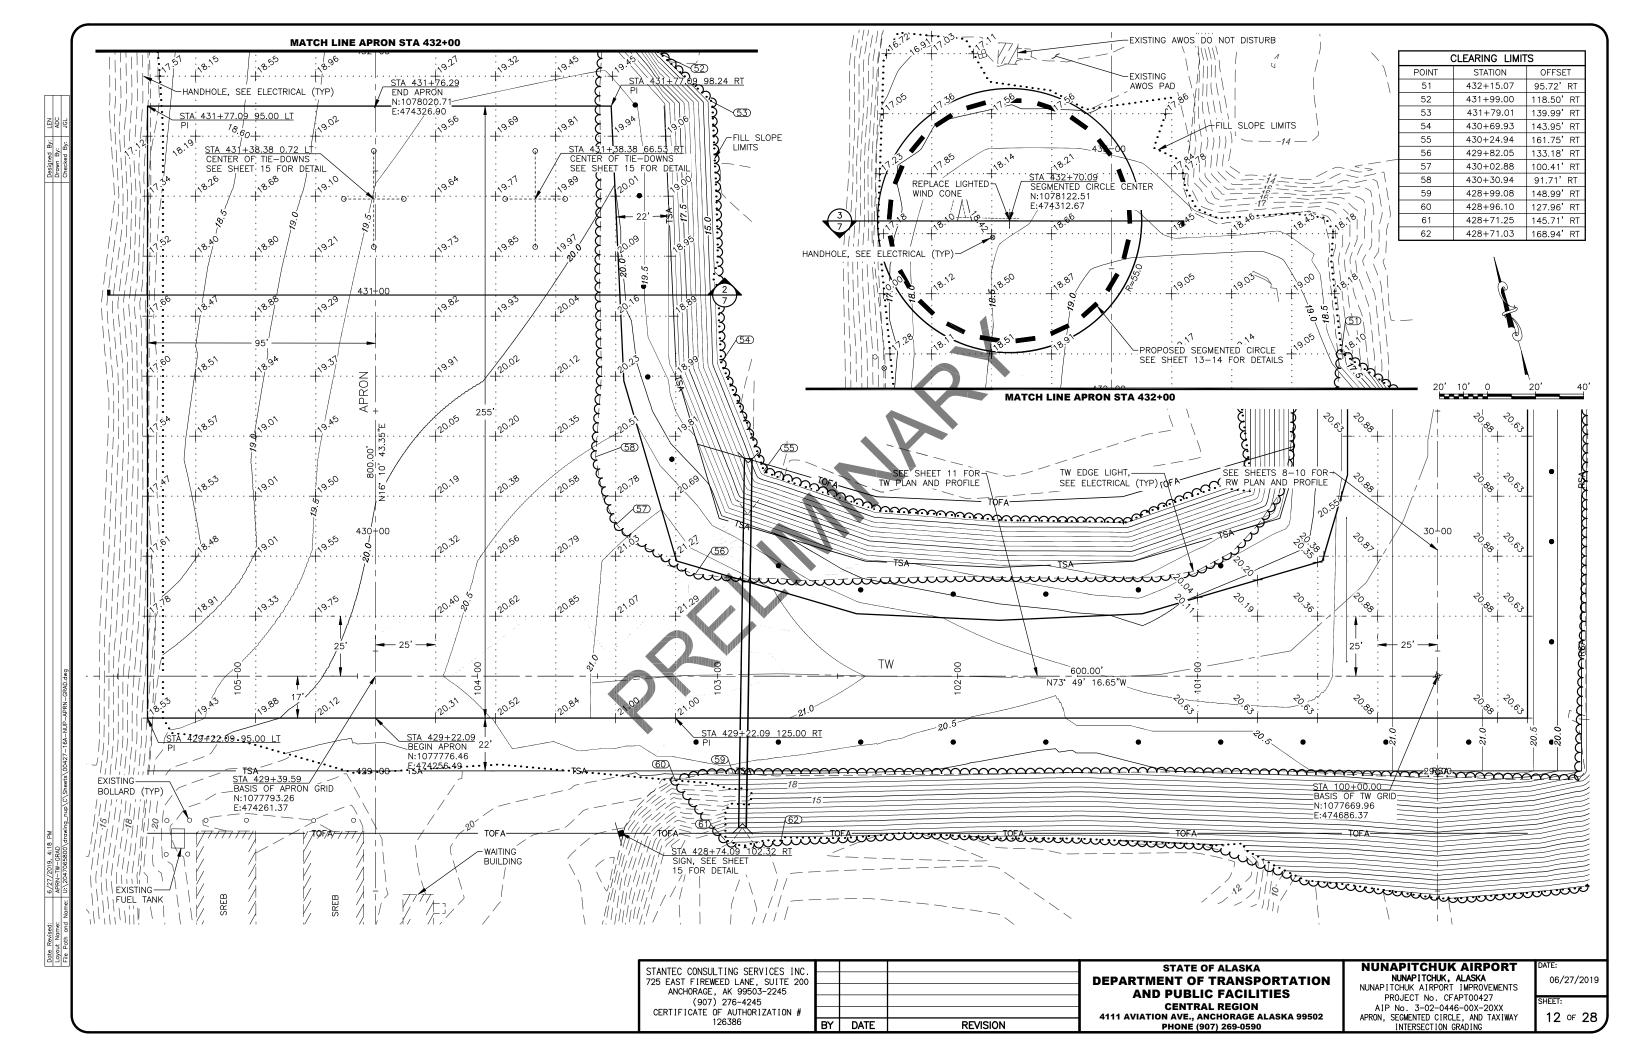06/27/2019
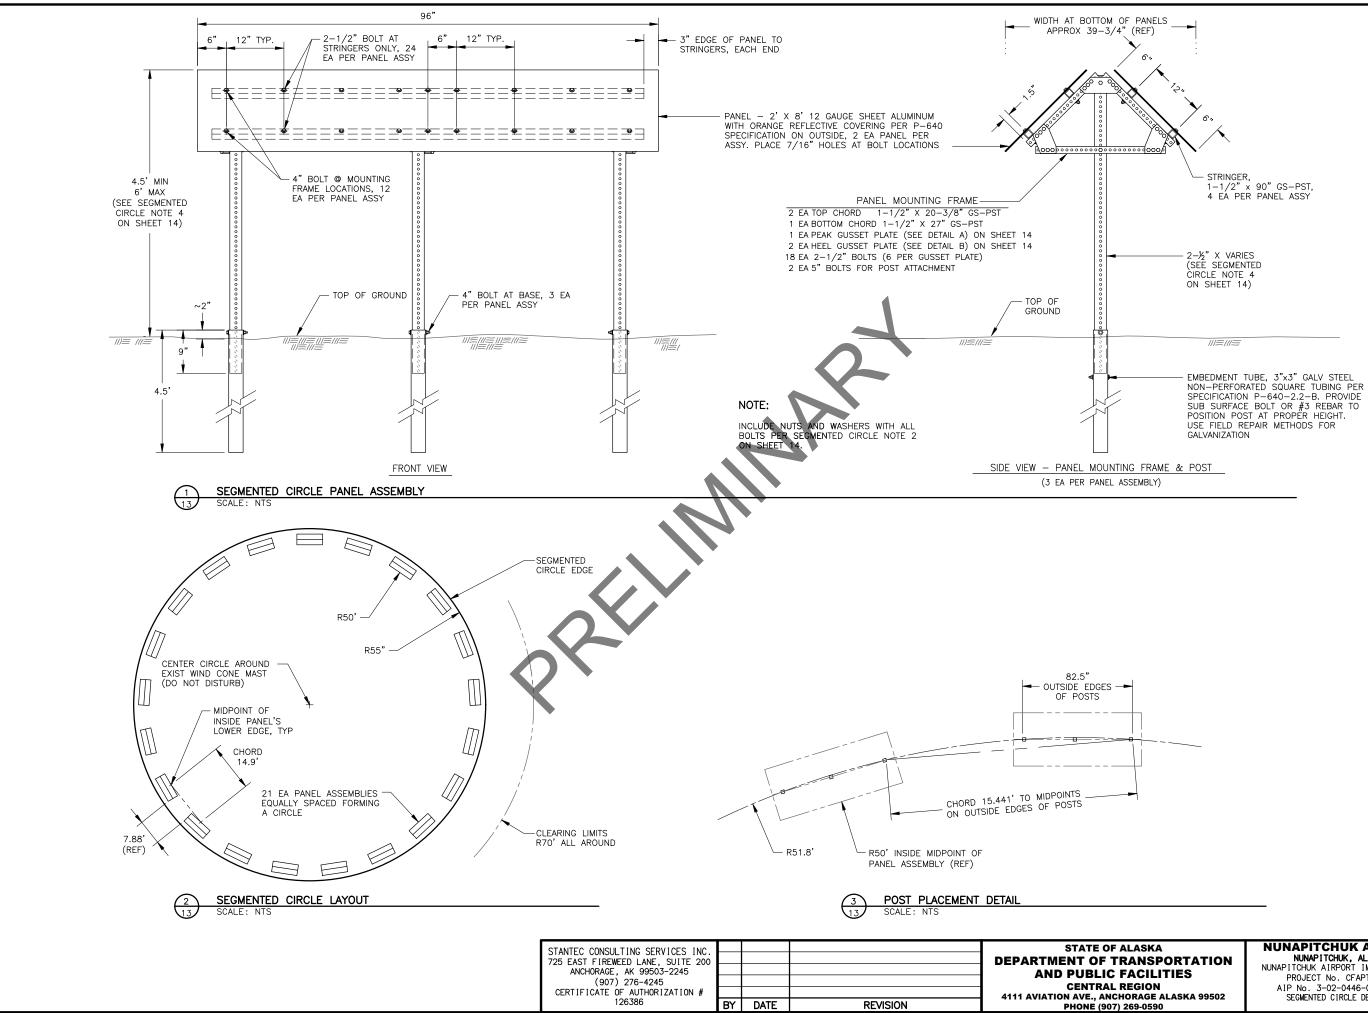
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126386

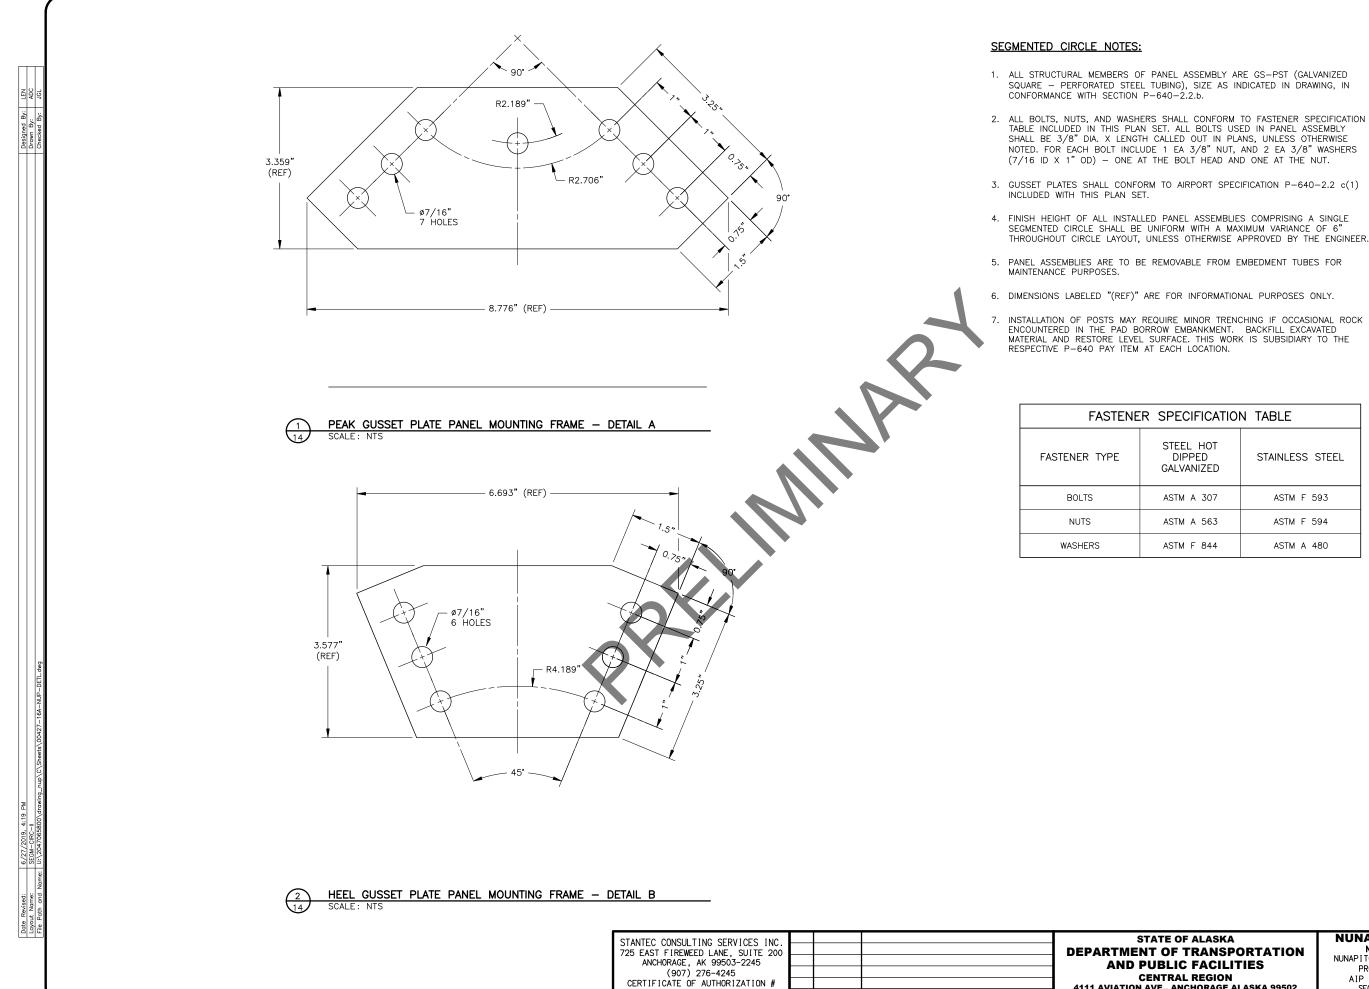BY

DATE

REVISION

NOTED. FOR EACH BOLT INCLUDE 1 EA 3/8" NUT, AND 2 EA 3/8" WASHERS

THROUGHOUT CIRCLE LAYOUT, UNLESS OTHERWISE APPROVED BY THE ENGINEER.


INSTALLATION OF POSTS MAY REQUIRE MINOR TRENCHING IF OCCASIONAL ROCK IS

ECIFICATION TABLE					
EEL HOT DIPPED LVANIZED	STAINLESS STEEL				
STM A 307	ASTM F 593				
STM A 563	ASTM F 594				
STM F 844	ASTM A 480				

### NUNAPITCHUK AIRPORT NUNAPITCHUK, ALASKA NUNAPITCHUK AIRPORT IMPROVEMENTS PROJECT No. CFAPT00427 AIP No. 3-02-0446-00X-20XX SEGMENTED CIRCLE DETAL II

SHEET:

06/27/2019

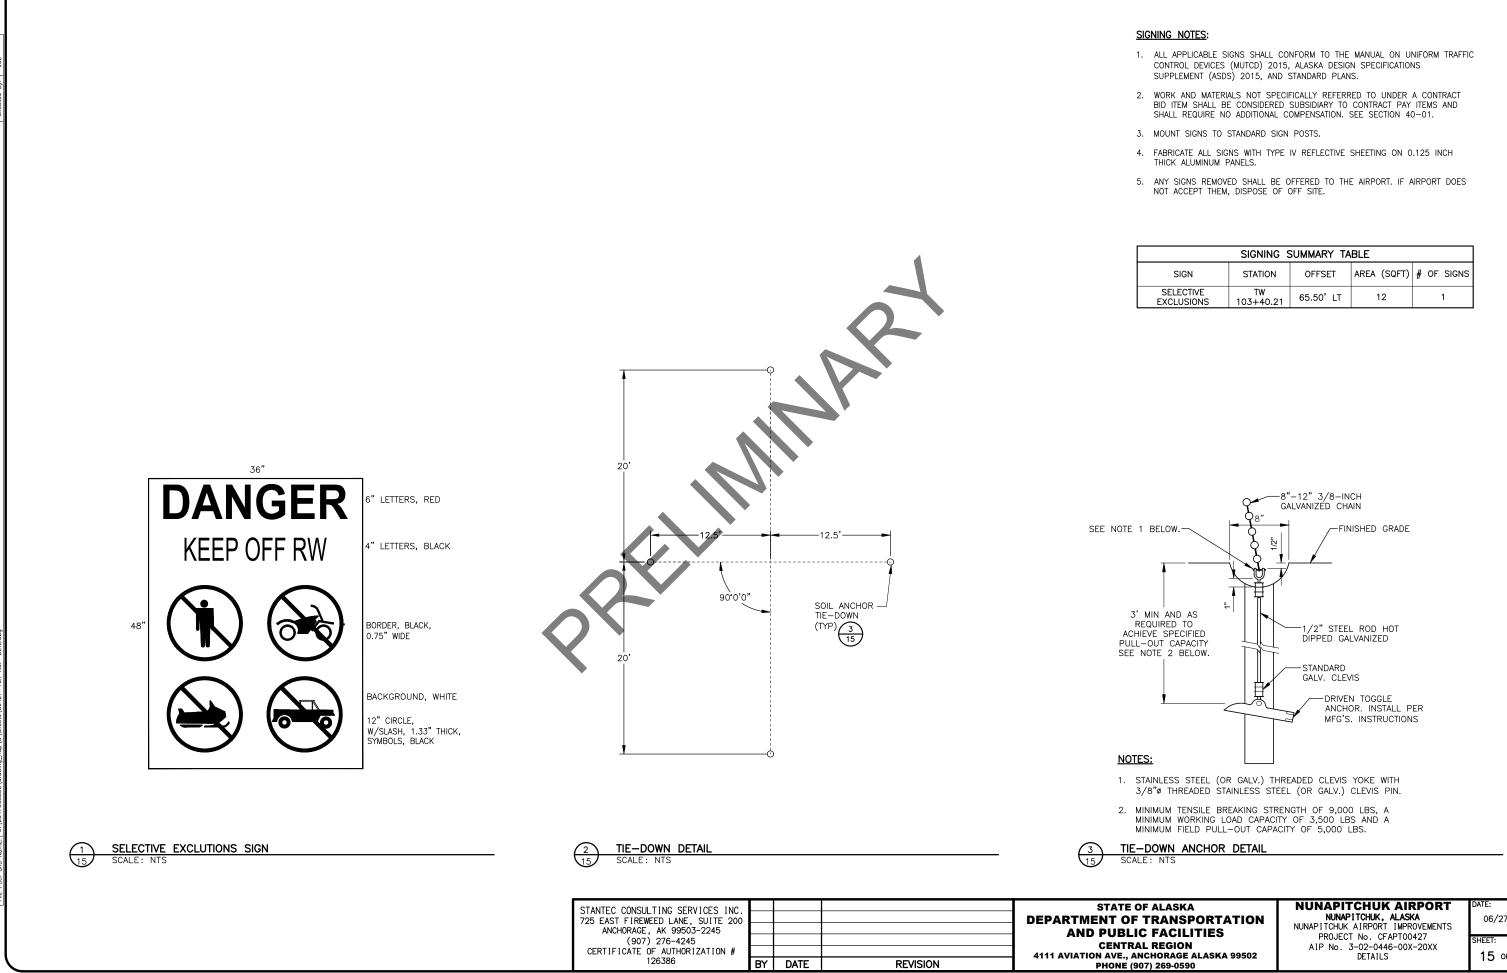

besigned By: LEN brawn By: ADC thecked By: JGI

4:19

SIGNING SUMMARY TABLE						
SIGN	STATION	OFFSET	AREA (SQFT)	# OF SIGNS		
SELECTIVE EXCLUSIONS	TW 103+40.21	65.50'LT	12	1		

OF ALASKA
F TRANSPORTATION
IC FACILITIES
AL REGION
ANCHORAGE ALASKA 99502
907) 269-0590

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06/27/2019

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### GENERAL ELECTRICAL NOTES:

- 1. LOCATIONS OF EXISTING EQUIPMENT, CONDUIT, ETC ARE TAKEN FROM ASBUILT DRAWINGS AND LIMITED SURVEY DATA AND SHALL BE FIELD VERIFIED. OBTAIN LOCATES OF EXISTING SYSTEMS AND EXCAVATE WITH CAUTION.
- REMOVE LIGHTS AND OTHER EQUIPMENT AS INDICATED ON DEMOLITION PLANS. REMOVAL INCLUDES ALL ASSOCIATED CONDUIT, CONDUCTORS, LIGHT BASES, TRANSFORMERS, CONTROLLERS, DRAIN CONDUITS, FOUNDATIONS, AND CONCRETE, UNLESS OTHERWISE INDICATED. ALL REMOVED LIGHTS, BASEPLATES (INCLUDING BOLTS), TRANSFORMERS, WIND CONES, ROTATING BEACON, BEACON PLATFORM, AND EQUIPMENT DEMOTED FOR THE FEOTPOINT. FOUND CLUBLE, CONTRACT, CONTRACT, CLUBLES, CLUBL REMOVED FROM THE ELECTRICAL EQUIPMENT BUILDING SHALL BE OFFERED TO AIRPORT MAINTENANCE. DISPOSAL OF LIGHTING EQUIPMENT DEEMED NON-SALVAGABLE BY AIRPORT MAINTENANCE AND REMOVED CONDUIT, CONDUCTORS, LIGHT BASES, CONCRETE, AND OTHER MATERIAL SHALL BE THE RESPONSIBILITY OF THE CONTRACTOR AND SHALL BE DISPOSED OF AT AN APPROVED SITE OFF OF AIRPORT PROPERTY IN ACCORDANCE WITH FEDERAL AND STATE REGULATIONS. DISPOSAL COSTS SHALL BE SUBSIDIARY TO THE CONTRACT.
- 3. COORDINATE ALL LIGHTING OUTAGES CAUSED BY DISCONNECTIONS, CIRCUIT CHANGES, OR OTHER WORK WITH THE PROJECT ENGINEER. SCHEDULE INSTALLATION OF CONDUCTORS AND OTHER EQUIPMENT TO MINIMIZE QUANTITY AND DURATION OF OUTAGES.
- 4. ALL AIRFIELD LIGHTING CONDUCTORS SHALL BE FAA TYPE C.
- 5. INSTALL A #6 BARE COPPER GROUNDING CONDUCTOR WITH ALL LIGHTING CIRCUIT CONDUCTORS.
- 6. INSTALL PULL ROPE IN ALL EMPTY CONDUITS.
- 7. ADJUST OR REPLACE EXISTING FAA PAPI/REIL JUNCTION BOXES AND HANDHOLES AS REQUIRED FOR NEW GRADE ELEVATIONS. SEE SCHEDULE ON SHEET E13 FOR WORK REQUIRED AT EACH LOCATION.

### SHEET NOTES: 🚿

- CONDUIT DRAIN TO DAYLIGHT, SEE DETAIL 5/E7. DRAIN LOCATIONS MAY BE ADJUSTED IN THE FIELD IN COORDINATION WITH THE ENGINEER TO PROVIDE OPTIMAL LOCATIONS OF CONDUIT DRAINS 1. BASED ON ACTUAL GRADES AND CONDITIONS.
- 2. REMOVE ROTATING BEACON, MOUNTING PLATFORM, LADDER, RADIO ANTENNA, AND ALL ASSOCIATED CONDUITS FROM SREB. SEAL ALL WALL AND ROOF PENETRATIONS WEATHERTIGHT.

X	EXISTING LIGHT TO BE REMOVED
0	RUNWAY EDGE LIGHT, OMNI-DIRECTIONAL
Ø	RUNWAY EDGE LIGHT, BI-DIRECTIONAL
Ð	RUNWAY THRESHOLD LIGHT, BI-DIRECTIONAL
•	TAXIWAY EDGE LIGHT, OMNI-DIRECTIONAL
Ŧ	GROUND ROD, 3/4"x10' TYPICAL
$\otimes$	HANDHOLE (HH), TYPE I (LIGHT BASE WITH BLANK COVER)
E	JUNCTION BOX
$\boxtimes$	METERBASE
$\[\]$	WIND CONE
\	ROTATING BEACON
$\langle X \rangle$	REFERENCE TO SHEET NOTE
$\land$	REFERENCE TO REVISION
FQUIPMEN	IT NUMBER, SEE SCHEDULES ON SHEET E13
RX TX	RUNWAY EDGE LIGHT TAXIWAY EDGE LIGHT
HHX FX	HANDHOLE FAA JUNCTION BOX/HANDHOLE
LIGHT CO	LORS AND DISTRIBUTIONS
	BLUE YELOW/AMBER
G	GREEN RED
Ŵ	MHITE OBSCURED/BLANK
BII	BI-DIRECTIONAL
	OMI-DIRECTIONAL

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Date Revised:	Layout Name:	File Path and Name: U:

STANTEC CONSULTING SERVICES INC.				STATE C
725 EAST FIREWEED LANE, SUITE 200 ANCHORAGE, AK 99503-2245				DEPARTMENT OF
(907) 276-4245				AND PUBLI CENTRA
CERTIFICATE OF AUTHORIZATION #				4111 AVIATION AVE., A
126386	BY	DATE	REVISION	PHONE (9

# ELECTRICAL PLAN LEGEND

	EXISTING UTILITY LINE TO REMAIN, XXX DESIGNATES TYPE
—xxx—	NEW UTILITY LINE, XXX DESIGNATES TYPE UG = UNDERGROUND E = ELECTRIC OH = OVERHEAD T = TLEPHONE C = COMMUNICATIONS
	EXISTING CONDUIT TO REMAIN
	HDPE CONDUIT WITH CONDUCTORS AS INDICATED, 2" UNLESS OTHERWISE INDICATED
	RIGID STEEL CONDUIT WITH CONDUCTORS AS INDICATED, 2" UNLESS OTHERWISE INDICATED
	TEMPORARY JUMPER OR CIRCUIT, SURFACE LAID IN HDPE CONDUIT
	SERIES LIGHTING CIRCUIT, TICK MARKS INDICATE NUMBER OF 5KV SERIES CONDUCTORS IN CONDUIT (2 SHOWN), INCLUDE GROUND CONDUCTOR (NOT SHOWN), TICK MARKS NOT SHOWN ON SHORT SEGMENTS OR IN CONGESTED AREAS FOR CLARITY
ELECTRICAL	ABBREVIATIONS
BC	AUTOMATED WEATHER OBSERVING SYSTEM BARE COPPER CONDUIT CIRCUIT BREAKER CUBIC FOOT
DOT&PF	DEPARTMENT OF TRANSPORTATION AND PUBLIC FACILITIES ELECTRICAL METALLIC TUBING
FAA GRD	GROUND
HDPE LFMC LFNC NF	HIGH DENSITY POLYETHYLENE LIQUIDTIGHT FLEXIBLE METALLIC CONDUIT LIQUIDTIGHT FLEXIBLE NONMETALLIC CONDUIT NON-FUSED
DF	NOT IN CONTRACT PHOTOELECTRIC
RMC SREB	RIGID METALLIC CONDUIT (GALVANIZED STEEL) SNOW REMOVAL EQUIPMENT BUILDING
SS TYP UON	STAINLESS STEEL TYPICAL UNLESS OTHERWISE NOTED


### NUNAPITCHUK AIRPORT NUNAPITCHUK, ALASKA NUNAPITCHUK AIRPORT IMPROVEMENTS PROJECT No. CFAPT00427 AIP No. 3-02-0446-00X-20XX LEGEND AND ABBREVIATIONS


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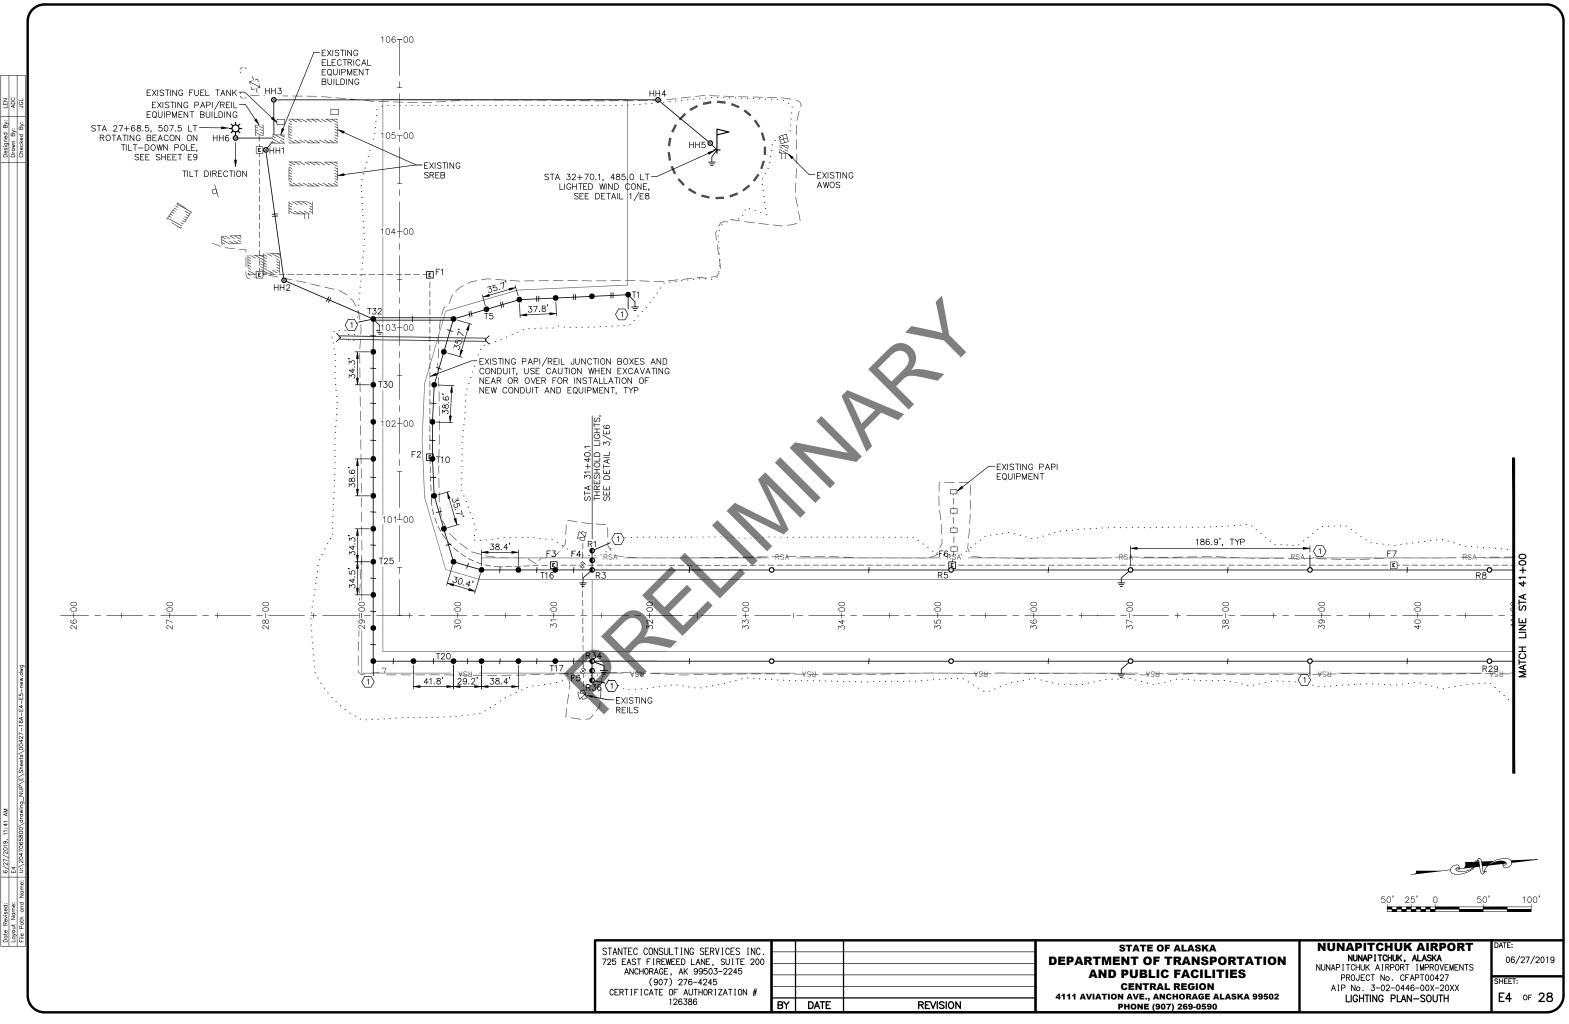
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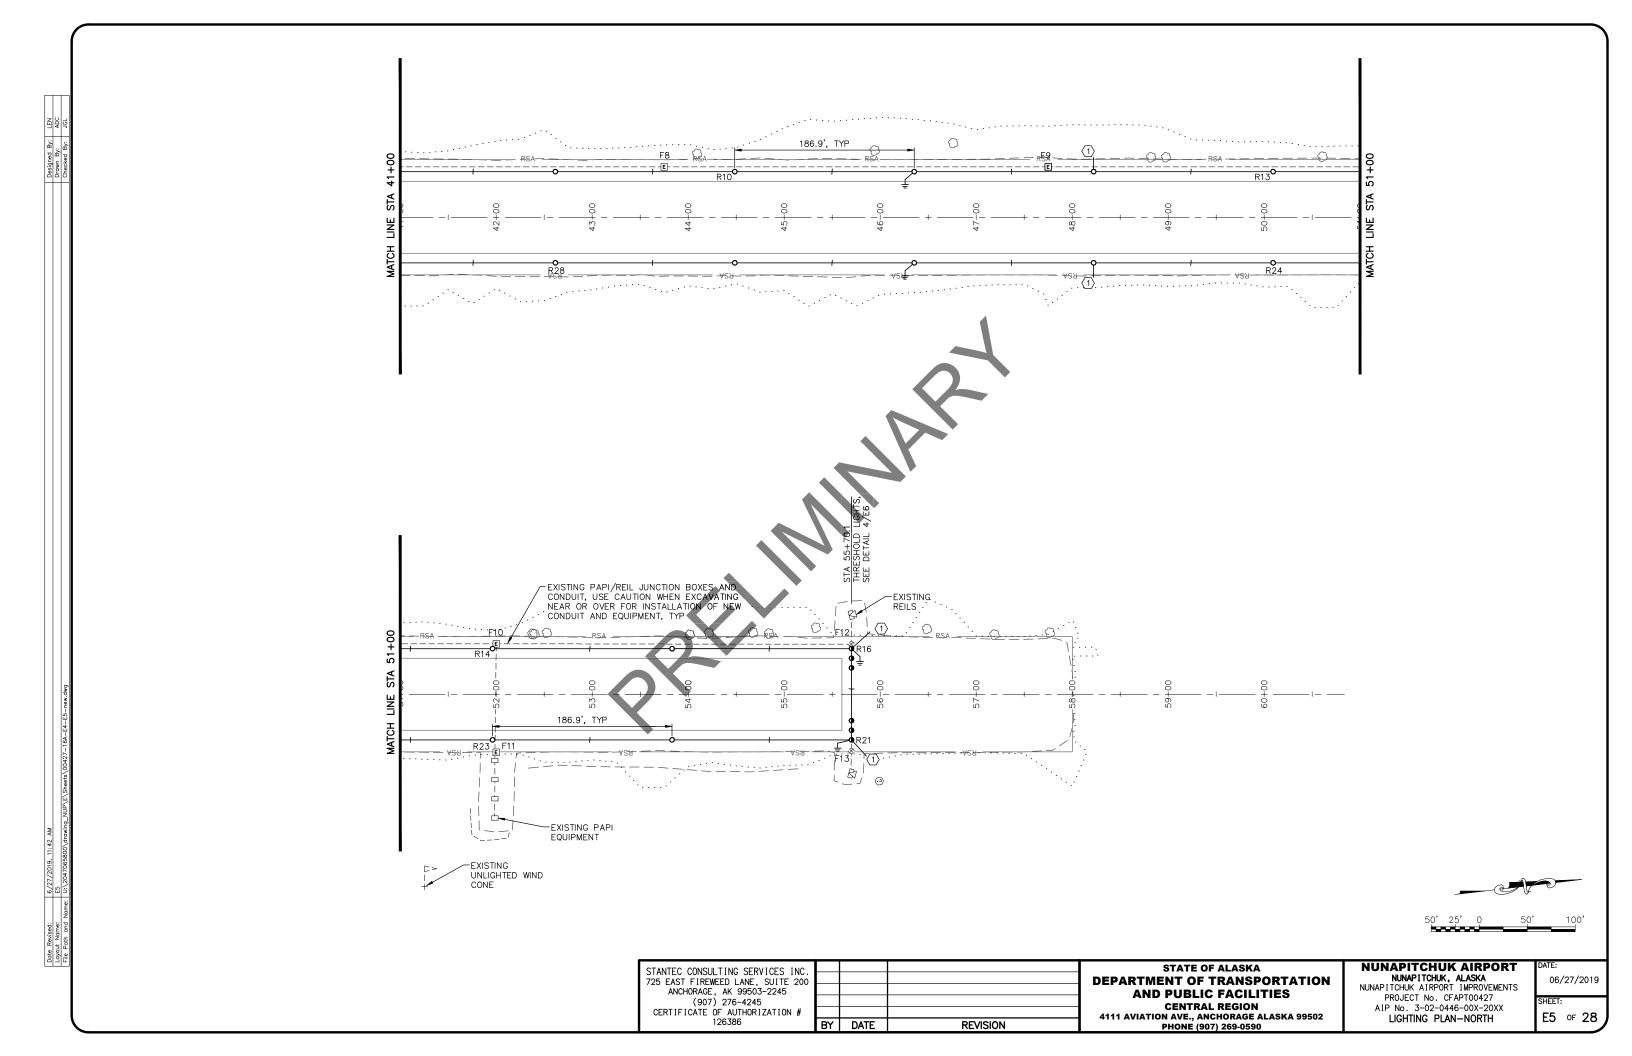
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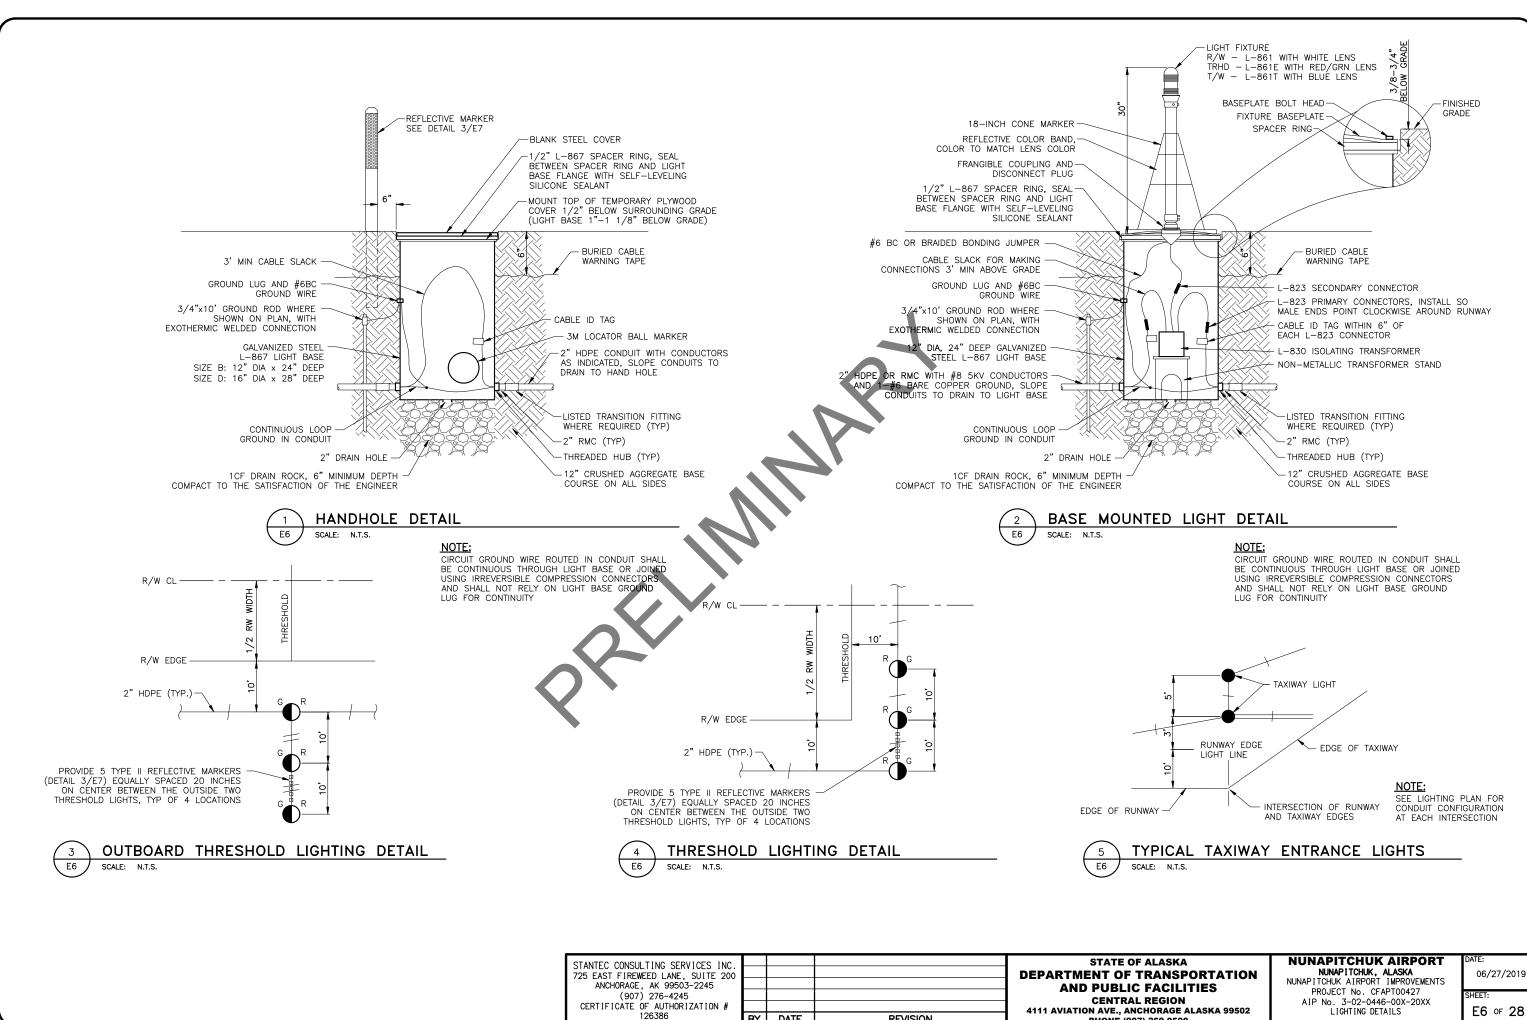
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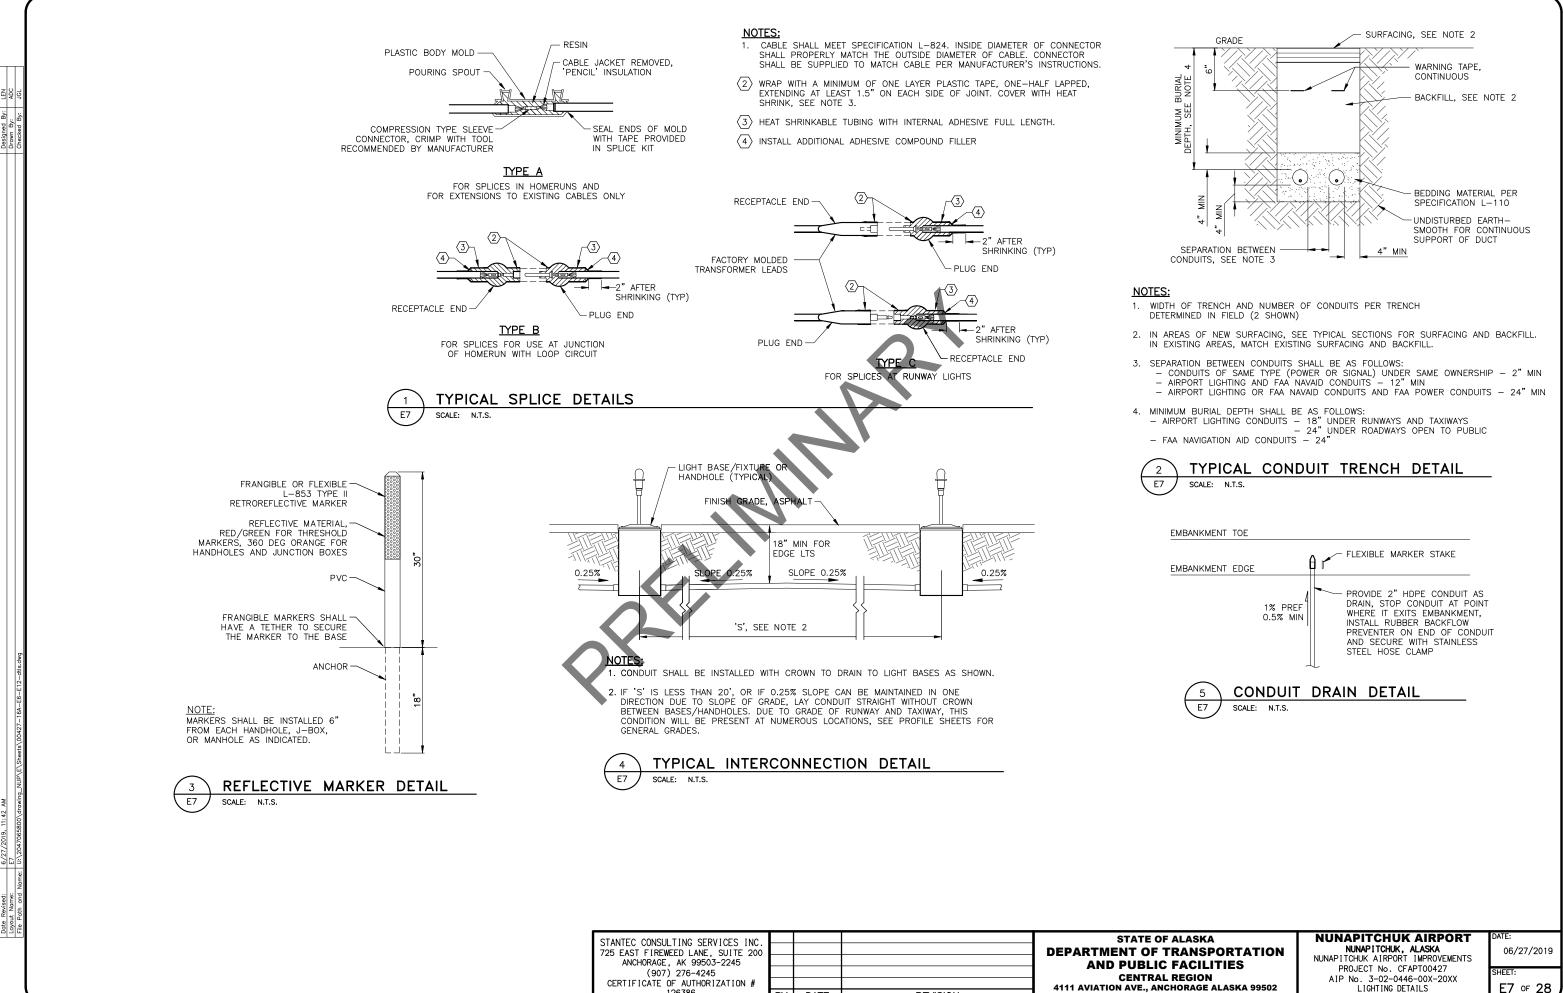
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PHONE (907) 269-0590

LIGHTING DETAILS

E6 of 28

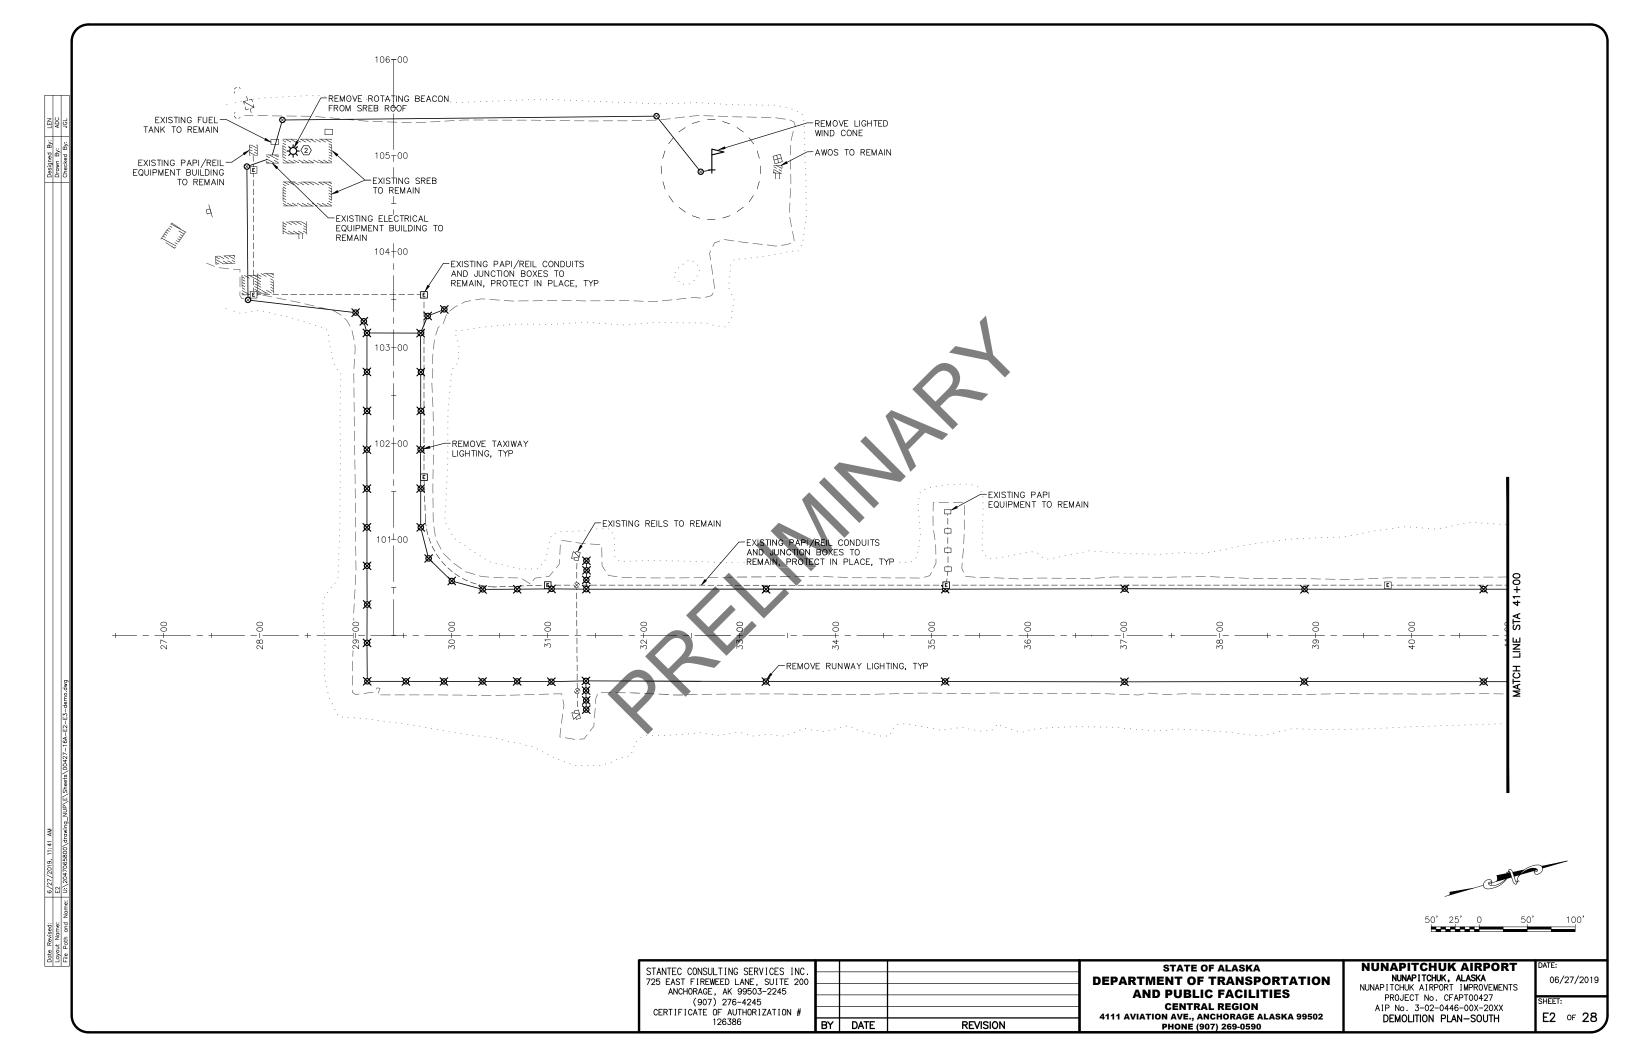


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BY

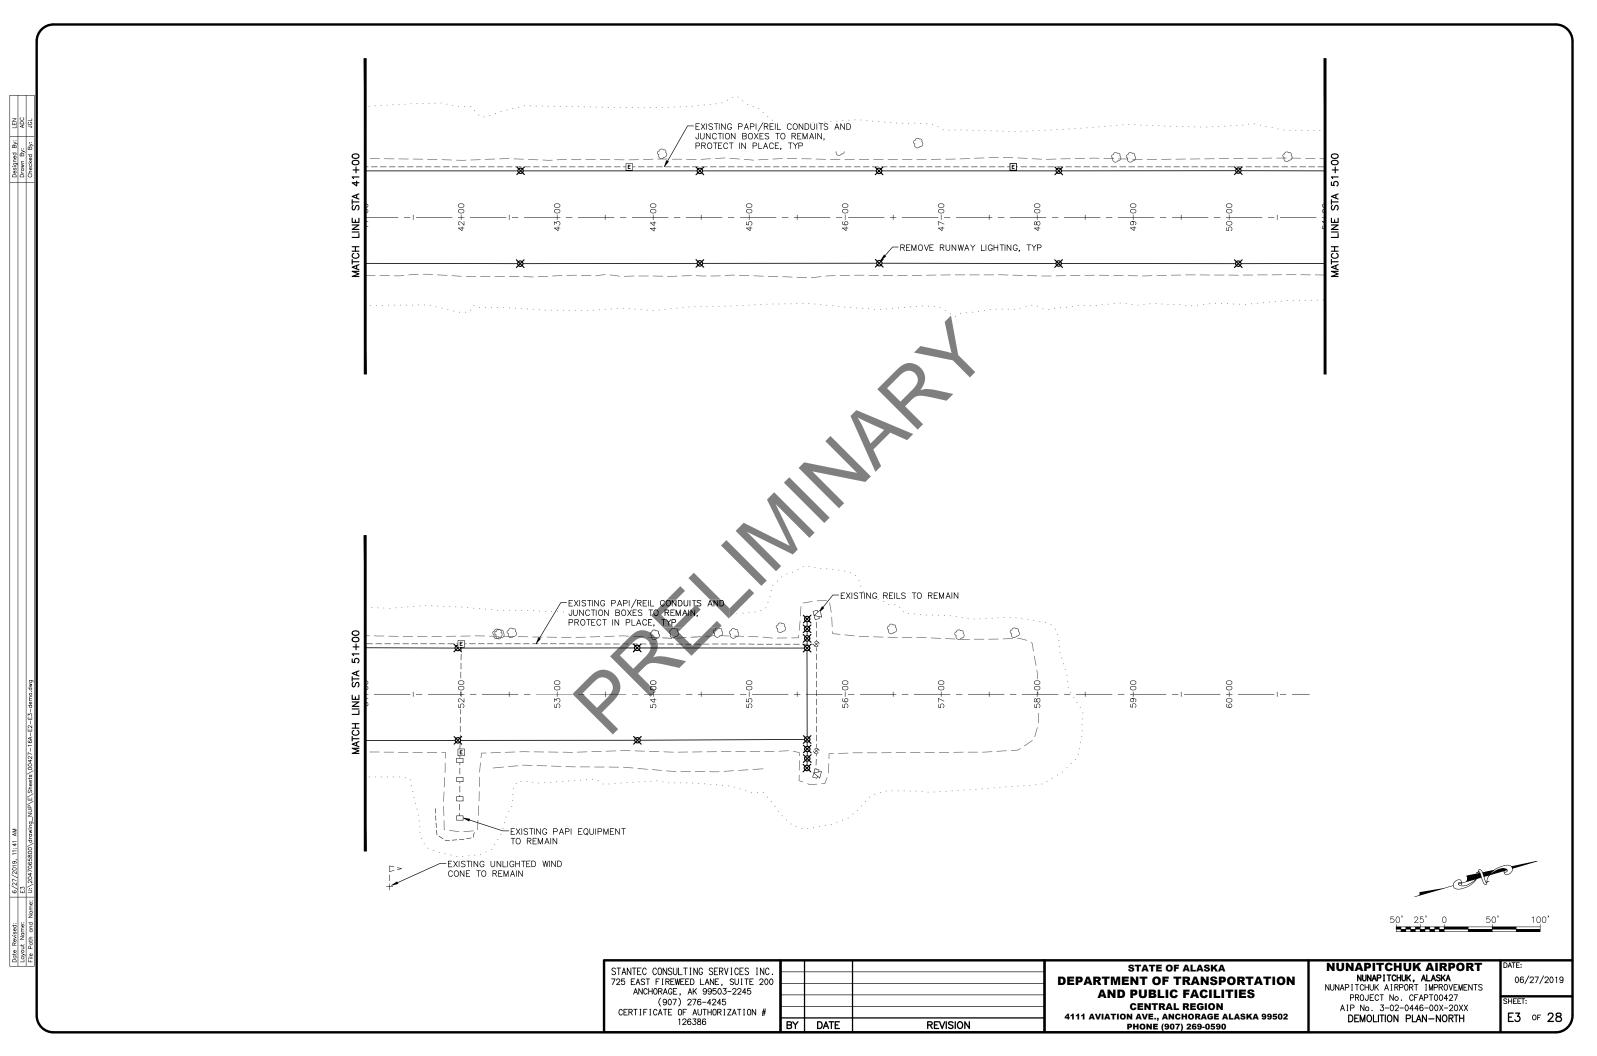DATE

REVISION


PHONE (907) 269-0590

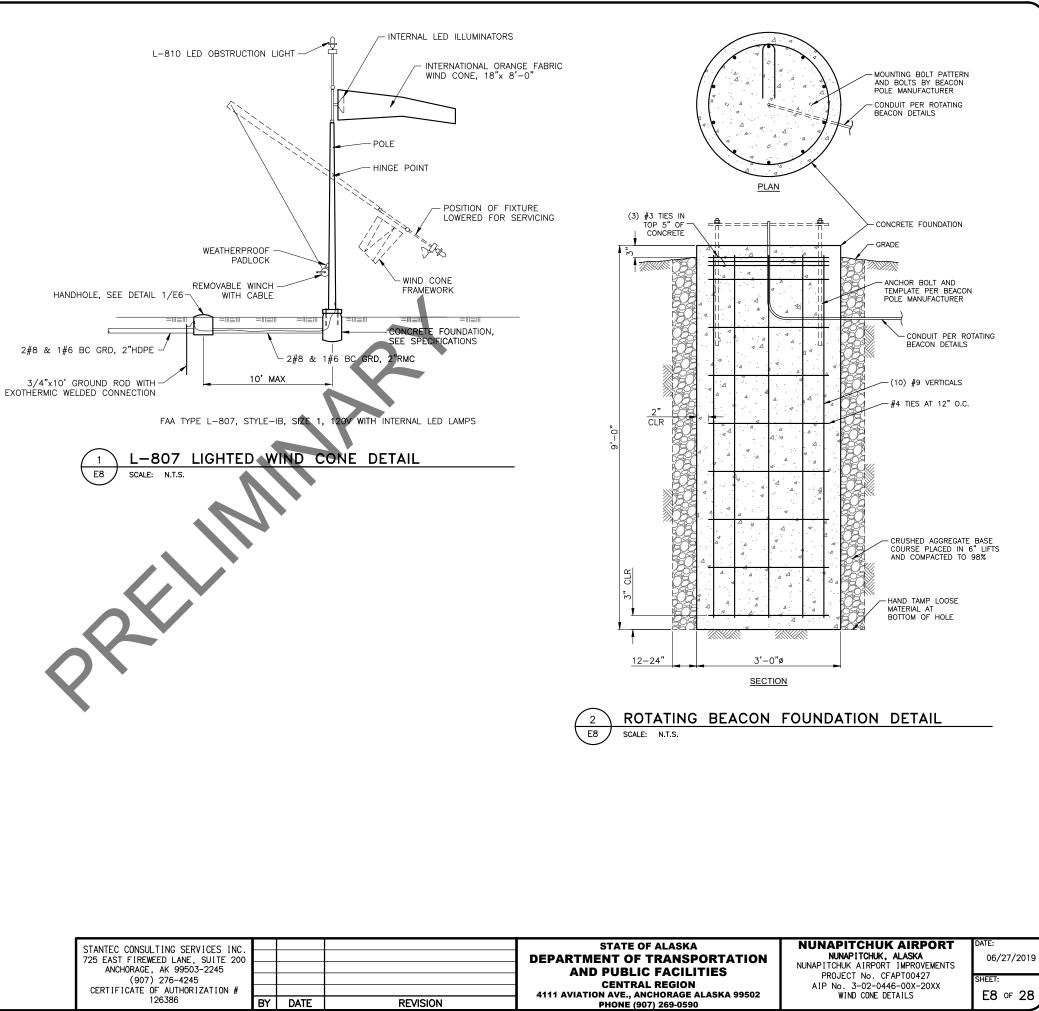

STATE O				STANTEC CONSULTING SERVICES INC.
DEPARTMENT OF				725 EAST FIREWEED LANE. SUITE 200
				ANCHORAGE. AK 99503-2245
				(907) 276-4245
CENTRA				CERTIFICATE OF AUTHORIZATION #
4111 AVIATION AVE., AN	REVISION	DATE	BY	126386
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Designed By: LEN Drawn By: ADC Checked Rv: JGI



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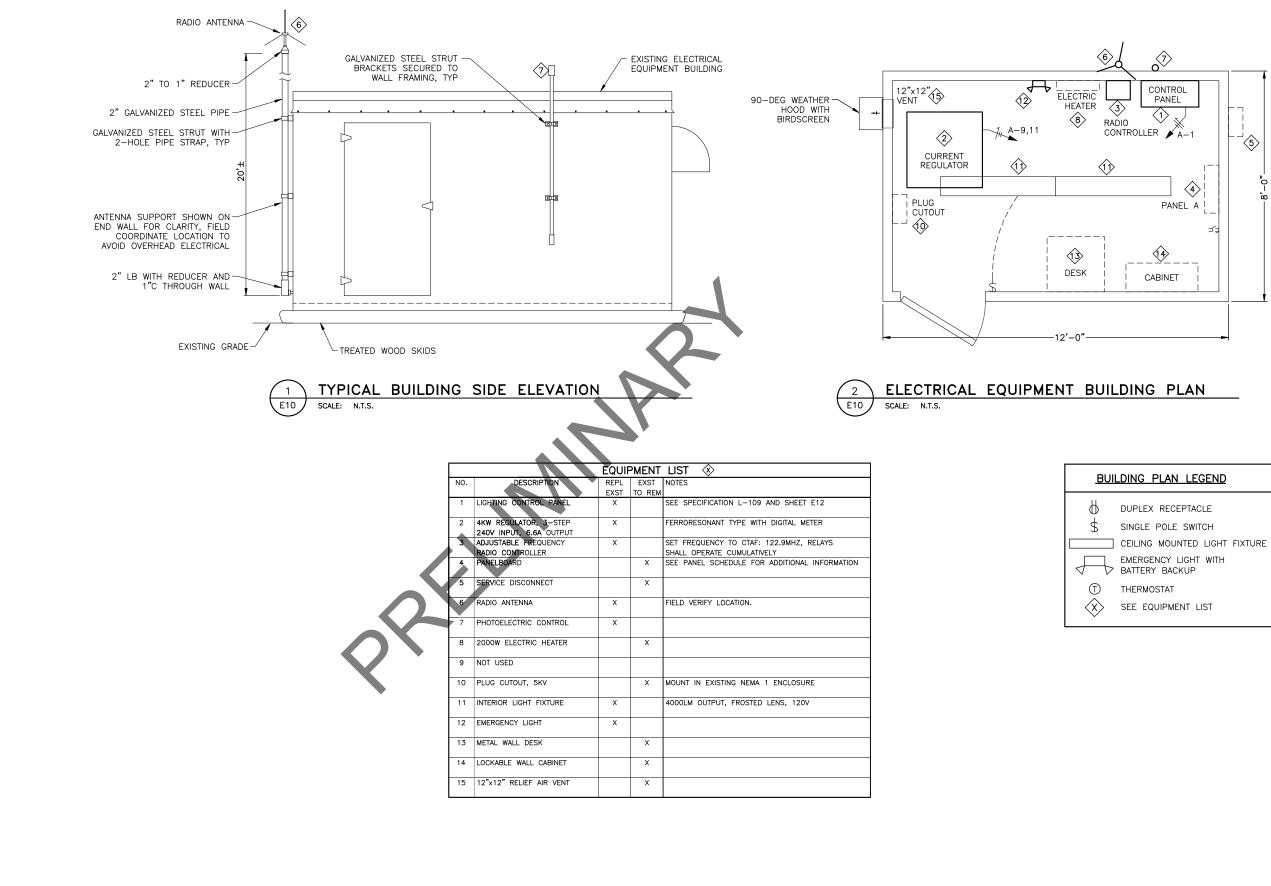
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REVISION

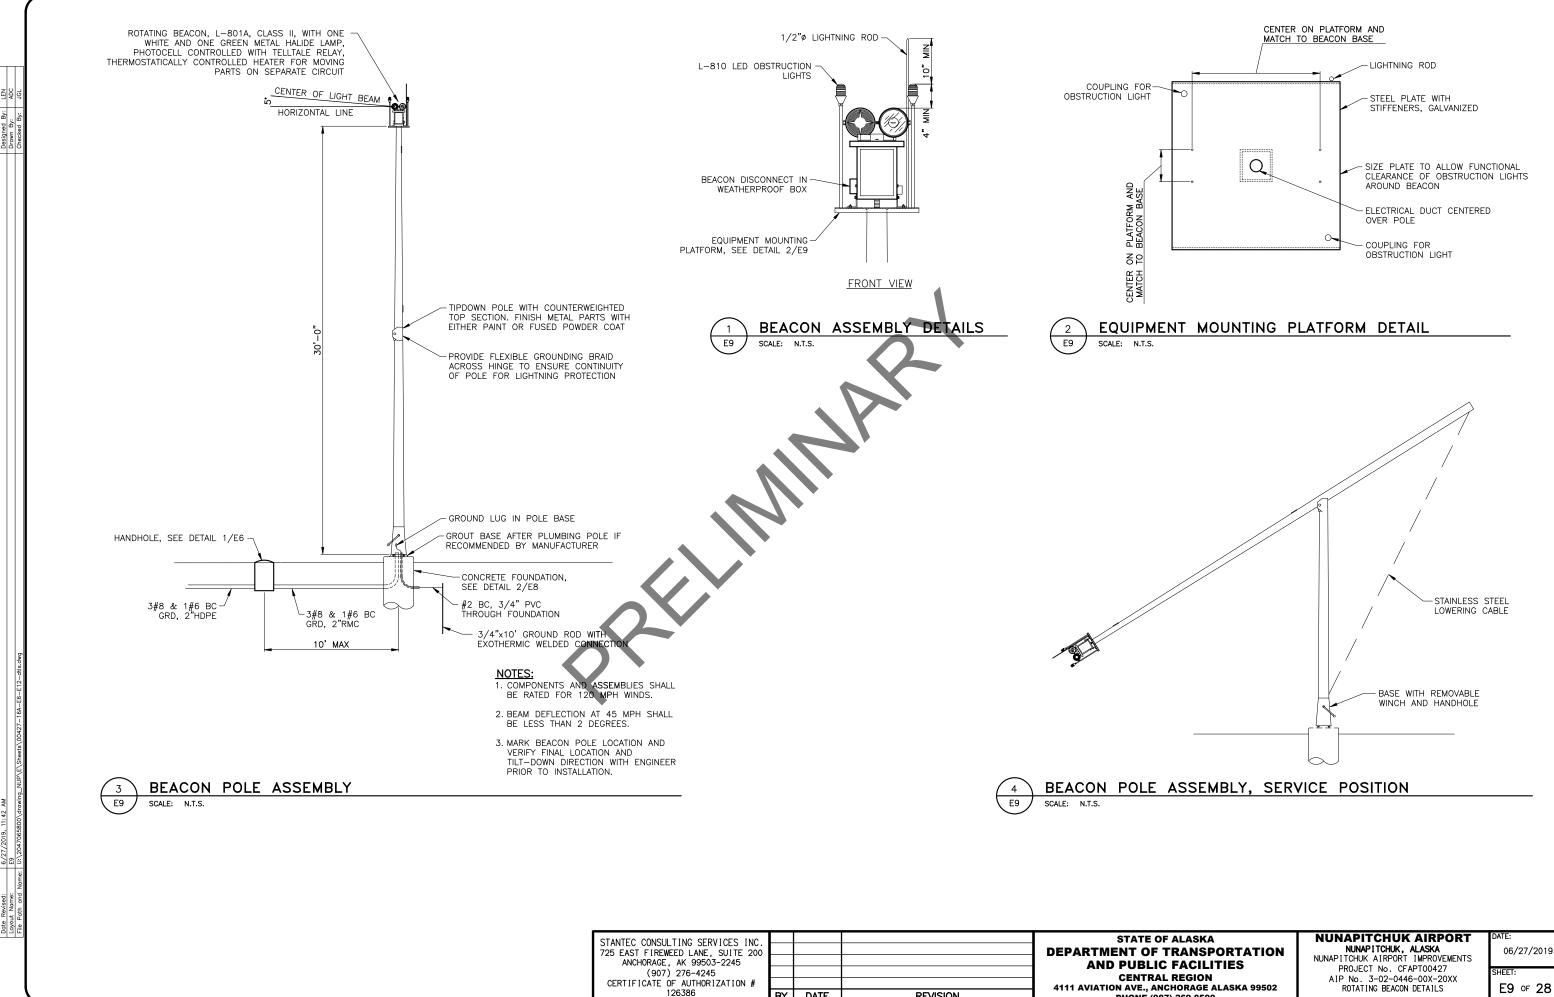4111 AVIATION AVE., ANCHORAGE ALASKA 99502 PHONE (907) 269-0590

ROTATING BEACON DETAILS

E9 of 28



STANTEC CONSULTING SERVICES INC.				STATE O
725 EAST FIREWEED LANE, SUITE 200 ANCHORAGE, AK 99503-2245 (907) 276-4245				AND PUBLI
CERTIFICATE OF AUTHORIZATION #				CENTRA 4111 AVIATION AVE A
126386	BY	DATE	REVISION	PHONE (9

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Designed By: LEN Drawn By: ADC

BUILDING PLAN LEGEND									
φ	DUPLEX RECEPTACLE								
\$	SINGLE POLE SWITCH								
	CEILING MOUNTED LIGHT FIXTURE								
	EMERGENCY LIGHT WITH BATTERY BACKUP								
T	THERMOSTAT								
$\otimes$	SEE EQUIPMENT LIST								

OF ALASKA TRANSPORTATION IC FACILITIES AL REGION ANCHORAGE ALASKA 99502 907) 269-0590

NUNAPITCHUK AIRPORT NUNAPITCHUK, ALASKA NUNAPITCHUK AIRPORT IMPROVEMENTS PROJECT No. CFAPT00427 AIP No. 3-02-0446-00X-20XX ELECTRICAL EQUIPMENT BUILDING DETAILS

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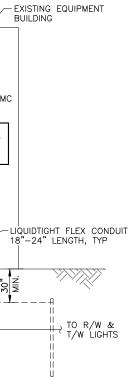
		EXISTING SNOW REMOVAL EQUIPMENT BUILDING				RAD	DIO ANTE	INNA —		6		ABON	TOELECTRIC C /E BUILDING AT 5 FC TUR	ROOF OF	RIENTED	24" NOR EXIS BUIL
				SERVICE DISCO		2	8, 1#1C	1" RMC	5#12, ( 1 1 1 1 1 1 1 1 1 1 1 1 1	1#12 G 3/4" F RADIO CONTRO		CONTROL PANEL	3/4" RMC #12, 3/4" RM CURRENT REG 2 #8 5KV, 1#6 2"	2#8 1#6 1-1/ SI CL	BC, '2" RMC ERIES JTOUT	LIQUI 18"–
			 												30°	И М
REPL	PMENT EXST	NOTES		GROU	EMAIN             			) WIND	CONE	#6 BC, 2" RMC		2#8, 1#6 BC 2" RMC	2#8 5KV, 1#6 2"1 2,	HDPE		
EXST X	TO REM	SEE SPECIFICATION L-109 AND SHEET E12					×									
x		FERRORESONANT TYPE WITH DIGITAL METER	Ļ	1			STINC							-		
×		SET FREQUENCY TO CTAF: 122.9MHZ, RELAYS SHALL OPERATE CUMULATIVELY	CK			BRA BKR	NCH VA	CONN A	KVA B	BRA VA	NCH BKR	LOAD		скт		
	×	SEE PANEL SCHEDULE FOR ADDITIONAL INFORMATION	1			20/1	600	0.6		170				2		
	×		5	3 ROTATING BEACO		20/2	395 400	0.6	0.5	139 180		ENCLOSURE LIGHTS RECEPTACLES		6		
x		FIELD VERIFY LOCATION.	7	7 WIND CONE		20/1	64		1.1	1000		ELECTRIC HEATER		8		
x				4KW REGULATOR		30/2 NOTE 3		3.8	2.8	1000 75	20/1	STRIP HEATER		10 12		
	x			3 SPARE (SEE NOT		40/2	2,00	0.0	2.0	,0	20/1			14		
				5					0.0					16		
				7	CONNECTED LOAD	9.4	KVA	0.0 4.9	4.4		P/	ANEL SPECIFICATIONS		18		
	×	MOUNT IN EXISTING NEMA 1 ENCLOSURE					AMPS	41	37			MAINS RATING AMPS				
x		4000LM OUTPUT, FROSTED LENS, 120V			NEC DEMAND		KVA AMPS					T BREAKER AMPERES ONE-POLE CIRCUITS				
x				PANEL NOTES		40				L		SYSTEM VOLTAGE				
	×				AKERS ARE EXISTING				CATED.		Pł	HASE, NO. OF WIRES				
	x				LOAD SHOWN. ACTUAL G CKT BREAKER(S) V				ATED.			AIC RATING MOUNTING	- 10,000 - SURFACE			
				RELOCATE EXISTIN	G CIRCUIT BREAKERS	AND LA	ABEL AS S	SPARE.								
	X		4.	. RELOCATED EXIST	ING CIRCUIT BREAKE	R. LEAVE	IN OFF	POSITIO	N.							

STANTEC CONSULTING SERVICES INC.				STATE (
725 EAST FIREWEED LANE. SUITE 200				DEPARTMENT OF
ANCHORAGE, AK 99503-2245				AND PUBLI
(907) 276-4245				CENTR
CERTIFICATE OF AUTHORIZATION #				4111 AVIATION AVE., A
126386	BY	DATE	REVISION	PHONE (9

		LQUI		LIJI
NO.	DESCRIPTION	REPL EXST	EXST TO REM	NOTES
1	LIGHTING CONTROL PANEL	X	IU REM	SEE SPECIFICATION L-109 AND SHEET E12
2	4KW REGULATOR, 3-STEP 240V INPUT, 6.6A OUTPUT	x		FERRORESONANT TYPE WITH DIGITAL METER
3	ADJUSTABLE FREQUENCY RADIO CONTROLLER	x		SET FREQUENCY TO CTAF: 122.9MHZ, RELAYS SHALL OPERATE CUMULATIVELY
4	PANELBOARD		X	SEE PANEL SCHEDULE FOR ADDITIONAL INFORMATION
5	SERVICE DISCONNECT		x	
6	RADIO ANTENNA	x		FIELD VERIFY LOCATION.
7	PHOTOELECTRIC CONTROL	x		
8	2000W ELECTRIC HEATER		x	
9	NOT USED			
10	PLUG CUTOUT, 5KV		x	MOUNT IN EXISTING NEMA 1 ENCLOSURE
11	INTERIOR LIGHT FIXTURE	x		4000LM OUTPUT, FROSTED LENS, 120V
12	EMERGENCY LIGHT	x		
13	METAL WALL DESK		x	
14	LOCKABLE WALL CABINET		x	
15	12"x12" RELIEF AIR VENT		x	

resigned By: LEN rawn By: ADC

24" ORTH



### ELECTRICAL EQUIPMENT BUILDING NOTES:

- ALL BUILDING PENETRATIONS SHALL GO THROUGH THE FLOOR OR WALLS. WALL PENETRATIONS SHALL BE MADE BELOW THE LEVEL OF THE INTERIOR EQUIPMENT THEY SERVE.
- 2. NO PENETRATIONS SHALL BE MADE THROUGH THE ROOF.
- 3. ALL PENETRATIONS SHALL BE SEALED WEATHERTIGHT WITH SILICONE SEALANT.
- 4. IMC OR EMT MAY BE USED FOR CONDUIT SECTIONS LOCATED ENTIRELY INTERIOR TO THE EQUIPMENT BUILDING.
- 5. GROUND RING AND RODS ARE SUBSIDIARY TO EQUIPMENT BUILDING INSTALLATION.
- 6. ALL CONDUCTORS SHALL BE COPPER, TYPE XHHW-2 UNLESS OTHERWISE INDICATED.
- PROVIDE FAULT CURRENT LABEL ON SERVICE EQUIPMENT (SERVICE DISCONNECT) READING "AVAILABLE FAULT CURRENT = 3328A, CALCULATED ON 11 JUN 2019."
- PROVIDE FAULT CURRENT LABEL ON SERVICE EQUIPMENT (METERBANK) READING "AVAILABLE FAULT CURRENT = 3573A, CALCULATED ON 11 JUN 2019."


# NUNAPITCHUK AIRPORT NUNAPITCHUK, ALASKA NUNAPITCHUK AIRPORT IMPROVEMENTS PROJECT No. CFAPTO0427 AIP No. 3-02-0446-00X-20XX ELECTRICAL EQUIPMENT BUILDING DETAILS

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06/27/2019


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STATE OF				STANTEC CONSULTING SERVICES INC.	Г
DEPARTMENT OF 1				725 EAST FIREWEED LANE. SUITE 200	
AND PUBLIC				ANCHORAGE, AK 99503-2245	T
CENTRAL				(907) 276-4245	T
4111 AVIATION AVE., AND				CERTIFICATE OF AUTHORIZATION #	Т
PHONE (907	REVISION	DATE	BY	126386	Т

Designed By: LEN Drawn By: ADC

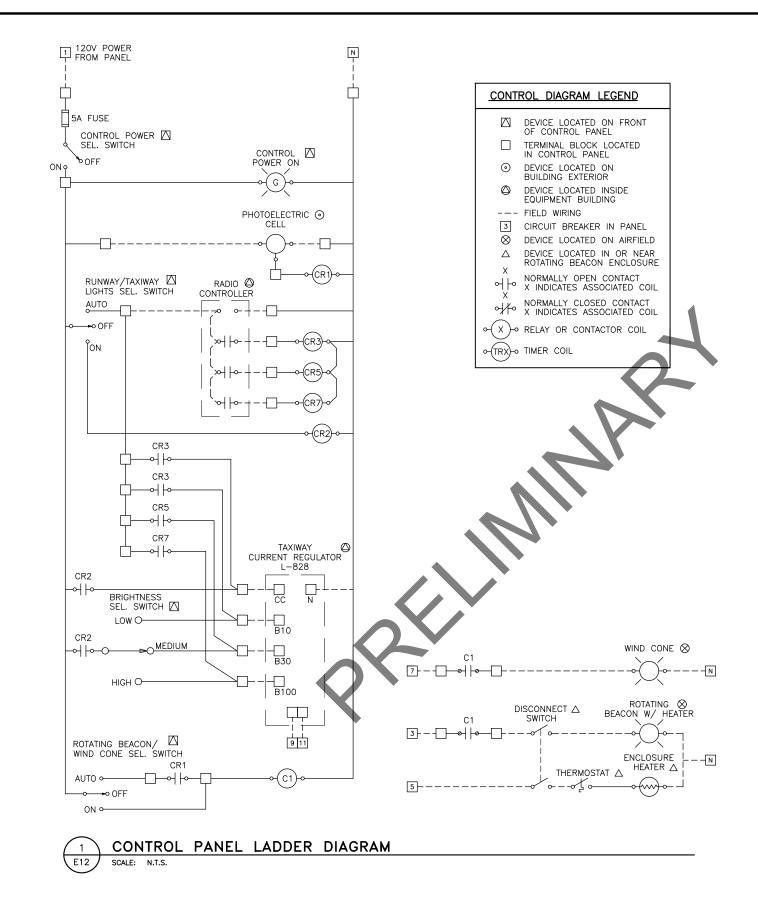

### CONTROL SEQUENCE DESCRIPTION

### RUNWAY & TAXIWAY LIGHTS

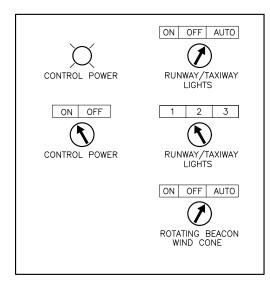ON - LIGHTS ON AT BRIGHTNESS SET BY MANUAL BRIGHTNESS SWITCH

- OFF LIGHTS OFF
- AUTO RADIO CONTROLLER ENABLED 3 CLICKS OF MIC TURNS ON RW/TW LIGHTS AT STEP 1, 2 ADDITIONAL CLICKS OF MIC TURNS RW/TW LIGHTS TO STEP 2, 2 ADDITIONAL CLICKS OF MIC TURNS RW/TW LIGHTS TO STEP 3, LIGHTS REMAIN ON FOR 15 MINUTES AFTER LAST CLICK

### ROTATING BEACON/WIND CONE

- ON BEACON ON
- OFF BEACON OFF
- AUTO PHOTOELECTRIC CONTROL ENABLED

## 2 CONTROL PANEL DETAIL

E12 SCALE: N.T.S.

### NUNAPITCHUK AIRPORT NUNAPITCHUK, ALASKA NUNAPITCHUK AIRPORT IMPROVEMENTS PROJECT NO. CFAPTO0427 AIP NO. 3-02-0446-00X-20XX LIGHTING CONTROL PANEL DETAILS

DATE:

SHEET:

06/27/2019

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NUM	TYPE	SIZE WxLxD	STATION	OFFSET	estimated Elev Change	REMARKS
F1	П	24x36x24	103+55.0	31.5 R	0.59	SEE NOTE 4
F2	П	24x36x24	101+65.0	31.5 R	0.78	SEE NOTE 4
F3	П	24x36x24	31+00.1	52.6 L	1.53	SEE NOTE 4
F4	I	в	31+30.1	52.5 L	1.14	SEE NOTE 3
F5	I	в	31+30.7	57.8 R	0.71	SEE NOTE 3
F6	П	24x36x24	35+15.1	52.5 L	0.82	SEE NOTE 4
F7	П	24x36x24	39+75.1	52.5 L	0.44	SEE NOTE 2
F8	П	24x36x24	43+75.1	52.5 L	0.52	SEE NOTE 2
F9	П	24x36x24	47+75.1	52.5 L	0.73	SEE NOTE 4
F10	П	24x36x24	52+00.1	52.5 L	0.21	SEE NOTE 2
F11	П	24x36x24	52+00.1	60.5 R	0.32	SEE NOTE 2
F12	I	В	55+70.1	52.2 L	0.43	SEE NOTE 3
F13	1	В	55+69.9	59.0 R	0.56	SEE NOTE 3

Designed By: LEN Drawn By: ADC Attorbad Ru: JGL

2019, 11:42 AN

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NOTES: 1. JUNCTION BOX LOCATIONS ARE BASED ON ASBUILT DRAWINGS. TYPE II JUNCTION BOX CONSTRUCTION IS UNKNOWN. VERIFY LOCATIONS, CONSTRUCTION, AND ELEVATIONS

PRIOR TO STARTING WORK. 2. RAISE JUNCTION BOX OR PROVIDE JUNCTION BOX EXTENSION AS REQUIRED TO BRING JUNCTION BOX TO NEW GRADE ELEVATION. PROTECT EXISTING CONDUIT AND CONDUCTORS IN PLACE.

PROVIDE LIGHT BASE EXTENSION TO BRING HANDHOLE TO NEW GRADE ELEVATION.
 REPLACE EXISTING JUNCTION BOX WITH NEW H-20 TRAFFIC-RATED JUNCTION BOX AT NEW GRADE ELEVATION. PROTECT EXISTING CONDUITS AND CONDUCTORS IN PLACE.

NUM	LENS COLOR	TYPE	LAMP WATTAGE	XFMR WATTAGE	STATION	OFFSET	REMARKS
R1	G/R	L-861E	45	30/45	31+40.1	67.5 L	
R2	G/R	L-861E	45	30/45	31+40.1	57.5 L	
R3	G/R	L-861E	45	30/45	31+40.1	47.5 L	
R4	w	L-861	45	30/45	33+27.0	47.5 L	
R5	w	L-861	45	30/45	35+13.9	47.5 L	
R6	w	L-861	45	30/45	37+00.9	47.5 L	
R7	w	L-861	45	30/45	38+87.8	47.5 L	
R8	w	L-861	45	30/45	40+74.7	47.5 L	
R9	w	L-861	45	30/45	42+61.6	47.5 L	
R10	w	L-861	45	30/45	44+48.6	47.5 L	
R11	w	L-861	45	30/45	46+35.5	47.5 L	
R12	w	L-861	45	30/45	48+22.4	47.5 L	
R13	w	L-861	45	30/45	50+09.3	47.5 L	
R14	w	L-861	45	30/45	51+96.2	47.5 L	
R15	w	L-861	45	30/45	53+8 <b>3.2</b>	47.5 L	
R16	R/G	L-861E	45	30/45	55+70.1	47.5 L	
R17	R/G	L-861E	45	30/45	55+70.1	37.5 L	·
R18	R/G	L-861E	45	30/45	55+70.1	<b>27</b> .5 L	
R19	R/G	L-861E	45	30/45	55+70.1	27.5 R	
R20	R/G	L-861E	45	30/45	<b>55+</b> 70.1	37.5 R	
R21	R/G	L-861E	45	30/45	55+70.1	47.5 R	
R22	w	L-861	45	30/45	53+83.2	47.5 R	
R23	w	L-861	45	30/45	51+96.2	47.5 R	
R24	w	L-861	45	30/45	50+09.3	47.5 R	
R25	w	L-861	45	30/45	48+22.4	47.5 R	
R26	W	L-861	45	30/45	46+35.5	47.5 R	
R27	w	L-861	45	30/45	44+48.6	47.5 R	
R28	w	L-861	45	30/45	42+61.6	47.5 R	
R29	w	L-861	45	30/45	40+74.7	47.5 R	
R30	w	L-861	45	30/45	38+87.8	47.5 R	
R31	w	L-861	45	30/45	37+00.9	47.5 R	
R32	w	L-861	45	30/45	35+13.9	47.5 R	
R33	w	L-861	45	30/45	33+27.0	47.5 R	
R34	G/R	L-861E	45	30/45	31+40.1	47.5 R	
R35	G/R	L-861E	45	30/45	31+40.1	57.5 R	
R36	G/R	L-861E	45	30/45	31+40.1	67.5 R	

STANTEC CONSULTING SERVICES INC. 725 EAST FIREWEED LANE, SUITE 200 ANCHORAGE, AK 99503-2245 (907) 276-4245 CERTIFICATE OF AUTHORIZATION # 126386			PD//SION	STATE OI DEPARTMENT OF AND PUBLIC CENTRAI 4111 AVIATION AVE., AN
120300	BY	DATE	REVISION	PHONE (90

R31	W	1
R32	w	
R33	w	
R34	G/R	L
R35	G/R	L
R36	G/R	L

	TAXIWAY EDGE LIGHT SCHEDULE									
LENS OLOR	TYPE	LAMP WATTAGE	XFMR WATTAGE	STATION	OFFSET	REMARKS				
в	L-861T	30	30/45	31+77.6	334.3 L					
в	L-861T	30	30/45	31+39.8	332.6 L					
В	L-861T	30	30/45	31+02.0	330.8 L					
в	L-861T	30	30/45	30+64.3	329.1 L					
В	L-861T	30	30/45	30+30.0	319.0 L					
в	L-861T	30	30/45	29+95.6	309.0 L					
в	L-861T	30	30/45	29+85.6	274.7 L					
в	L-861T	30	30/45	29+75.5	240.4 L					
В	L-861T	30	30/45	29+73.8	201.8 L					
В	L-861T	30	30/45	29+73.8	163.2 L					
в	L-861T	30	30/45	29+75.5	124.7 L					
в	L-861T	30	30/45	29+85.6	90.4 L					
в	L-861T	30	30/45	29+95.6	56.1 L					
В	L-861T	30	30/45	30+24.8	47.5 L					
В	L-861T	30	30/45	30+63.2	47.5 L					
в	L-861T	30	30/45	31+01.7	47.5 L					
в	L-861T	30	30/45	31+01.7	47.5 R					
в	L-861T	30	30/45	30+63.2	47.5 R					
в	L-861T	30	30/45	30+24.8	47.5 R					
в	L-861T	30	30/45	29+95.6	47.5 R					
В	L-861T	30	30/45	29+53.9	47.5 R					
В	L-861T	30	30/45	29+12.1	47.5 R					
В	L-861T	30	30/45	29+12.1	13.0 R					
В	L-861T	30	30/45	29+12.1	21.5 L					
в	L-861T	30	30/45	29+12.1	56.1 L					
в	L-861T	30	30/45	29+12.1	90.4 L					
в	L-861T	30	30/45	29+12.1	124.7 L					
в	L-861T	30	30/45	29+12.1	163.2 L					
в	L-861T	30	30/45	29+12.1	201.8 L					
в	L-861T	30	30/45	29+12.1	240.4 L					
в	L-861T	30	30/45	29+12.1	274.7 L					
в	L-861T	30	30/45	29+12.1	309.0 L					

HANDHOLE SCHEDULE									
/PE	SIZE	STATION	OFFSET	REMARKS					
I	В	28+00.1	485.1 L						
I .	В	28+19.2	349.2 L						
I.	В	28+08.4	537.2 L						
I.	В	32+08.6	537.2 L						
I	В	32+63.0	492.1 L						
I	В	27+68.5	497.4 L						

NOTES: 1. LOCATIONS ARE APPROXIMATE, FIELD LOCATE HANDHOLES IN COORDINATION WITH THE ENGINEER BASED ON SITE CONDITIONS, SURROUNDING GRADES AND EQUIPMENT, AND CONDUIT ROUTING.


OF ALASKA TRANSPORTATION IC FACILITIES AL REGION ANCHORAGE ALASKA 99502 907) 269-0590

NUNAPITCHUK AIRPORT NUNAPITCHUK, ALASKA NUNAPITCHUK AIRPORT IMPROVEMENTS PROJECT No. CFAPT00427 AIP No. 3-02-0446-00X-20XX SCHEDULES

SHEET:

06/27/2019

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### Surveyor's Certificate

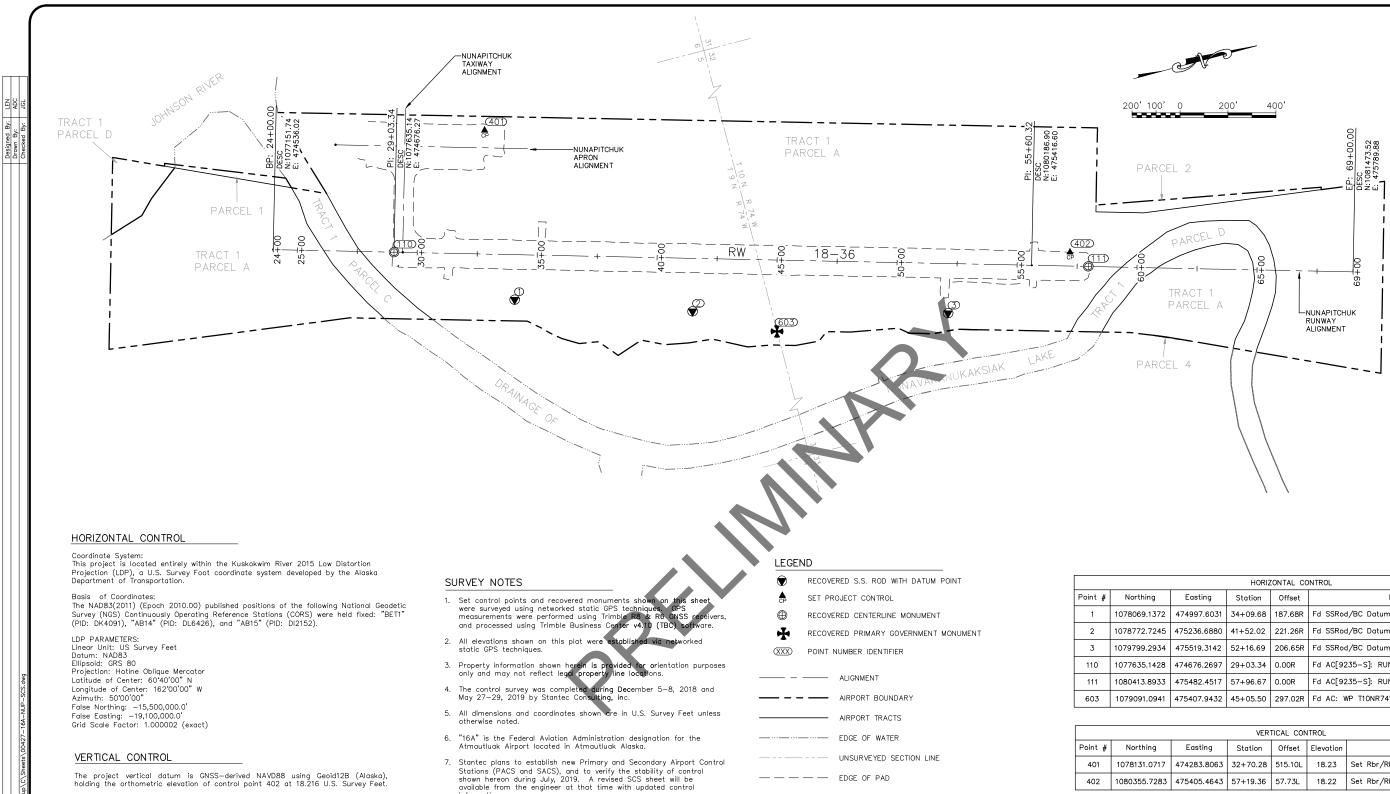I hereby certify that I am properly Registered and Licensed to practice Land Surveying in the State of Álaska, and that this drawing represents a survey made by me or under my direct supervision, and that the monuments shown hereon actually exist as described, and that all dimensions and other details are correct to the extent shown hereon.

information.

STANTEC CONSULTING SERVICES INC. 725 EAST FIREWEED LANE, SUITE 200 ANCHORAGE, AK 99503-2245 (907) 276-4245 CERTIFICATE OF AUTHORIZATION # 126386	BY	DATE	REVISION	STATE O DEPARTMENT OF AND PUBLIC CENTRA 4111 AVIATION AVE., AN PHONE (90
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Dean Cimmiyotti LS-7613

Date

	HORIZONTAL CONTROL									
)	Easting	Station	Offset	Description						
372	474997.6031	34+09.68	187.68R	Fd SSRod/BC Datum Point[DOT]: GPS NUP-1 2011						
245	475236.6880	41+52.02	221.26R	Fd SSRod/BC Datum Point[DOT]: GPS NUP-2 2011						
934	475519.3142	52+16.69	206.65R	Fd SSRod/BC Datum Point[DOT]: GPS NUP-3 2011						
128	474676.2697	29+03.34	0.00R	Fd AC[9235-S]: RUNWAY CENTERLINE 2011						
933	475482.4517	57+96.67	0.00R	Fd AC[9235-S]: RUNWAY CENTERLINE 2011						
941	475407.9432	45+05.50	297.02R	Fd AC: WP T10NR74W S32 S5 T9N 1977						

VERTICAL CONTROL									
Northing	Easting	Station	Offset	Elevation	Description				
1078131.0717	474283.8063	32+70.28	515.10L	18.23	Set Rbr/RPC[STANTEC]: CONTROL POINT				
1080355.7283	475405.4643	57+19.36	57.73L	18.22	Set Rbr/RPC[STANTEC]: CONTROL POINT				

F ALASKA TRANSPORTATION C FACILITIES L REGION ICHORAGE ALASKA 99502 07) 269-0590


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NUNAPITCHUK AIRPORT NUNAPITCHUK, ALASKA NUNAPITCHUK AIRPORT IMPROVEMENTS PROJECT No. CFAPT00427 AIP No. 3-02-0446-00X-20XX SURVEY CONTROL

SHEET:

06/27/2019

AB1 of AB<sup>1</sup>

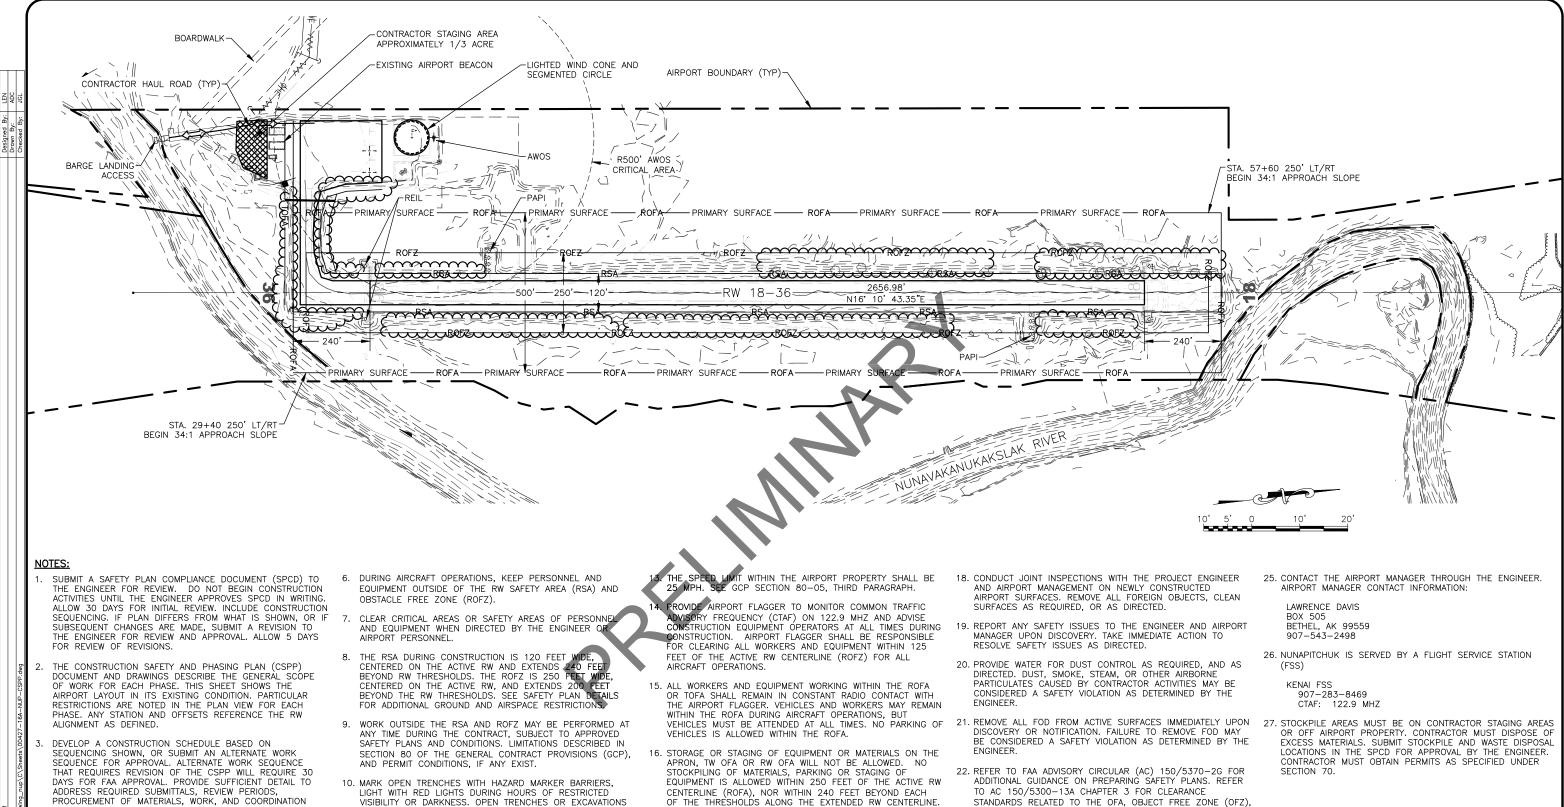

- REQUIREMENTS
- WHENEVER THE PLANS OR SPECIFICATIONS CALL FOR COORDINATION, NOTIFICATION, CONTACT, OR OTHER INTERACTION WITH THE FEDERAL AVIATION ADMINISTRATION (FAA), AIRPORT MANAGEMENT, MAINTENANCE AND OPERATIONS. RPORT TENANTS, AIRPORT USERS, ANY LOCAL, STATE, OR FEDERAL AGENCY, GROUP, OR ASSOCIATION, OR THE GENERAL PUBLIC, SUCH ACTIVITY SHALL BE DONE THROUGH IN THE PRESENCE OF, OR WITH THE WRITTEN APPROVAL OF THE ENGINEER. ALLOW SUFFICIENT TIME FOR COORDINATION AND APPROVALS WITHIN PROPOSED WORK SCHEDULES.
- NIGHT TIME CLOSURES OF THE RW WILL BE REQUIRED TO 5. COMPLETE THIS PROJECT. COORDINATE WITH AIRPORT MANAGEMENT AND AIRPORT USERS TO ESTABLISH HOURS FOR NIGHT TIME CLOSURES. SUBMIT PROPOSED CLOSURE TIMES AS PART OF THE CPM AND WORK SCHEDULES. DISABLE OR COVER RW EDGE LIGHTS AND THRESHOLD LIGHTS DURING RW CLOSURES

- VISIBILITY OR DARKNESS. OPEN TRENCHES OR EXCAVATIONS ARE NOT PERMITTED WITHIN THE RSA WHILE THE RW IS OPEN. IF THE RW IS OPENED BEFORE EXCAVATIONS ARE BACKFILLED, COVERS FOR TRENCHES OR EXCAVATIONS MUST BE OF SUFFICIENT STRENGTH TO SUPPORT THE WEIGHT OF THE HEAVIEST AIRCRAFT OPERATING ON THE RW.
- 11. EQUIPMENT WILL ONLY BE PERMITTED INSIDE THE AIR OPERATIONS AREA AS APPROVED BY THE ENGINEER.
- 12. CONDUCT FOREIGN OBJECT AND DEBRIS (FOD) INSPECTION AND RW/TW CLEANING REQUIRED PRIOR TO THE END OF EVERY SHIFT. CLEANING SHALL BE SUBSIDIARY TO RELATED SEE GCP SECTION 40-05.

- OF THE THRESHOLDS ALONG THE EXTENDED RW CENTERLINE.
- 17. CARRYOUT CONTINUING COORDINATION THROUGH THE ENGINEER USING WEEKLY BRIEFINGS WITH AIRPORT MANAGEMENT, AIRPORT MAINTENANCE, FAA CONTRACTORS AND AIRPORT USERS TO KEEP EVERYONE AWARE OF THE STATUS AND CHANGES OF AIRPORT SURFACES IN RELATION TO AIRCRAFT AND GROUND TRAFFIC. PROVIDE DETAILED DRAWINGS INDICATING TRAFFIC ROUTES FOR AIRCRAFT GROUND TRAFFIC, AND PASSENGERS. INDICATE AREAS CLOSED TO AIRCRAFT MOVEMENT AND PARKING. PROVIDE UPDATED DRAWINGS AS CONSTRUCTION PROCEEDS.

- AND RSA. REFER TO PARAGRAPH 303 IN THE AC REGARDING RW END SITING CRITERIA. NOTICE THAT THE MOST RESTRICTIVE CRITERIA GOVERNS.
- 23. NUNAPITCHUK IS AN APPROACH CATEGORY A AND DESIGN GROUP I AIRPORT WITH APPROACH VISIBILITY MINIMUM OF ONE STATUTE MILE.
- 24. FIELD VERIEY SUITABILITY OF HAUL ROUTES AND STAGING AREAS SHOWN. DEVELOP AND MAINTAIN HAUL ROUTES AS REQUIRED. SEE SECTIONS 40-04, 60-06 & 70-11G. PROVIDE TRAFFIC CONTROL PLANS FOR EACH PHASE OF WORK SEE SECTION G-710

STANTEC CONSULTING SERVICES INC. 725 EAST FIREWEED LANE. SUITE 200				STATE O DEPARTMENT OF
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126386	BY	DATE	REVISION	PHONE (90

LEGEND:

F ALASKA TRANSPORTATION C FACILITIES L REGION ICHORAGE ALASKA 99502 7) 269-0590

NUNAPITCHUK, ALASKA NUNAPITCHUK AIRPORT IMPROVEMENTS PROJECT No. CFAPT00427 HEET: AIP No. 3-02-0446-00X-20XX

- HAUL ROUTE (TWO WAY)


CONTRACTOR STAGING AREA

NUNAPITCHUK AIRPORT

CONSTRUCTION SAFETY AND PHASING OVERVIEW

AD1 oF AD4

06/27/2019

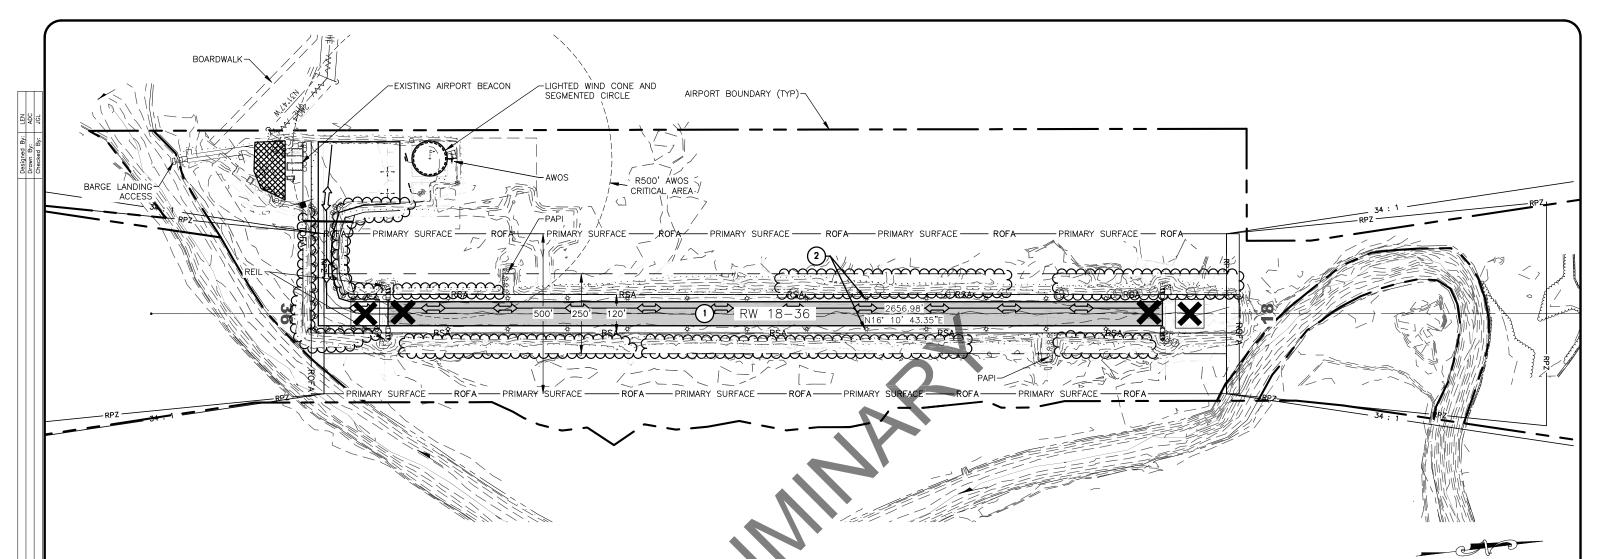

### ANTICIPATED PROJECT SCHEDULE

MAY 30, 2022	BEGIN PROJECT
JUNE 15, 2022	NIGHTTIME RW CLOSURES BEGIN
JULY 15, 2022	LIGHTING REPLACEMENT AND RW RESURFACING COMPLETE. END NIGHTTIME CLOSURES. END PHASE 1.
AUGUST 30, 2022	END PHASE 2.
SEPTEMBER 15, 2022	SUBSTANTIAL COMPLETION.

SEPTEMBER 30, 2022 FINAL ACCEPTANCE.

WORK ITEMS CAN BE COMPLETED IN ANY SEQUENCE, AS APPROVED BY THE ENGINEER.

ANTICIPATED PROJECT SCHEDULE IS AN ESTIMATED TIME LINE TO FAA FOR WHEN PROJECT MAY BE COMPLETED. DEVELOP A CPM SCHEDULE MEETING CONTRACT MILESTONES FOR REVIEW WITH SPCD.

### PHASE 1 CONSTRUCTION TASKS

THE FOLLOWING LIST IS A GENERAL DESCRIPTION OF WORK TO, THE FOLLOWING LIST IS A GENERAL DESCRIPTION OF WORK TO BE COMPLETED IN THIS PHASE. IT IS NOT INTENDED AS A COMPREHENSIVE LIST OF ALL TASKS, OR RELATED WORK THAT WILL BE REQUIRED. THE LIST BELOW DOES NOT RELIEVE THE CONTRACTOR OF RESPONSIBILITY TO COORDINATE AND SCHEDULE THE WORK WITH AFFECTED INDIVIDUALS OR SILITY TO GROUPS, PRIOR TO BEGINNING WORK. INCLUDE ANY ADDITIONAL OR RELATED WORK AND GENERAL TASKS IN THE WORK SCHEDULE REQU UNDER SECTION 80 AND SECTION G-300. PHASE 2 WORK CAN BE REQUIRED PERFORMED CONCURRENTLY WITH PHASE 1.

### 1 RESURFACE RW

(2) REPLACE AIRPORT LIGHTING SYSTEM

### GENERAL PHASING NOTES

ISTED MAY REQUIRE CONCURRENT WORK. ALL WORK MUST BE ACCOMPLISHED ACCORDING TO THE LIMITATIONS IN THE CONSTRUCTION SAFETY AND PHASING PLAN, APPLICABLE SPECIAL PROVISIONS, ENVIRONMENTAL COMMITMENTS, AND PERMIT CONDITIONS

OPEN TRENCHES ARE NOT ALLOWED IN THE RSA WHILE THE RUNWAY IS OPEN, PER AC 150-5370-2, 2.22.1.4.1. CONTRACTOR SHALL BACKFILL OR COVER OPEN TRENCHES WITH STEEL ROAD PLATES PRIOR TO OPENING RUNWAY FOR AIRCRAFT OPERATIONS.

### PHASE 1 NOTES

- CLOSE RUNWAY AT NIGHT FOR WORK WITHIN THE RSA AND 1. ROFZ, COORDINATE WITH AIRPORT USERS TO ACCOMMODATE ALL SCHEDULED FLIGHTS. COORDINATE WITH AIRPORT MANAGEMENT FOR ISSUANCE OF PROPER NOTAM'S. INSTALL ILLUMINATED RW CLOSURE AND RW CLOSURE 'X' MARKERS IMMEDIATELY UPON NOTIFICATION OF RW CLOSURE COORDINATE WITH AIRPORT MANAGEMENT TO TURN OFF RW LIGHTS. TW LIGHTS. AND AIRPORT BEACON DURING CLOSURES. PLACE REFLECTIVE TEMPORARY EDGE MARKERS THAT CORRELATE TO EXISTING LIGHT POSITIONS.
- 2. DURING RW CLOSURES THE CONTRACTOR WILL TAKE ALL ACTIONS REQUIRED OR AS DIRECTED TO READY THE AIRFIELD TO ACCOMMODATE ALL MEDEVAC FLIGHTS IF NEEDED. ANY AIRCRAFT DECLARING AN EMERGENCY WILL BE ALLOWED TO LAND.

- 3. NIGHT TIME CLOSURES WILL COMMENCE 30 MINUTES AFTER LAST SCHEDULED DEPARTURE, AND END 30 MINUTES PRIOR TO THE FIRST SCHEDULED ARRIVAL THE FOLLOWING DAY.
- AT THE END OF EACH SHIFT, TRANSITIONS WILL BE CONSTRUCTED WITH SUITABLE MATERIAL TO KEEP THE RW 4. OPEN AND OPERATIONAL DURING DAYTIME HOURS. TRANSITIONS SHALL BE APPROVED BY THE ENGINEER PRIOR TO RW OPENING FACH DAY
- 6. DURING AIRCRAFT OPERATIONS ALL PERSONS AND EQUIPMENT MUST BE AT LEAST 125 FEET AWAY FROM ACTIVE RW CENTERLINE (ROFZ), AND 240 FEET BEYOND RW ENDS PERSONS AND EQUIPMENT MUST NOT PENETRATE APPROACH SURFACES. THE LOCATION OF THE 34:1 APPROACH SURFACES ARE SHOWN ON AD1.
- STOCKPILES WILL NOT PENETRATE APPROACH SURFACES 7. SHOWN. THE LOCATION OF THE 34:1 APPROACH SURFACES ARE SHOWN ON AD1.
- 8. PROVIDE A TEMPORARY LIGHTING SYSTEM WHILE REPLACING RW LIGHTING SYSTEM.

ST	ANTEC CONSULTING SERVICES INC.				STATE OF
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1'	ANCHORAGE. AK 99503-2245				
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	126386	BY	DATE	REVISION	PHONE (907

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### LEGEND:







HAUL ROUTE (TWO WAY) CONTRACTOR STAGING AREA

PHASE 1 CONSTRUCTION AREA

RW CLOSURE MARKER

ILLUMINATED RW CLOSURE MARKER


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NUNAPITCHUK AIRPORT NUNAPITCHUK, ALASKA NUNAPITCHUK AIRPORT IMPROVEMENTS PROJECT No. CFAPT00427 AIP No. 3-02-0446-00X-20XX CONSTRUCTION SAFETY AND PHASING PHASE 1

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AD2 oF AD4



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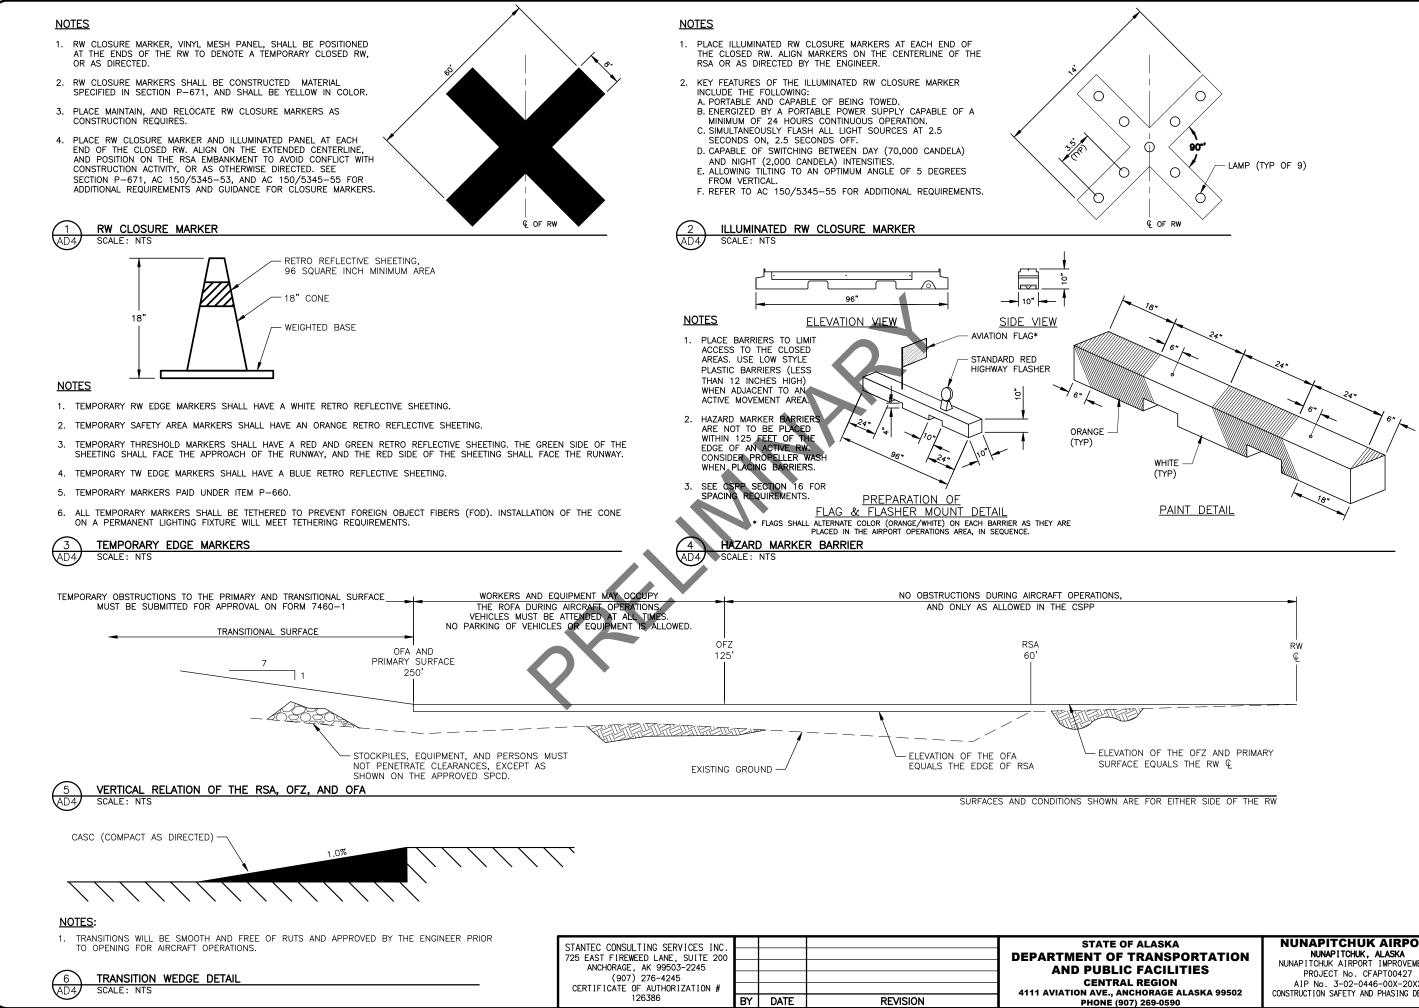
OF ALASKA F TRANSPORTATION IC FACILITIES AL REGION INCHORAGE ALASKA 99502 907) 269-0590 NUNAPITCHUK AIRPORT NUNAPITCHUK, ALASKA NUNAPITCHUK AIRPORT IMFROVEMENTS PROJECT No. CFAPTO0427 AIP No. 3-02-0446-00X-20XX CONSTRUCTION SAFETY AND PHASING PHASE 2

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AD3 oFAD4

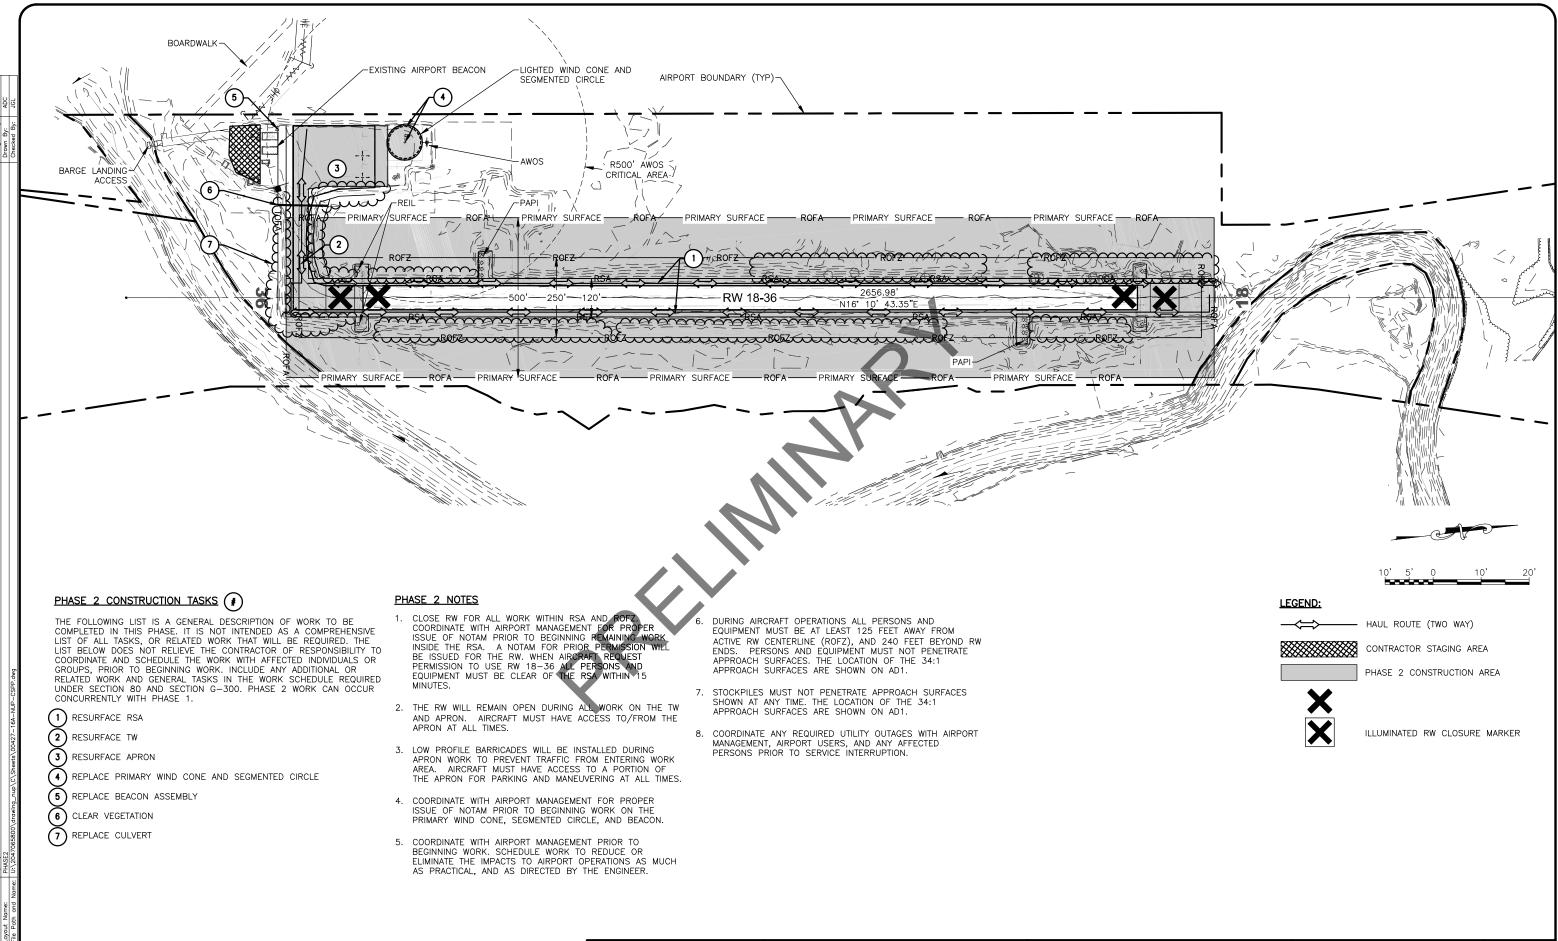

NUNAPITCHUK AIRPORT NUNAPITCHUK, ALASKA NUNAPITCHUK AIRPORT IMPROVEMENTS PROJECT No. CFAPT00427 AIP No. 3-02-0446-00X-20XX CONSTRUCTION SAFETY AND PHASING DETAILS

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AD4 o⊧AD4