
ALASKA CENTRAL REGION LOCATION MAP

NOT TO SCALE

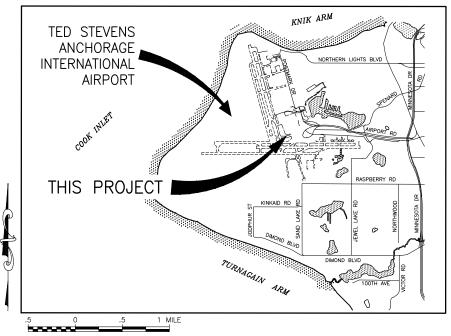

T 13 N, R 4 W, SEC. 32, 33, 34, & 35 SEWARD MERIDIAN U.S.G.S. ANCHORAGE (A-8), ALASKA

CONSTRUCTION PLANS TED STEVENS

ANCHORAGE INTERNATIONAL AIRPORT

ANCHORAGE, ALASKA ANC TAXILANE V GATE RECONSTRUCTION PROJECT No. CFAPT01278 **AIRPORT IMPROVEMENT PROGRAM** No. 3-02-0016-XXX-2025

> **PS&E REVIEW FEBRUARY 2025**

APPROVED DATE LUKE BOWLAND, P.E REGIONAL PRECONSTRUCTION ENGINEER **APPROVED** JENNIFER PEPIN. P.E DEPUTY DIRECTOR, ENGINEERING & ENVIRONMENTAL **APPROVED** DATE JENNIFER LOMBARDO, P.E. CONCUR DATE JOEL G. ST. AUBIN, P.E.

STANTEC CONSULTING SERVICES INC 3900 C ST SUITE 902 ANCHORAGE, AK 99503-2245 (907) 276-4245 CERTIFICATION OF AUTHORIZATION #126386

REVISION BY DATE

STATE OF ALASKA **DEPARTMENT OF TRANSPORTATION AND PUBLIC FACILITIES CENTRAL REGION**

4111 AVIATION AVE., ANCHORAGE ALASKA 99502


PHONE (907) 269-0590


ANCHORAGE, ALASKA ANC TAXILANE V GATE RECONSTRUCTION PROJECT No. CFAPT01278 AIP NUMBER 3-02-0016-XXX-2025 TITLE, SIGNATURES, LOCATION MAP, AND VICINITY MAP


TED STEVENS ANCHORAGE 02/07/2025

1 of 15


	INDE	X	LEGEND				STIMATED QUAN	NTITIES	
	SHEET TITLE	SHEET No.	DESCRIPTION	EXISTING	PROPOSED	No.	ITEM		UANTITY
	TITLE, SIGNATURES, LOCATION MAP, AND VICINITY MAP	1	UDDOT PROFEST PAULOUS			F162.010.0008	8-FEET CHAIN-LINK FENCE	LF	43
200	INDEX, ABBREVIATIONS, LEGEND, AND ESTIMATED QUANTITIE	2	AIRPORT PROPERTY BOUNDARY			F162.060.0120	DOUBLE CANTILEVER GATE, 120-FEET WIDE	EACH	1
By: LE	DEMOLITION PLAN	3	BUILDING			F162.130.0000	RELOCATE CHAIN-LINK FENCE	LF	55
Designed By: LEN Drawn By: JAG Checked By: EJG	SITE PLAN	4	BOLLARD	0	0	F170.010.0000	STEEL BOLLARD	EACH	19
مُ مُ مُ		,	TAXILANE CENTERLINE				POWER GATE OPERATOR SYSTEM	EACH	1
	DETAILS	5–9	CONCRETE						
	ELECTRICAL DEMOLITION PLAN	E1	CONTOUR LINE	_ <i></i> 85		F171.030.0000		EACH	1
	ELECTRICAL NEW WORK PLAN	E2	DEMOLITION		<i>'////////////</i>		MOBILIZATION AND DEMOBILIZATION	LS	ALL REQ'D
	ELECTRICAL DETAILS	E3-E6	ELECTRICAL CONDUIT	———UE ———		G135.010.0000	CONSTRUCTION SURVEYING BY THE CONTRACTOR	LS	ALL REQ'D
			ELECTRICAL TAXILANE CONDUIT			G135.020.0000	EXTRA THREE PERSON SURVEY PARTY	HR	10
			ELECTRICAL MANHOLE			G150.030.0000	EQUIPMENT RENTAL, VAC-TRUCK	CS	ALL REQ'D
			ELECTRICAL PANEL	¢		G300.010.0000	CPM SCHEDULING	LS	ALL REQ'D
			FENCE	x x	x x	G700.040.0000	TRAFFIC CONTROL FOR AIRPORTS	CS	ALL REQ'D
			FUEL LINE	—— F ——		L125.500.0000	MISCELLANEOUS AIRPORT ELECTRICAL WORK	CS	ALL REQ'D
			GATE	xx	xx	P152.010.0000	UNCLASSIFIED EXCAVATION	CY	120
			GUARDRAIL			P160.010.0000	EXCAVATION OF PAVEMENT, AC	SY	65
	APPENDIX DI	RAWINGS	HAUL ROUTE (TWO WAY)		\Longrightarrow	P161.020.0000	RECYCLED ASPHALT PAVEMENT	CY	11
			IDENTIFICATION BUBBLE		1		REMOVAL OF STRUCTURES	LS	ALL REQ'D
	SHEET TITLE	SHEET No.	LIGHTS (TAXILANE)	- * -			HOT MIX ASPHALT TYPE II, CLASS A	TON	
	EROSION AND SEDIMENT CONTROL PLAN	AA1 – AA3	LIGHTS (LIGHT POLE)		□>				10
	SURVEY CONTROL	AB1	PAINT STRIPE				ASPHALT BINDER, PG 58–34E	TON	1
	CONSTRUCTION SAFETY AND PHASING PLAN	AC1-AC3	PAVEMENT/SHOULDER (EDGE)			P641.010.0000	EROSION, SEDIMENT, AND POLLUTION CONTROL ADMINISTRATION	LS	ALL REQ'D
	ADDDEVIA	ATIONS	POINT NUMBER		(1001)	P641.020.0000	TEMPORARY EROSION, SEDIMENT, AND POLLUTION CONTROL	CS	ALL REQ'D
	ABBREVIA	AIIONS	POST	0	•	P641.060.0000	WITHHOLDING	CS	ALL REQ'D
	AND		SIGN			P641.070.0000	SWPPP MANAGER	LS	ALL REQ'D
	ACI AMERICAN CONCRETE INSTITUTE ADG AIRPLANE DESIGN GROUP	MAX MAXIMUM MIN MINIMUM	STORM DRAIN LINE (UNDERGROUND)	——— SD ———		P641.110.0000	SWPPPTRACK	CS	ALL REQ'D
1 1	ALUM ALUMINUM CB CATCH BASIN	NTS NOT TO SCALE OC ON CENTER	STORM DRAIN MANHOLE	© MH		P670.010.0000	HAZARD MARKER BARRIER, PLASTIC	EACH	20
Est O	CMP CORRUGATED METAL PIPE	O.D. OUTSIDE DIAMETER	TOFA (TAXIWAY/TAXILANE OBJECT FREE AREA)	— TOFA —— —		T901.020.0000	SEEDING	LB	13
	CS CONTINGENT SUM CSPP CONSTRUCTION SAFETY & PHASING PLAN	PCC PORTLAND CEMENT CONCRETE PSI POUND PER SQUARE INCH	TSA (TAXIWAY/TAXILANE SAFETY AREA)			T905.010.0020	TOPSOILING, CLASS B	SY	278
	CY CUBIC YARD	REQ'D REQUIRED	ISA (IAMWAT/IAMLANE SAFETT AREA)	——— TSA ———					
4D ESTII	DIA DIAMETER E EAST	RT RIGHT SD STORM DRAIN							
SEND At	EA EACH F FUEL	SF SQUARE FOOT TDG TAXIWAY DESIGN GROUP					ESTIMATING FAC	TORS	
3 PM ONS LE drawing		TL TAXILANE				No.	ITEM	F/	ACTOR
[-[8]8]	GA GALVANIZED STEEL GB GRADE BREAK	TOFA TAXIWAY/TAXILANE OBJECT FREE AREA TSA TAXIWAY/TAXILANE SAFETY AREA				P401.010.0030	HOT MIX ASPHALT TYPE II, CLASS A	2	.05 TON/CY
일일이	HMA HOT MIX ASPHALT	TYP TYPICAL							•
	HR HOUR BC INTERNATIONAL BUILDING CODE	UE ELECTRIC LINE (UNDERGROUND)				P401.040.5834	ASPHALT BINDER, PG 58-34E		5% OF P401
sed: ame:	KSI KILO POUNDS PER SQUARE INCH LENGTH	UCOM COMMUNICATION LINE (UNDERGROUND) W WATER, WEST				T901.020.0000	SEEDING		5 LBS/1000SF
[등 등 등	LS LUMP SUM	w/ with	F AL AS						
	_T LEFT No. NUMBER		STANTEC CONSULTING SERVICES INC.				TATE OF ALASKA IT OF TRANSPORTATION ANCHORAGE ANCHORAGE	ALASKA	DATE: 02/07/2025
١	NTS NOT TO SCALE	& : Evan	3900 C ST SUTTE 902 ANCHORAGE, AK 99503–2245 E-10003 (907) 276–4245			AND P	UBLIC FACILITIES ANC TAXILANE V GATE PROJECT No. (E RECONSTRUCTION CFAPT01278	SHEET:
()	MH MANHOLE	in the second se	CERTIFICATION OF AUTHORIZATION	BY DATE RE	VISION	4111 AVIATION	ENTRAL REGION AVE., ANCHORAGE ALASKA 99502 INDEX, ABBREVIAT ONE (907) 269-0590 AND ESTIMATED	TIONS, LEGEND,	2 of 15

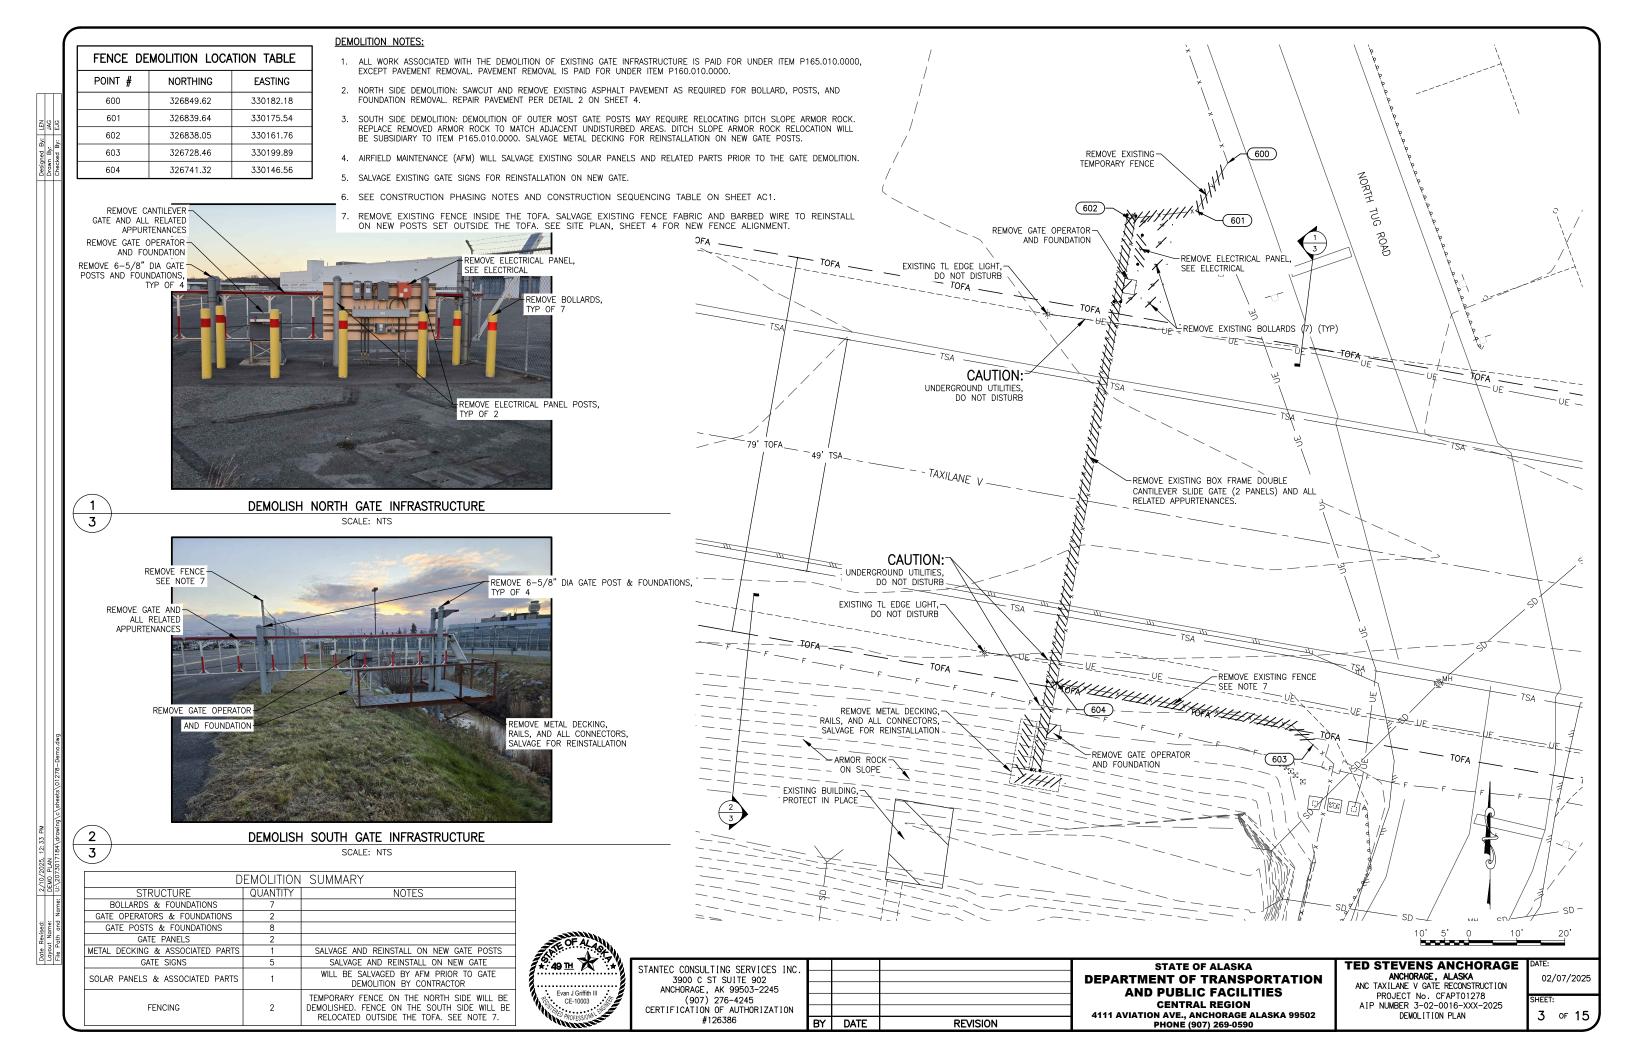

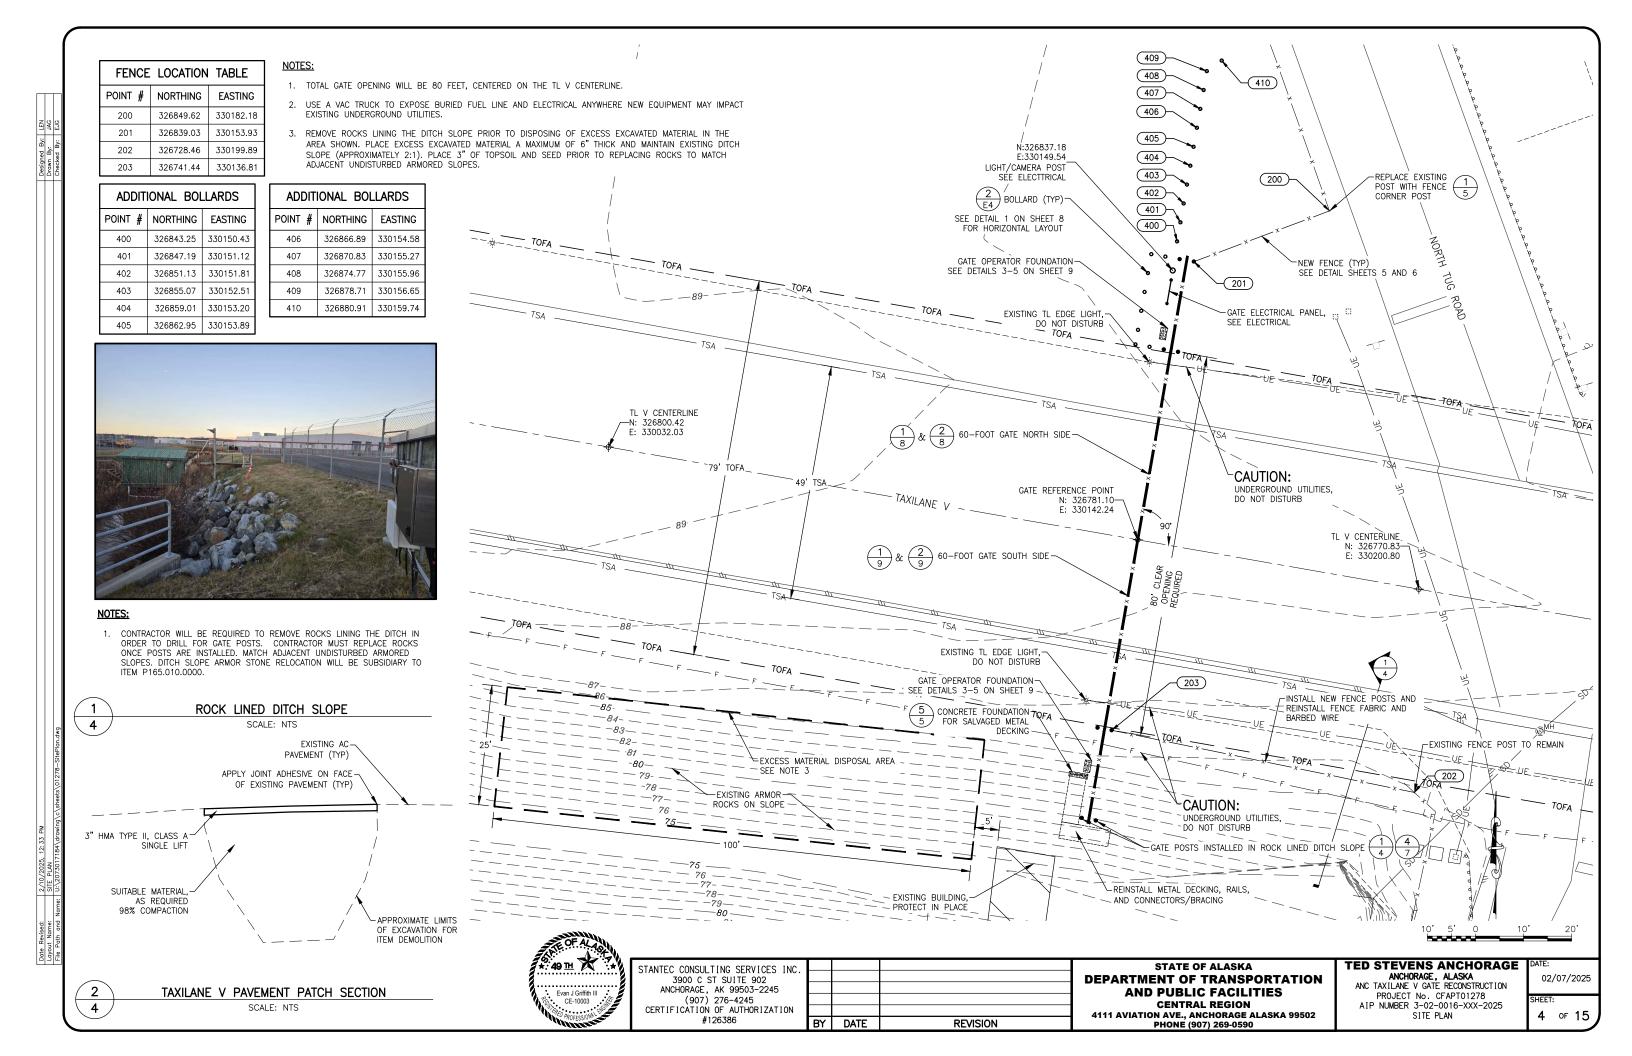

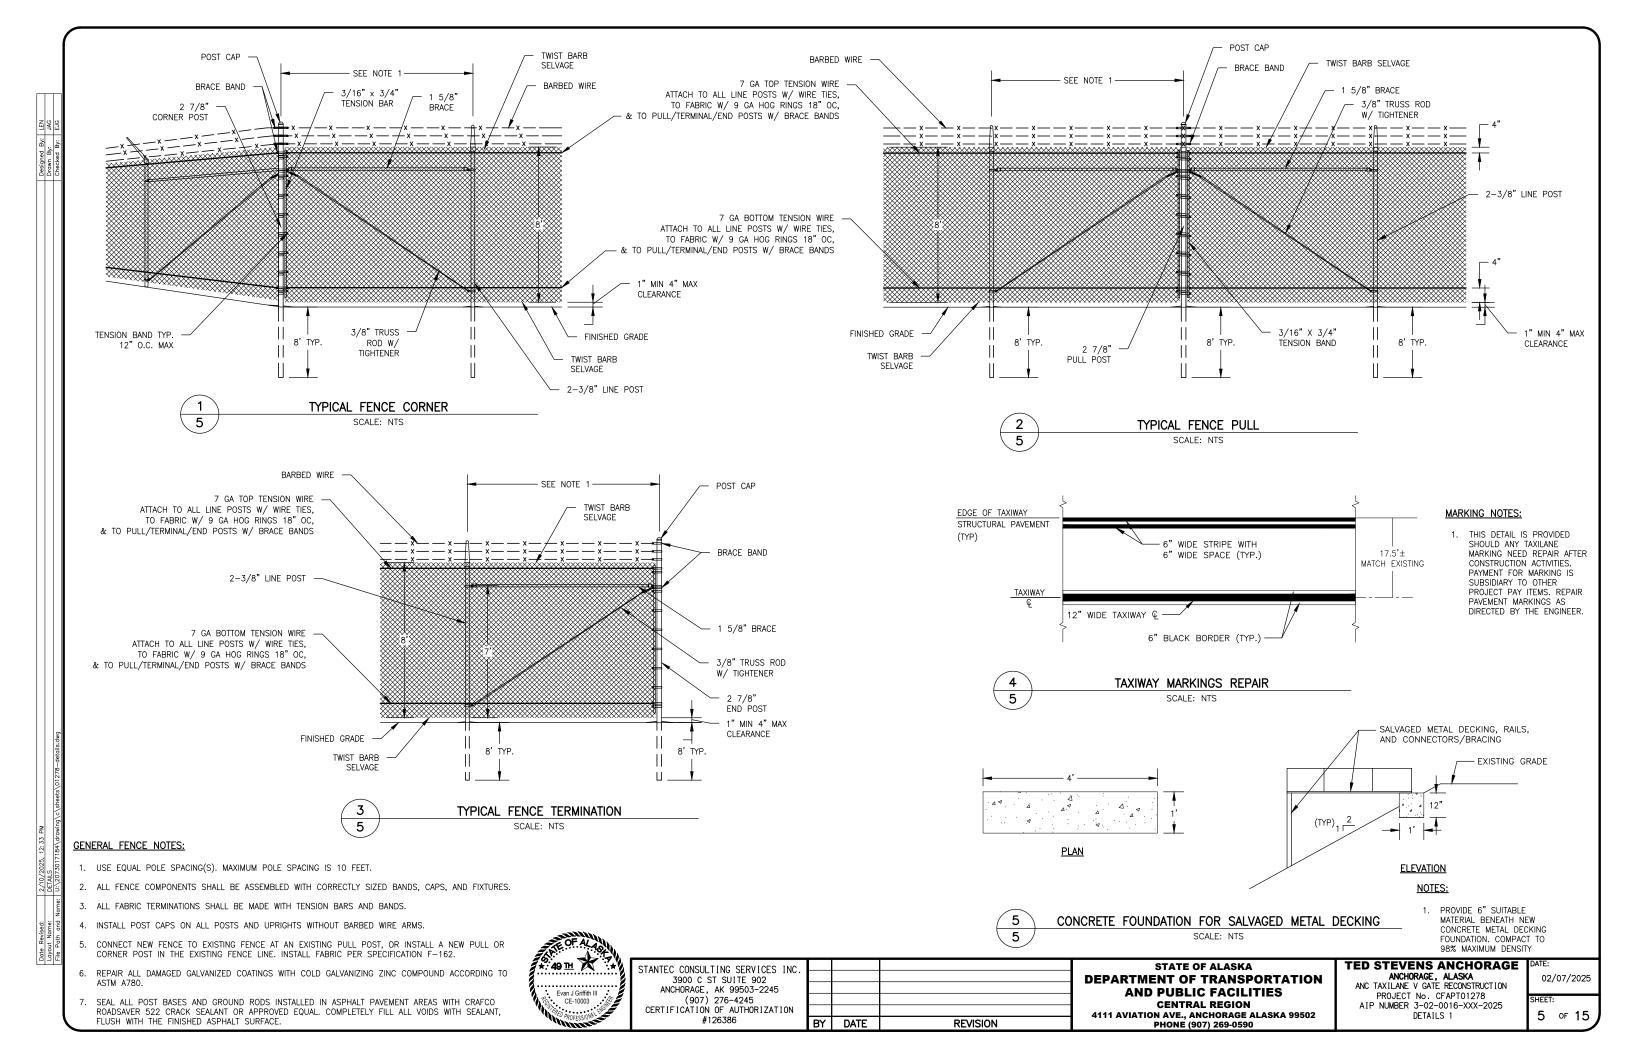



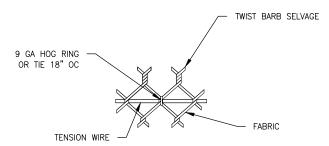

FABRIC TO TENSION WIRE FASTENERS 6 SCALE: NTS



BRACE BAND




TENSION BAND

NOTES:


TENSION/BRACE BANDS MUST BE SIZED BASED ON FENCE OR GATE POST DIAMETER.



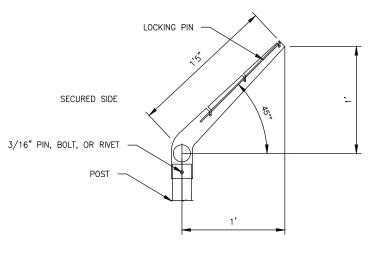


LINE POST BARBED WIRE ARM SCALE: NTS


POST CAP FOR PULL/CORNER/END/GATE POSTS 4 6 SCALE: NTS

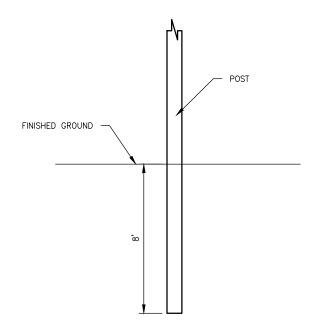


POST FOUNDATIONS 6 SCALE: NTS

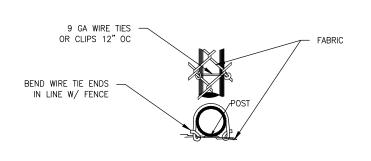

FABRIC TO POST FASTENERS 6 SCALE: NTS

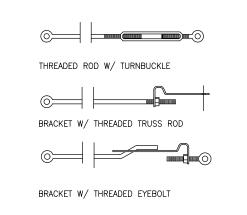

TRUSS ROD W/TIGHTENER 6 SCALE: NTS

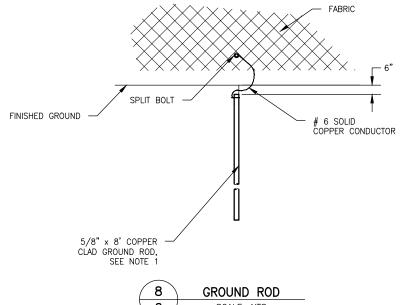

6 SCALE: NTS

GENERAL FENCE NOTES:

- ELECTRICAL GROUNDS SHALL BE INSTALLED ALONG THE FENCE WITH A MAXIMUM SPACING OF 500 FEET AND DIRECTLY BELOW ANY OVERHEAD ELECTRICAL LINE CROSSINGS. INSTALL AT LEAST ONE GROUND ROD FOR EACH STRAIGHT FENCE SECTION AND ON EACH SIDE OF ANY GATES.
- 2. ATTACH TRUSS ROD & TIGHTENER TO POSTS WITH BRACE BANDS



STANTEC CONSULTING SERVICES INC 3900 C ST SUITE 902 ANCHORAGE, AK 99503-2245 (907) 276-4245 CERTIFICATION OF AUTHORIZATION #126386

REVISION BY DATE

STATE OF ALASKA **DEPARTMENT OF TRANSPORTATION** AND PUBLIC FACILITIES

CENTRAL REGION 4111 AVIATION AVE., ANCHORAGE ALASKA 99502 PHONE (907) 269-0590

TED STEVENS ANCHORAGE
ANCHORAGE, ALASKA
ANC TAXILANE V GATE RECONSTRUCTION

DATE
OF

PROJECT No. CFAPT01278 AIP NUMBER 3-02-0016-XXX-2025 DETAILS 2 02/07/2025

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NOTES:

1. SALVAGE 2 SIGNS FROM EXISTING GATE AND REINSTALL ON NEW GATE. REUSE EXISTING STAINLESS STEEL HARDWARE OR PROVIDE NEW, AS APPROVED BY THE ENGINEER. THIS WORK IS SUBSIDIARY TO ITEM F162.060.0120, INSTALL IN SIMILAR LOCATION ON NEW GATE PANEL AS DIRECTED BY THE



GATE ACCESS SIGN

SCALE: NTS



NOTES:

SALVAGE 2 SIGNS FROM EXISTING GATE AND REINSTALL ON NEW GATE. REUSE EXISTING STAINLESS STEEL HARDWARE OR PROVIDE NEW, AS APPROVED BY THE ENGINEER. THIS WORK IS SUBSIDIARY TO ITEM F162.060.0120. INSTALL IN SIMILAR LOCATION ON NEW GATE PANEL AS DIRECTED BY THE




AIRFIELD GATE DESIGNATION SIGN

SCALE: NTS



1 SALVAGE 1 SIGNS FROM ORIGINAL GATE AND REINSTALL ON NEW TL V GATE REUSE EXISTING STAINLESS STEEL HARDWARE OR PROVIDE NEW, AS APPROVED BY THE ENGINEER. THIS WORK IS SUBSIDIARY TO ITEM F162.060.0120.

> RESTRICTED AREA SIGN SCALE: NTS Evan J Griffith III CE-10003

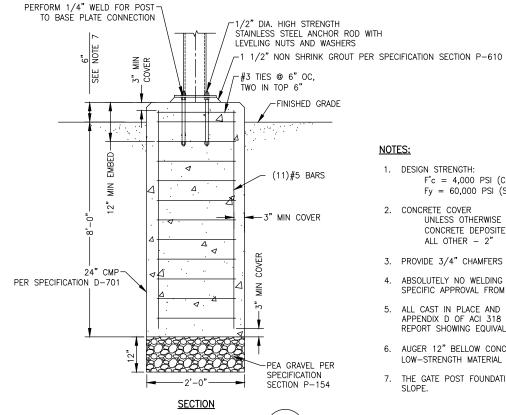

-24" DIA 6'-0" DEED CONCRETE 3/4" SQUARE BASE FLAT-FILLED CMP WITH 5/8" DIA. HOLES FOR 10.50" (4) 1/2" DIA. HIGH STRENGTH ANCHOR RODS WITH LEVELING NUTS AND WASHERS 6 5/8" O.D. (50 KSI) CENTERED ON BASE PLATE. 1/4" WELD FOR POST TO BASE PLATE CONNECTION. (11)#5 BARS **PLAN**

NOTES:

1. DESIGN STRENGTH: F'c = 4,000 PSI (CONCRETE) Fy = 60,000 PSI (STEEL)

2. CONCRETE COVER UNLESS OTHERWISE NOTED, PROVIDE CONCRETE COVER FOR REINFORCING AS FOLLOWS: CONCRETE DEPOSITED AGAINST EARTH - 3" ALL OTHER - 2"

3. PROVIDE 3/4" CHAMFERS AT ALL EXPOSED EDGES.

AND PUBLIC FACILITIES

CENTRAL REGION

4111 AVIATION AVE., ANCHORAGE ALASKA 99502

PHONE (907) 269-0590

- 4. ABSOLUTELY NO WELDING OF REINFORCEMENT BARS OR TORCHING TO BEND REINFORCING BARS WILL BE ALLOWED WITHOUT SPECIFIC APPROVAL FROM STRUCTURAL ENGINEER.
- 5. ALL CAST IN PLACE AND POST-INSTALLED ANCHORS INDICATED IN THE STRUCTURAL DOCUMENTS MUST COMPLY WITH APPENDIX D OF ACI 318 AND CHAPTER 19 OF THE IBC. ALL EXPANSION AND ADHESIVE ANCHORS MUST HAVE THE ICC REPORT SHOWING EQUIVALENT LOAD CAPACITY. SUBMIT AND INSTALL PER THE ICC EVALUATION REPORT
- 6. AUGER 12" BELLOW CONCRETE FOOTING, AND INSTALL LAYER OF PEA GRAVEL. BACKFILL ANNULUS WITH CONTROLLED LOW-STRENGTH MATERIAL (CLSM) PER SPECIFICATION P-153.
- 7. THE GATE POST FOUNDATION MUST EXTEND SIX FEET ABOVE EXISTING GROUND FOR TWO SOUTH MOST GATE POSTS ON DITCH



STANTEC CONSULTING SERVICES INC 3900 C ST SUITE 902 ANCHORAGE, AK 99503-2245 (907) 276-4245 CERTIFICATION OF AUTHORIZATION #126386 BY DATE REVISION

TED STEVENS ANCHORAGE STATE OF ALASKA ANCHORAGE, ALASKA **DEPARTMENT OF TRANSPORTATION**


ANC TAXILANE V GATE RECONSTRUCTION PROJECT No. CFAPT01278 AIP NUMBER 3-02-0016-XXX-2025 DETAILS 3


02/07/2025

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NOTES:

7



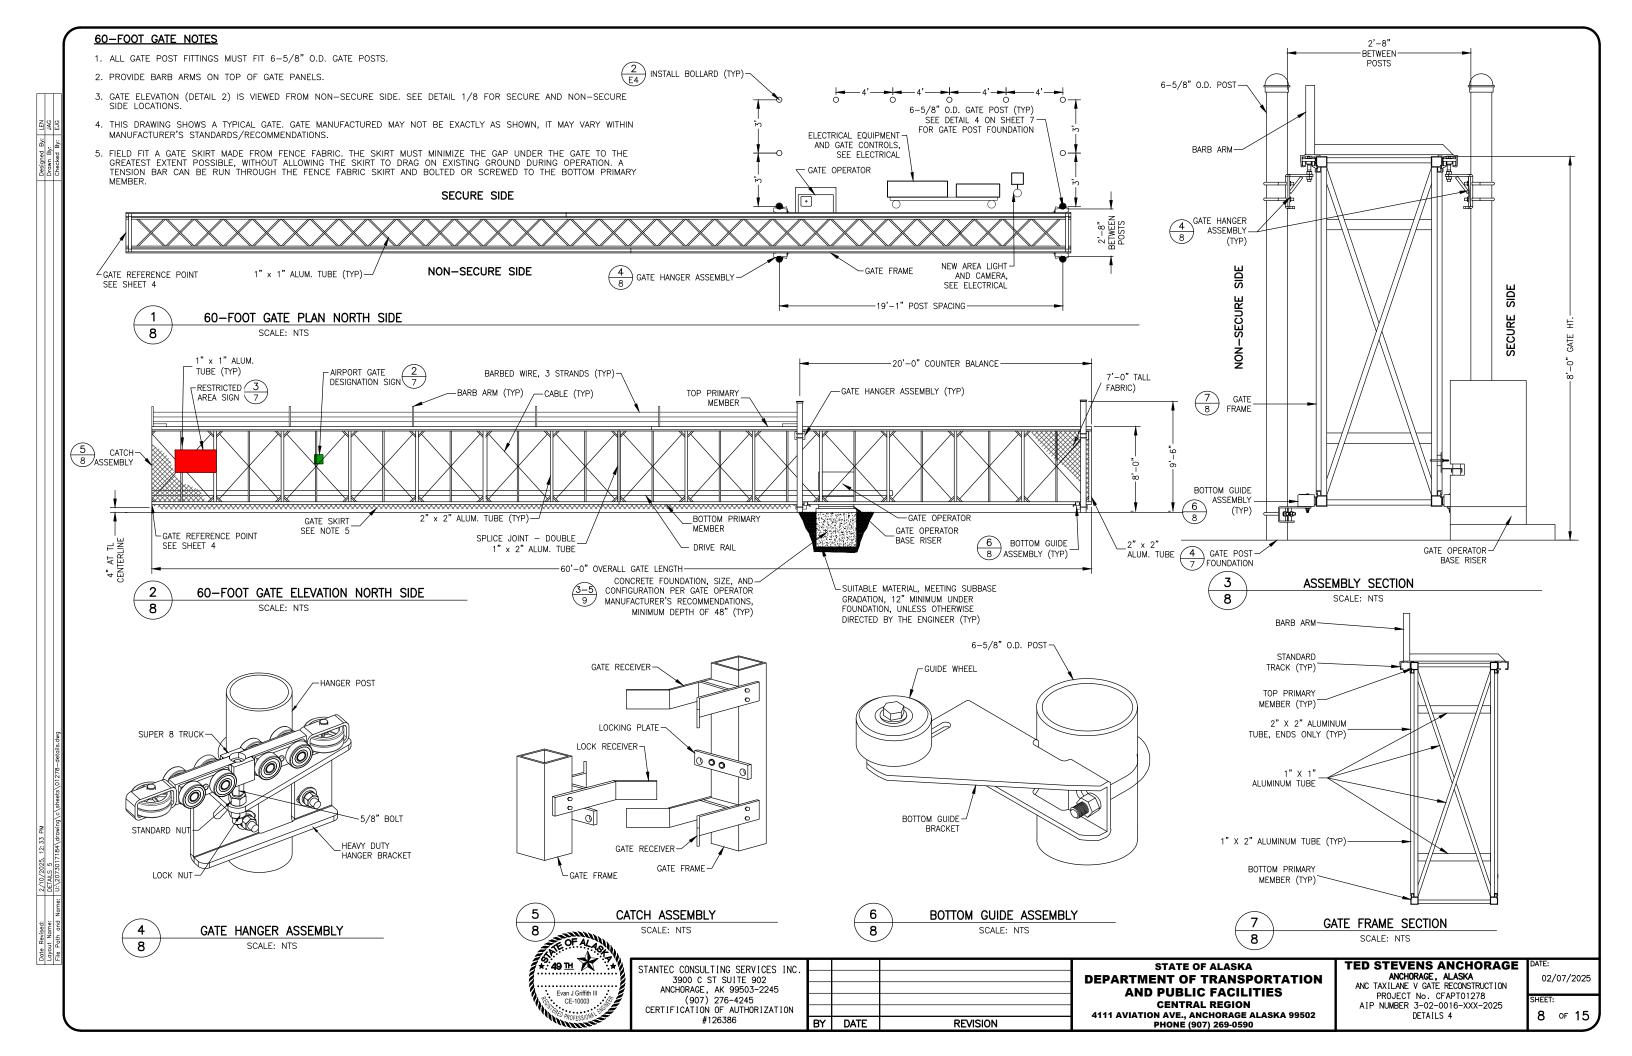

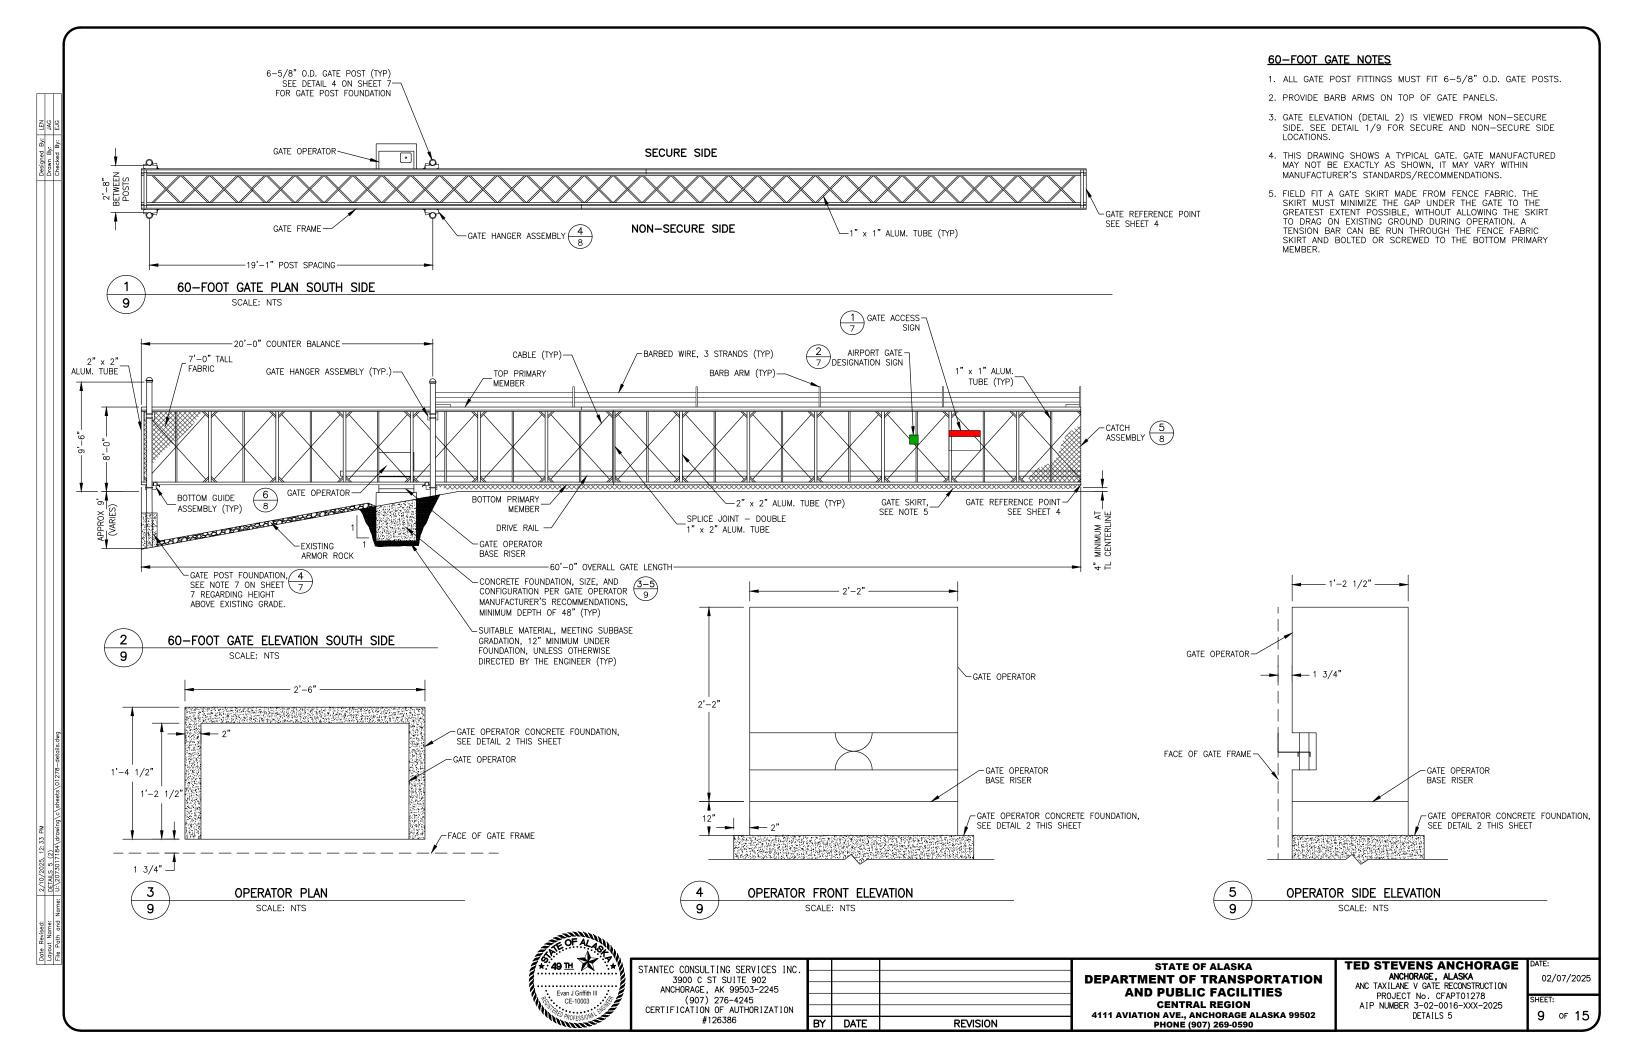GENERAL NOTES:

- EXISTING CONDUIT AND WIRING
 CONFIGURATION IS DERIVED FROM ASBUILT DRAWINGS AND LIMITED SITE INVESTIGATION. CONFIRM EXISTING CONDITIONS PRIOR TO STARTING WORK.
- 2. EXISTING TO REMAIN CONDUIT AND EQUIPMENT ARE SHOWN IN LIGHT DASHED LINES. CONDUIT AND EQUIPMENT TO BE REMOVED ARE SHOWN IN BOLD SOLID
- 3. REMOVE ALL EQUIPMENT AS SHOWN. REMOVAL SHALL INCLUDE ALL ASSOCIATED CONTROLS, CONDUIT, CONDUCTORS, SUPPORTS, AND OTHER COMPONENTS UNLESS OTHERWISE INDICATED.
- 4. ALL REMOVED GATES, GATE OPERATORS, AND CONTROL COMPONENTS SHALL BE OFFERED TO AIRFIELD MAINTENANCE FOR SALVAGE. ALL OFFERED MATERIALS DEEMED NON-SALVAGEABLE AND ALL OTHER REMOVED MATERIALS SHALL BE DISPOSED OF OFF OF AIRPORT PROPERTY IN ACCORDANCE WITH APPLICABLE REGULATIONS. DISPOSAL COSTS ARE SUBSIDIARY TO THE CONTRACT.

LUCAS SCHNELLER EE-11399

STANTEC CONSULTING SERVICES INC 3900 C ST SUITE 902 ANCHORAGE, AK 99503-2245 (907) 276-4245 CERTIFICATION OF AUTHORIZATION #126386

ΒY DATE REVISION

NORTH

REMOVE

REMOVE GATE

OPERATOR

EXISTING VALVE

EXISTING GATES

TUG

ROAD

REMOVE GATE CONDUCTORS

REMOVE GATE CONDUCTORS FROM EXISTING CONDUITS,

ROUTING UNKNOWN

FROM EXISTING CONDUITS, ROUTING UNKNOWN


STATE OF ALASKA **DEPARTMENT OF TRANSPORTATION** AND PUBLIC FACILITIES **CENTRAL REGION** 4111 AVIATION AVE., ANCHORAGE ALASKA 99502 PHONE (907) 269-0590


TED STEVENS ANCHORAGE ANCHORAGE, ALASKA ANC TAXILANE V GATE RECONSTRUCTION

PROJECT No. CFAPT01278 AIP NUMBER 3-02-0016-XXX-2025 ELECTRICAL DEMOLITION PLAN

E1 of 15

02/07/2025

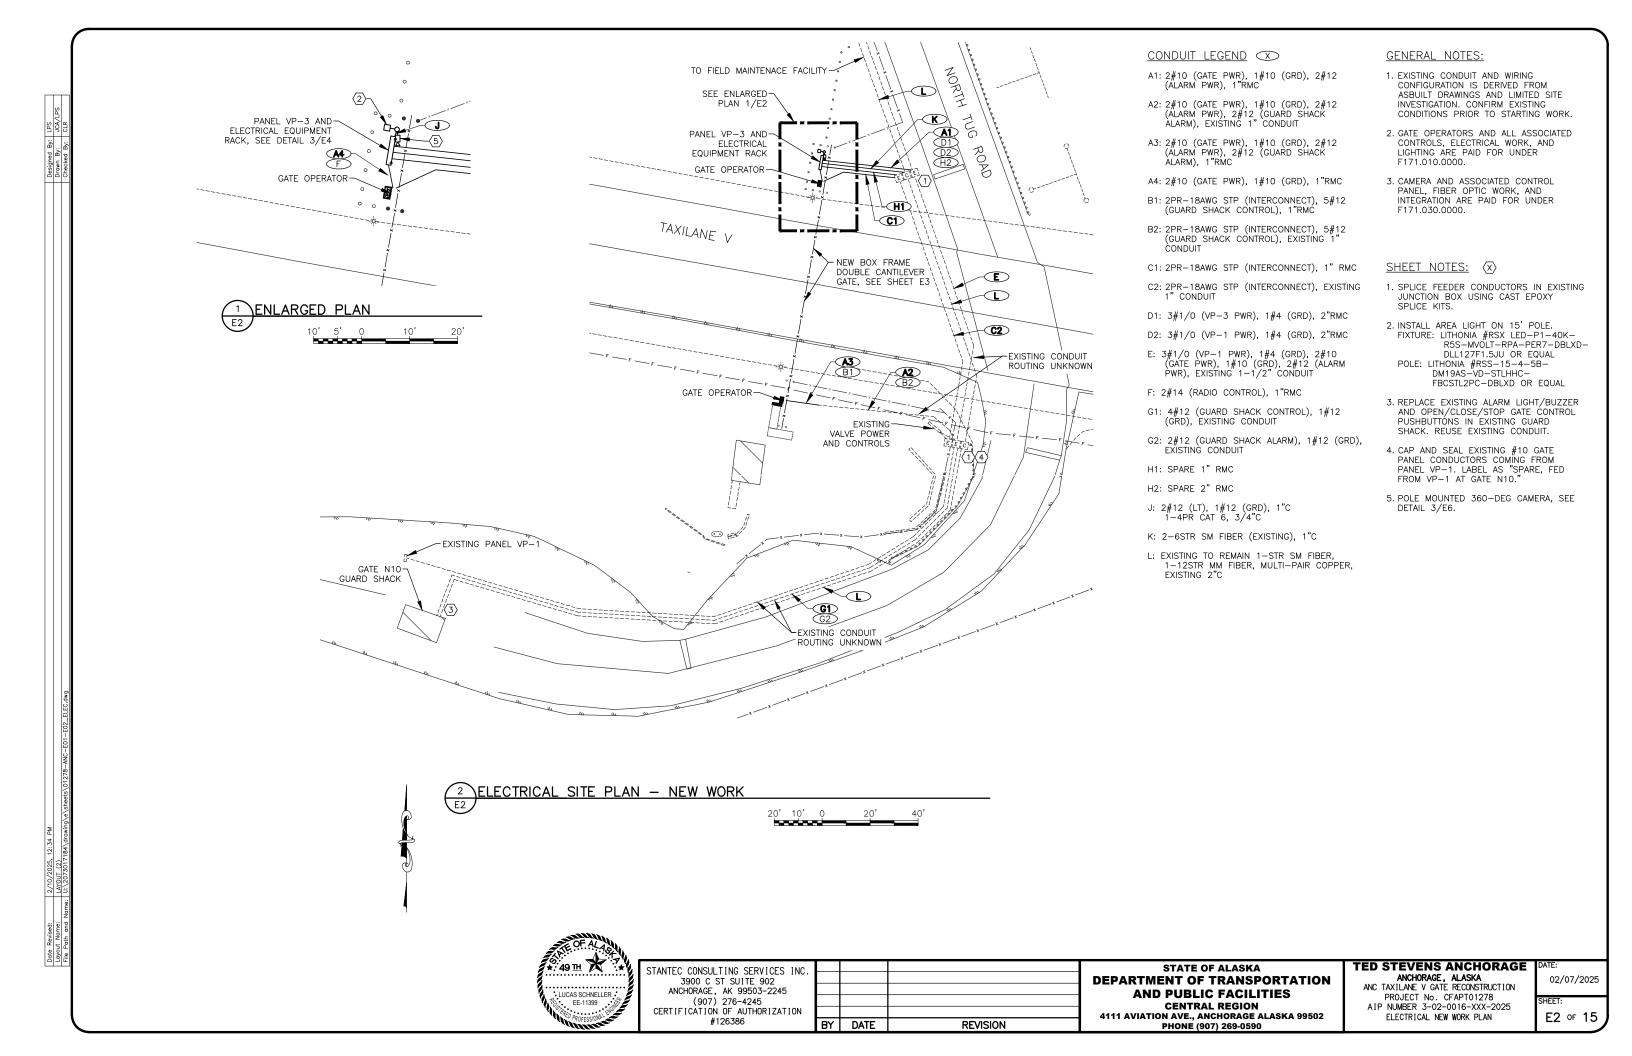

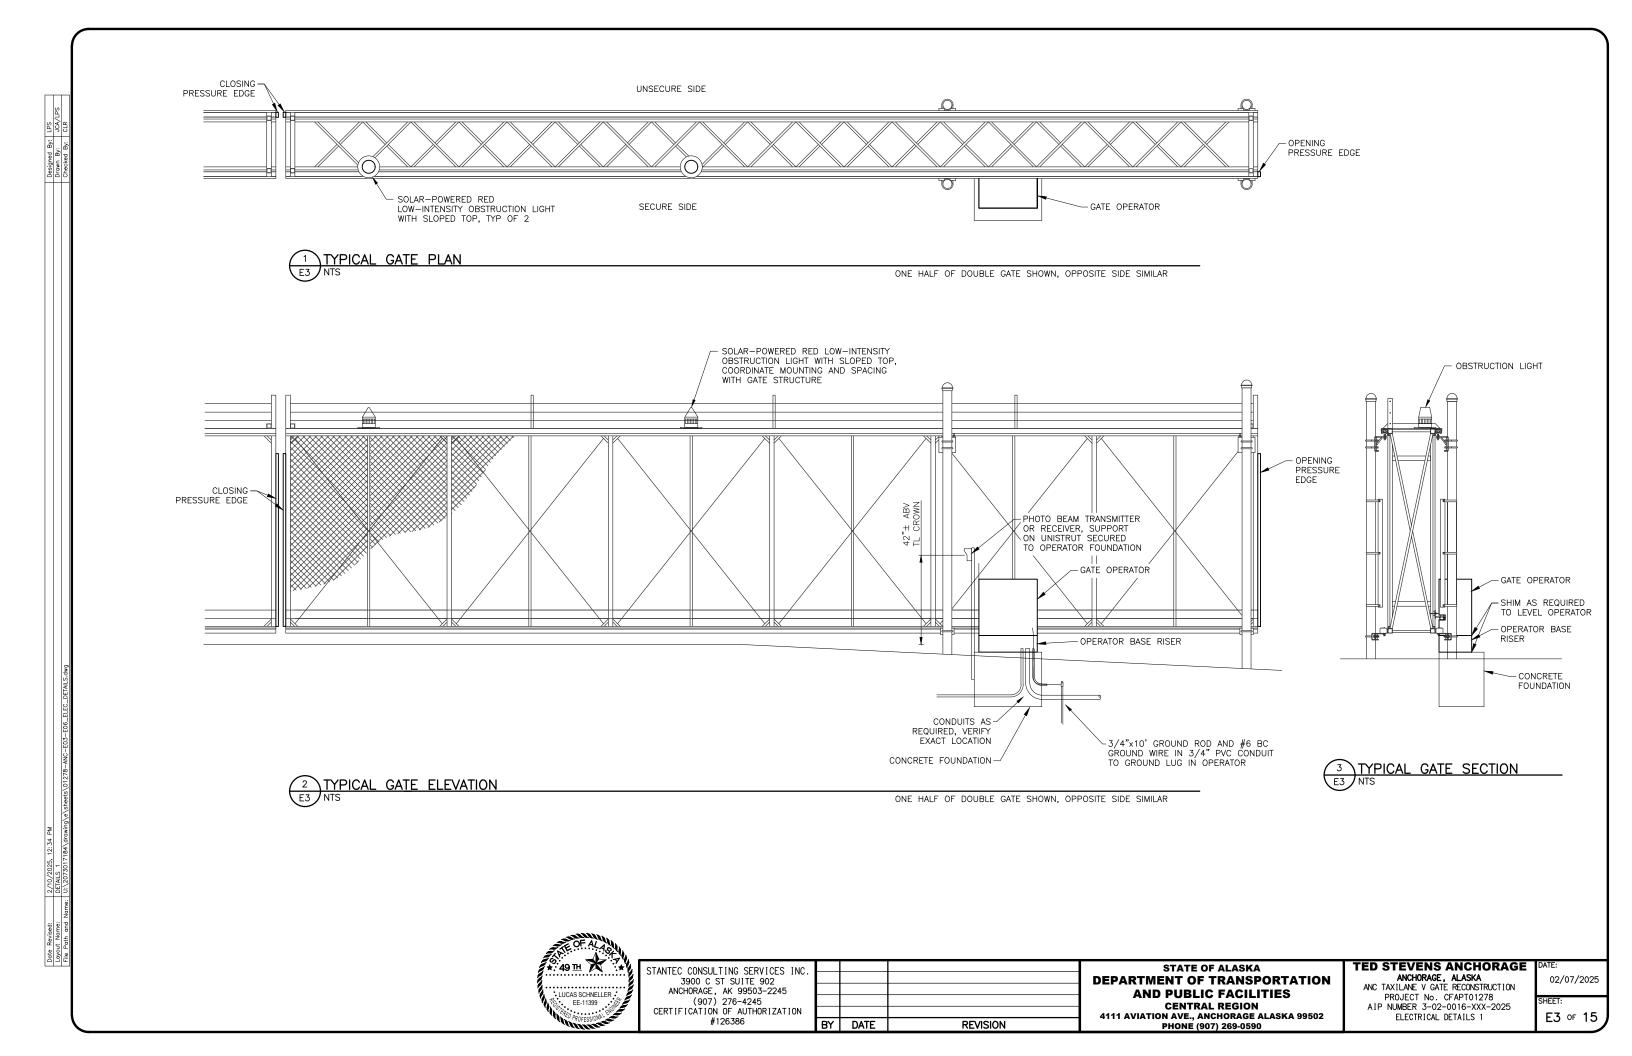



GRADE

1. WIDTH OF TRENCH AND NUMBER OF CONDUITS PER TRENCH WILL VARY (2 SHOWN).

SURFACING, SEE NOTE 2

WARNING TAPE, CONTINUOUS

BEDDING MATERIAL

PER SPECIFICATIONS

UNDISTURBED EARTH, SMOOTH FOR

CONTINUOUS SUPPORT OF DUCT


BACKFILL, SEE NOTE 2

2. SURFACING AND BACKFILL PER DETAIL 2/4.

SEPARATION BETWEEN -CONDUITS, SEE NOTE 3

- 3. USE COMMERCIALLY MANUFACTURED DUCT SPACERS IN COMMON DUCTBANKS WITH PARALLEL CONDUITS SPACED EVERY 5' O.C. TO MAINTAIN SEPARATION. SEPARATION BETWEEN CONDUITS MUST BE AS FOLLOWS:
 - -CONDUITS OF SAME TYPE (POWER OR SIGNAL) UNDER SAME OWNERSHIP 2" -POWER AND SIGNAL CONDUITS 12" MIN




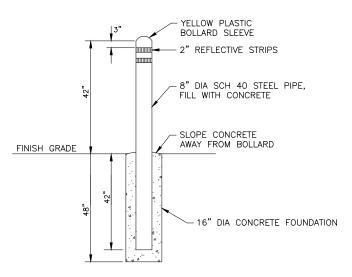

BOLLARD DETAIL NTS

NOTES:

1. SEE DETAIL 1 OF 8 FOR LAYOUT PLAN

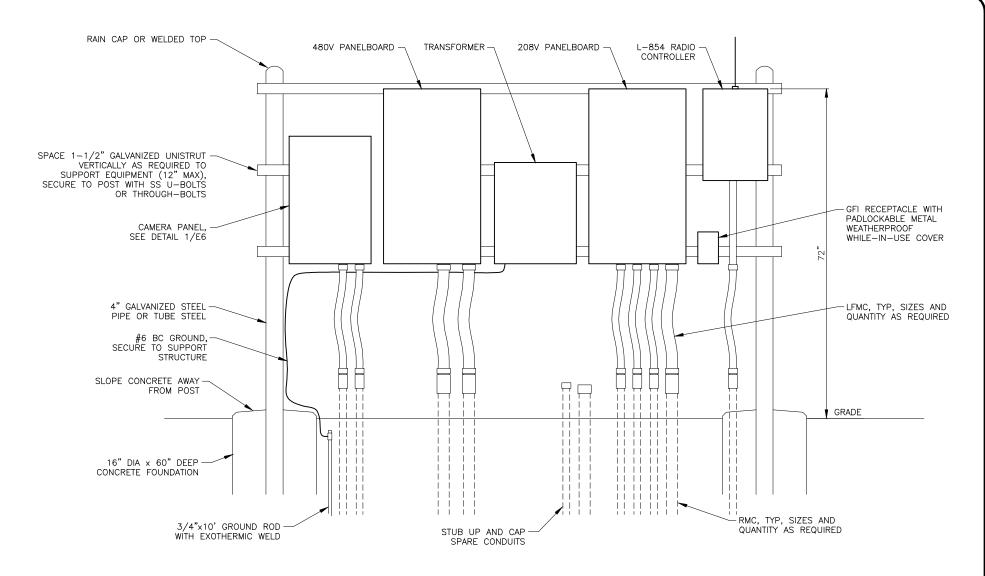

DETAIL NOTES:

- 1. ADJUST WIDTH AS REQUIRED FOR EQUIPMENT INSTALLED, 24" MINIMUM, 72" MAXIMUM SPAN WITHOUT ADDITIONAL SUPPORT.
- 2. EQUIPMENT ARRANGEMENT AND CONNECTIONS ARE SUGGESTED. CONTRACTOR SHALL DETERMINE FINAL MOUNTING AND ARRANGEMENT.

E4

DATE

ELECTRICAL EQUIPMENT RACK

SCALE: N.T.S.

REVISION

LUCAS SCHNELLER EE-11399

STANTEC CONSULTING SERVICES INC 3900 C ST SUITE 902 ANCHORAGE, AK 99503-2245 (907) 276-4245 CERTIFICATION OF AUTHORIZATION #126386 BY

STATE OF ALASKA **DEPARTMENT OF TRANSPORTATION AND PUBLIC FACILITIES CENTRAL REGION** 4111 AVIATION AVE., ANCHORAGE ALASKA 99502 PHONE (907) 269-0590


TED STEVENS ANCHORAGE ANCHORAGE, ALASKA
ANC TAXILANE V GATE RECONSTRUCTION

PROJECT No. CFAPT01278 AIP NUMBER 3-02-0016-XXX-2025 ELECTRICAL DETAILS 2

E4 of 15

02/07/2025



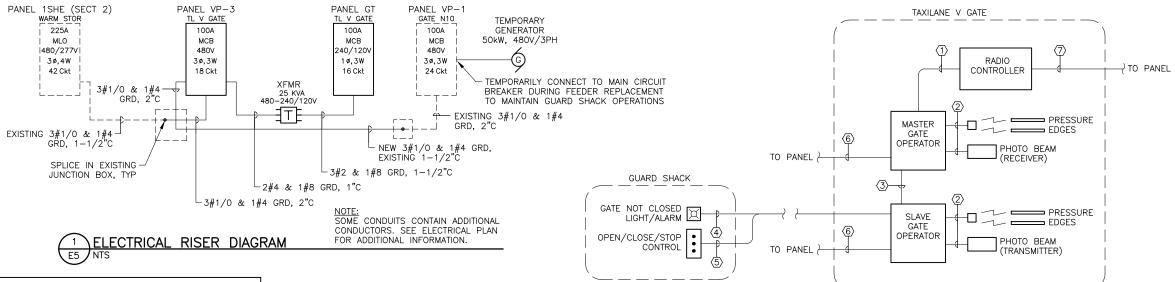

		BRA	NOU	CON	NECTED	IZVA	BRA	NCH		Т	
01/T	1010				1				1,000	١.	
JKI	LOAD	BKR	VA	A	В	С	VA	BKR	LOAD	С	
1				10.1			10100			Ŀ	
3	MAIN	100/3			10.1		10100	70/3	45kVA TRANSFORMER TO	Ŀ	
5						10.1	10100		VP-2 IN GUARD SHACK		
7	SPARE	40/2		0.0				20/1	SPARE	8	
9	(PREVIOUSLY SERVING GATE PANEL)				0.0			20/1	SPARE	1	
11			3500			3.5		20/1	SPARE	1	
13	VV36 MOV DISCONNECTS AND	30/3	3500	3.5				20/1	SPARE	1	
15	CONTROL PANEL		3500		3.5					1	
17	SPARE	20/1				0.0				1	
19	SPARE	20/1		0.0						2	
21	SPARE	20/1			0.0					2	
23						0.0				2	
	CONNECTED LOAD	40.8	KVA	13.6	13.6	13.6		P	ANEL SPECIFICATIONS		
		49	AMPS	49	49	49			MAINS RATING AMPS - 100		
	NEC DEMAND	40.8	KVA				MAIN	CIRCUI	T BREAKER AMPERES — 100		
49 AMPS							C	APACITY	ONE-POLE CIRCUITS - 24		
PA	PANEL NOTES							SYSTEM VOLTAGE - 480			
1.	1. NEMA 4X ENCLOSURE.							PHASE, NO. OF WIRES - 3 PH, 3 W			
2.	EXISTING LOADS OBTAINED FROM ASBU	UILT DRA	WINGS.				AIC RATING - 18,000				
							MOUNTING - POST				
									LOCATION — GATE N10		

	NEW PANEL VP-3										
		BRA	NCH	CON	NECTED	KVA	BRA	NCH			
СКТ	LOAD	BKR	VA	Α	В	С	VA	BKR	LOAD	СКТ	
1	PANEL GT	70/2	5000	18.6			13600			2	
3			4600		18.2		13600	100/3	EXISTING PANEL VP-1	4	
5						13.6	13600			6	
7				0.0						8	
9					0.0					10	
11						0.0				12	
13				0.0						14	
15					0.0					16	
17						0.0				18	
	CONNECTED LOAD	50.4	KVA	18.6	18.2	13.6		P.	ANEL SPECIFICATIONS		
		61	AMPS	67	66	49	MAINS RATING AMPS - 100				
	NEC DEMAND	52.8	KVA				MAIN CIRCUIT BREAKER AMPERES - 100				
		64	AMPS				CAPACITY ONE-POLE CIRCUITS - 18				
P	ANEL NOTES						SYSTEM VOLTAGE - 480				
1.	1. NEMA 4X ENCLOSURE.						PHASE, NO. OF WIRES - 3 PH, 3 W				
								AIC RATING - 14,000			
							MOUNTING - POST				
									LOCATION — TL V GATE		

_		
		CABLE SCHEDULE
	1	2-12AWG (OPEN CONTROL)
	2	AS REQUIRED BY MANUFACTURER
	3	2PR-18AWG SHIELDED TWISTED PAIR (INTERCONNECT), OR AS REQUIRED BY MANUFACTURER
	4	3-12AWG (GATE OPEN ALARM, GRD)

(6) 3-10AWG (208V/1PH PWR, GRD)

(5) 5-12AWG (OPEN/CLOSE/STOP CONTROL, GRD)

GATE SYSTEM DIAGRAM

	PANEL GT								
		BRA	NCH	CONN	KVA	BRA	NCH		
скт	LOAD	BKR	VA	Α	В	VA	BKR	LOAD	СКТ
1	NORTH GATE OPERATOR	30/2	2136	2.6		500	20/1	RADIO CONTROLLER	2
3			2136		2.3	180	20/1	GFI RECEPTACLE	4
5	SOUTH GATE OPERATOR	30/2	2136	2.2		52	20/1	AREA LIGHT	6
7			2136		2.2	100	20/1	GUARD SHACK ALARM	8
9				0.2		150	20/1	CAMERA PANEL	10
11					0.0				12
	CONNECTED LOAD	9.5	KVA	5.0	4.6	PANEL SPECIFICATIONS			
		40	AMPS	41	38	MAINS RATING AMPS - 100			
	NEC DEMAND	10.7	KVA			IIAM	N CIRCUI	T BREAKER AMPERES - 100	
		45	AMPS			CAPACITY ONE-POLE CIRCUITS - 12			
P	ANEL NOTES							SYSTEM VOLTAGE - 240/120	
1. NEMA 4X ENCLOSURE.							Р	HASE, NO. OF WIRES - 1 PH, 3 W	
								AIC RATING - 10,000	
								MOUNTING - POST	
								LOCATION — TL V GATE	



STANTEC CONSULTING SERVICES IN 3900 C ST SUITE 902
ANCHORAGE, AK 99503-2245
(907) 276-4245
CERTIFICATION OF AUTHORIZATION #126386


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STATE OF ALASKA **DEPARTMENT OF TRANSPORTATION AND PUBLIC FACILITIES CENTRAL REGION** 4111 AVIATION AVE., ANCHORAGE ALASKA 99502 PHONE (907) 269-0590

TED STEVENS ANCHORAGE ANCHORAGE, ALASKA ANC TAXILANE V GATE RECONSTRUCTION

PROJECT No. CFAPT01278 AIP NUMBER 3-02-0016-XXX-2025 ELECTRICAL DETAILS 3

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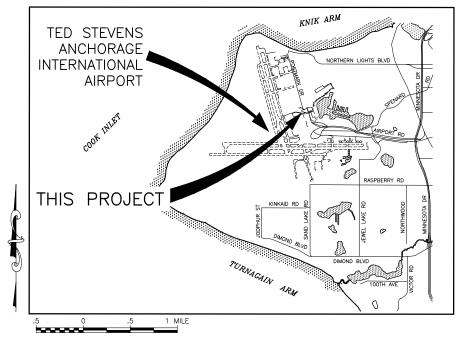


PACIFIC

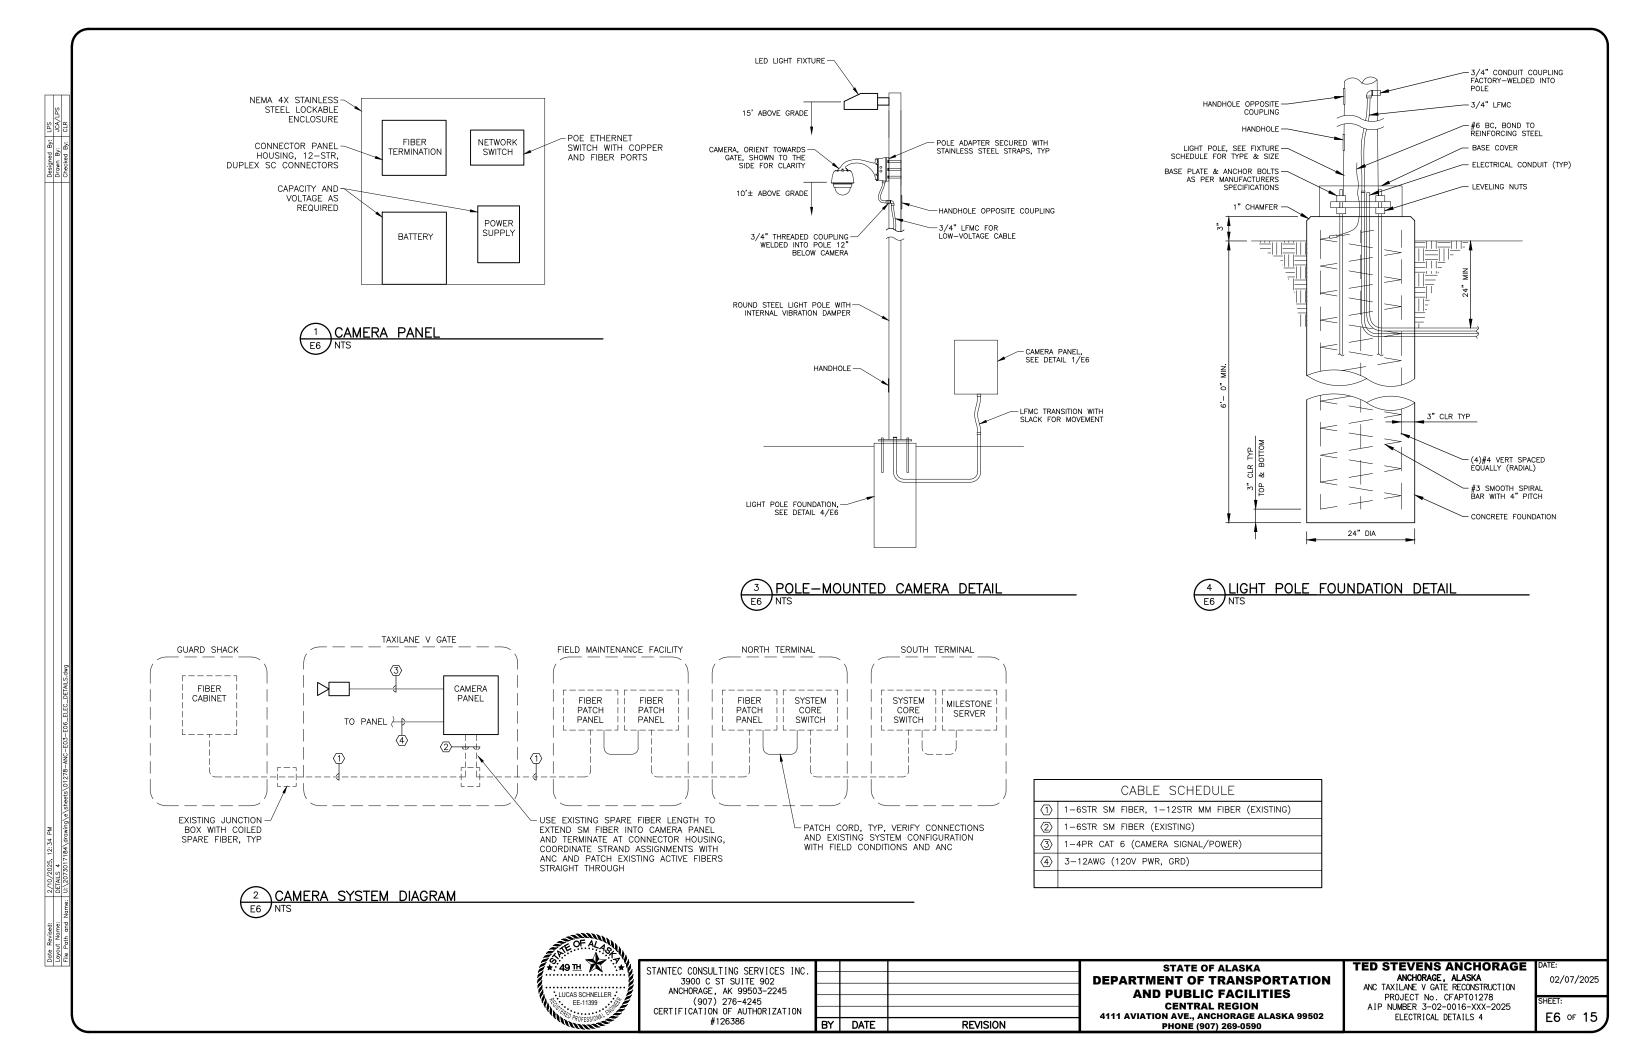

ALASKA CENTRAL REGION

NOT TO SCALE



T 13 N, R 4 W, SEC. 32, 33, 34, & 35 SEWARD MERIDIAN U.S.G.S. ANCHORAGE (A-8), ALASKA

CONSTRUCTION PLANS TED STEVENS

ANCHORAGE INTERNATIONAL AIRPORT

ANCHORAGE, ALASKA ANC TAXILANE V GATE RECONSTRUCTION PROJECT No. CFAPT01278 **AIRPORT IMPROVEMENT PROGRAM** No. 3-02-0016-XXX-2025

ESCP FEBRUARY 2025

GENERAL ESCP NOTES:

- 1. REFER TO ESCP FOR EROSION CONTROL BEST MANAGEMENT PRACTICES (BMPS).
- DEVELOP A STORM WATER POLLUTION PREVENTION PLAN (SWPPP) FOR THIS PROJECT. COMPLY WITH THE ALASKA POLLUTANT DISCHARGE ELIMINATION SYSTEM (APDES) REQUIREMENTS FOR STORM WATER DISCHARGE FROM CONSTRUCTION SITES. SEE SECTION 641 OF THE SPECIAL PROVISIONS, THE ALASKA SWPPP GUIDE (AS CURRENTLY AMENDED), AND ALL CONDITIONS OF PERMIT APPROVALS. WORK SHOWN HERE IS MINIMUM REQUIRED.
- INSTALL SEDIMENT CONTROL DEVICES BEFORE ERODIBLE SOILS ARE EXPOSED AND MAY HAVE TO REMOVE AND REINSTALL CONTROLS DAILY TO ALLOW CONSTRUCTION ACTIVITIES TO PROCEED. ALL DEVICES SHALL BE MAINTAINED ON A DAILY BASIS, INCLUDING BUT NOT LIMITED TO REMOVAL AND DISPOSAL OF ACCUMULATED SOILS, CLEANING DEVICES, AND REPAIR OF DAMAGED DEVICES OR REPLACEMENT WITH NEW.
- 4. PROVIDE INLET PROTECTION ON ALL STORM DRAIN INLETS OR CULVERTS WITHIN 25 FEET OF DISTURBED GROUND.
- USE WATER OR NON-TOXIC DUST PALLIATIVES TO CONTROL DUST.
- MAINTAIN DEVICES AND CORRECT ANY PROBLEMS OCCURRING DUE TO INADEQUATE PROTECTION MEASURES. INSPECT AND REPAIR DEVICES AFTER EACH RAINFALL. REMOVE AND DISPOSE OF SEDIMENT CONTROL DEVICES AFTER STABILIZATION OF SLOPES.
- IF INSPECTION REVEALS EROSION CONTROL MEASURES ARE INSUFFICIENT, IMMEDIATELY IMPLEMENT CORRECTING ACTION. THIS MAY INCLUDE: CHANGING CONSTRUCTION METHODS, INSTALLING ADDITIONAL EROSION CONTROL BMPS, PHASING WORK, AND OTHER CORRECTIVE MEASURES.
- MINIMIZE THE AREA AND TIME PERIOD ERODIBLE SOILS ARE EXPOSED TO STORM WATER. DISTURBED AREAS SHALL BE STABILIZED AS SOON AS PRACTICABLE AFTER DISTURBANCE AND IN ACCORDANCE WITH ALASKA CONSTRUCTION GENERAL PERMIT (ACCP)
- STABILIZE DISTURBED GROUND AS SOON AS POSSIBLE. UNSTABILIZED SURFACES MUST BE TEMPORARILY STABILIZED WITH BONDED FIBER MATRIX, SEEDING, ROLLED EROSION CONTROL PRODUCT (RECP), OR OTHER EFFECTIVE MEASURES. THE CONTRACTOR IS RESPONSIBLE FOR MAINTAINING EROSION AND SEDIMENT CONTROL UNTIL PROJECT WORK AREAS ARE PAVED AND SEEDED AS AREAS HAVE ACHIEVED 70% VEGETATIVE COVER.
- 10. MATERIAL TRACKED BY CONSTRUCTION EQUIPMENT MUST BE SWEPT BACK INTO THE PROJECT AREA OR PICKED UP BY A VACUUM

STANTEC CONSULTING SERVICES INC.
3900 C ST SUITE 902
ANCHORAGE, AK 99503-2245
(907) 276-4245
CERTIFICATION OF AUTHORIZATION

#126386

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STATE OF ALASKA **DEPARTMENT OF TRANSPORTATION** AND PUBLIC FACILITIES **CENTRAL REGION**


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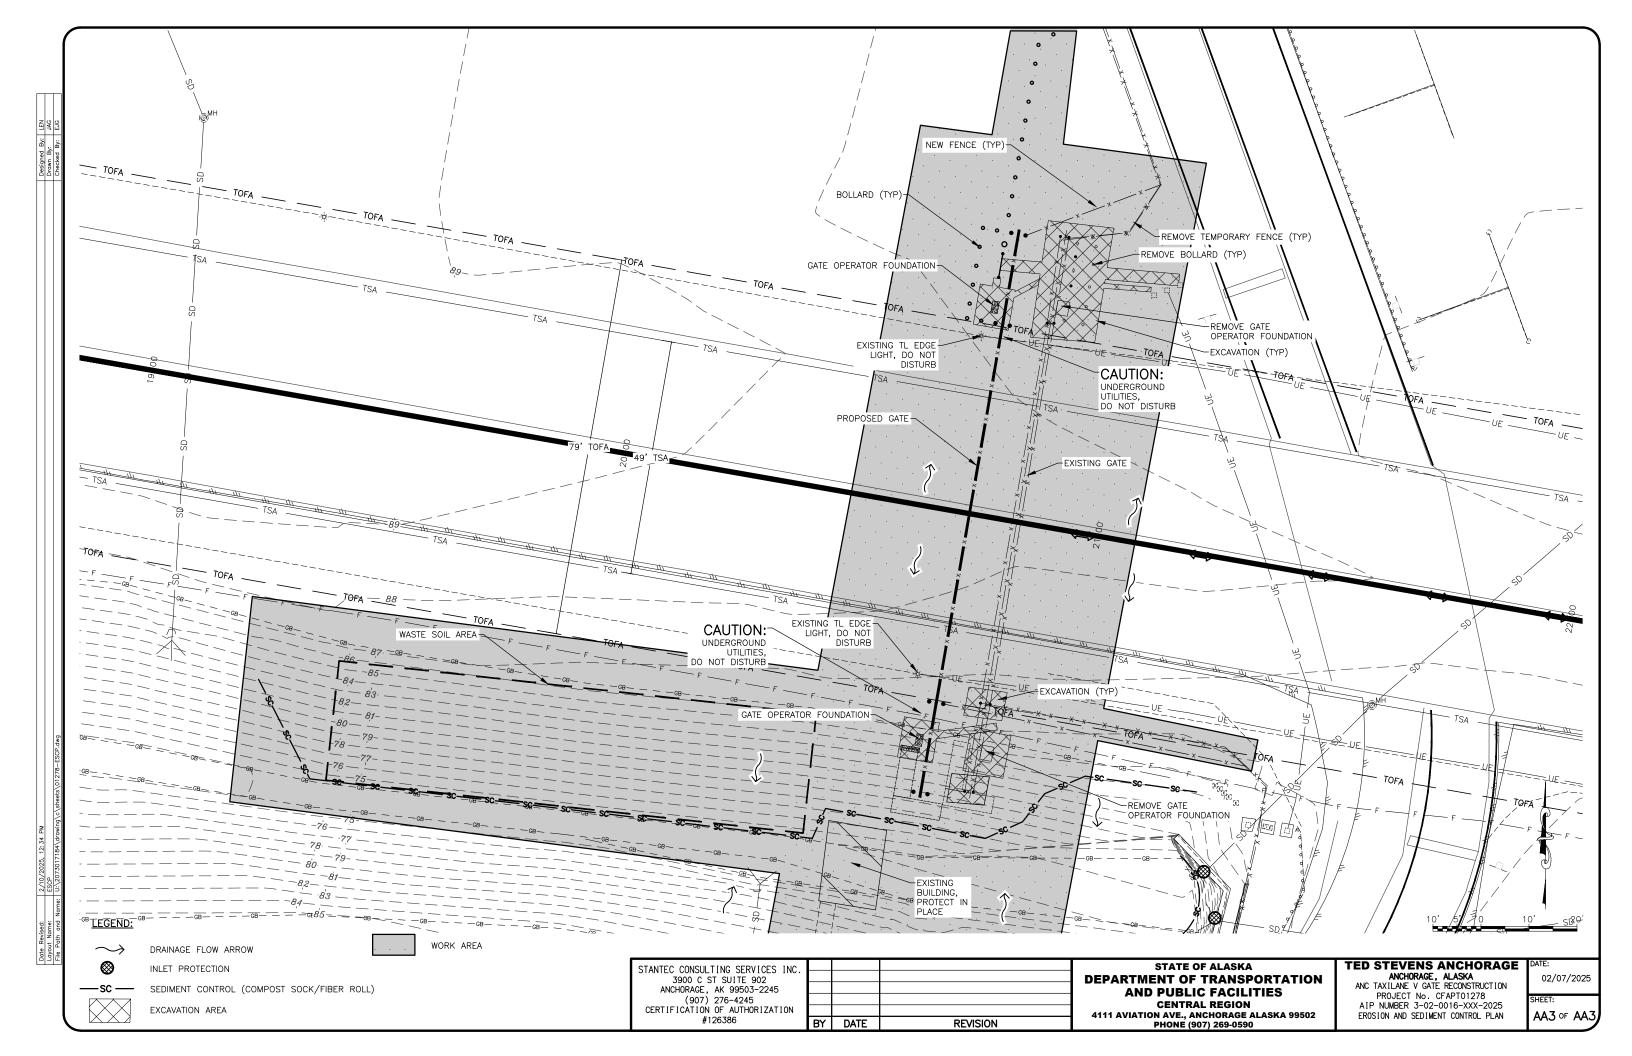
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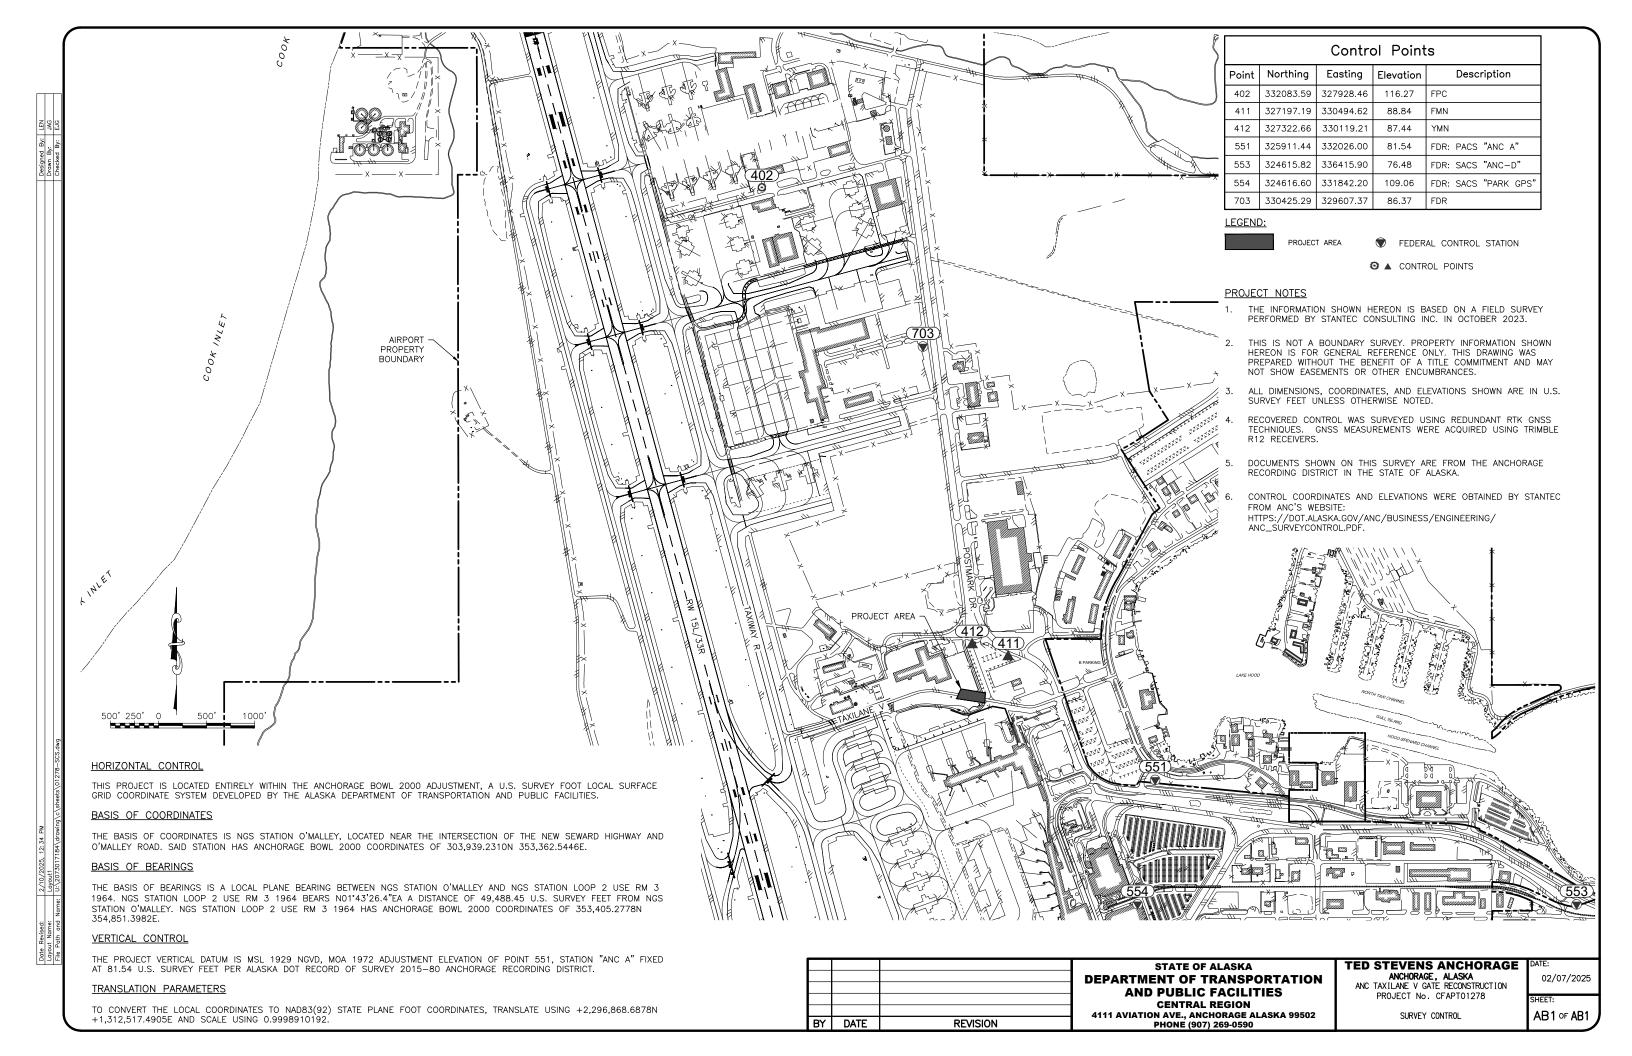
ANCHORAGE, ALASKA ANC TAXILANE V GATE RECONSTRUCTION PROJECT No. CFAPT01278 AIP NUMBER 3-02-0016-XXX-2025 EROSION AND SEDIMENT CONTROL COVER SHEET


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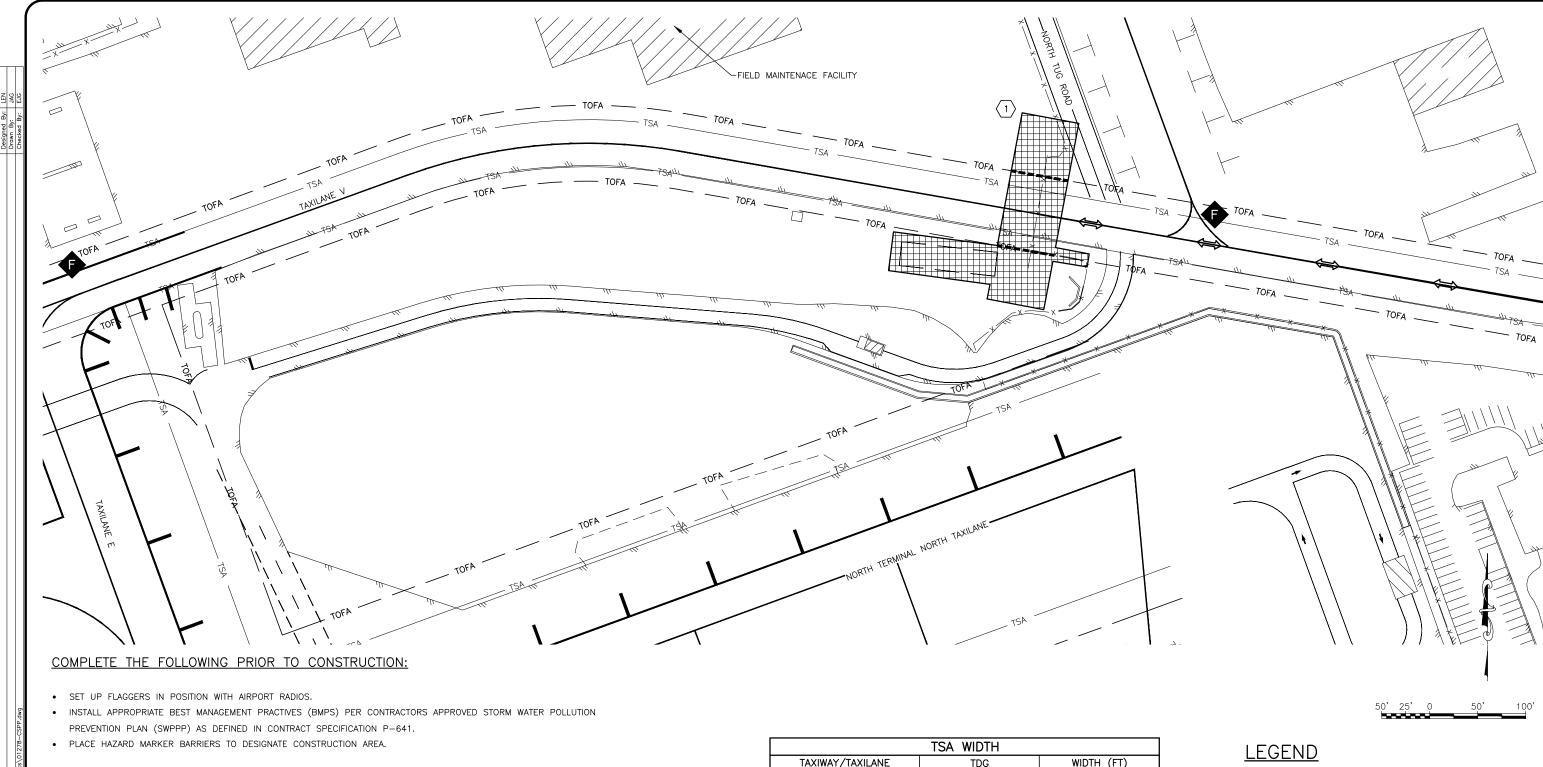
AA1 of AA3







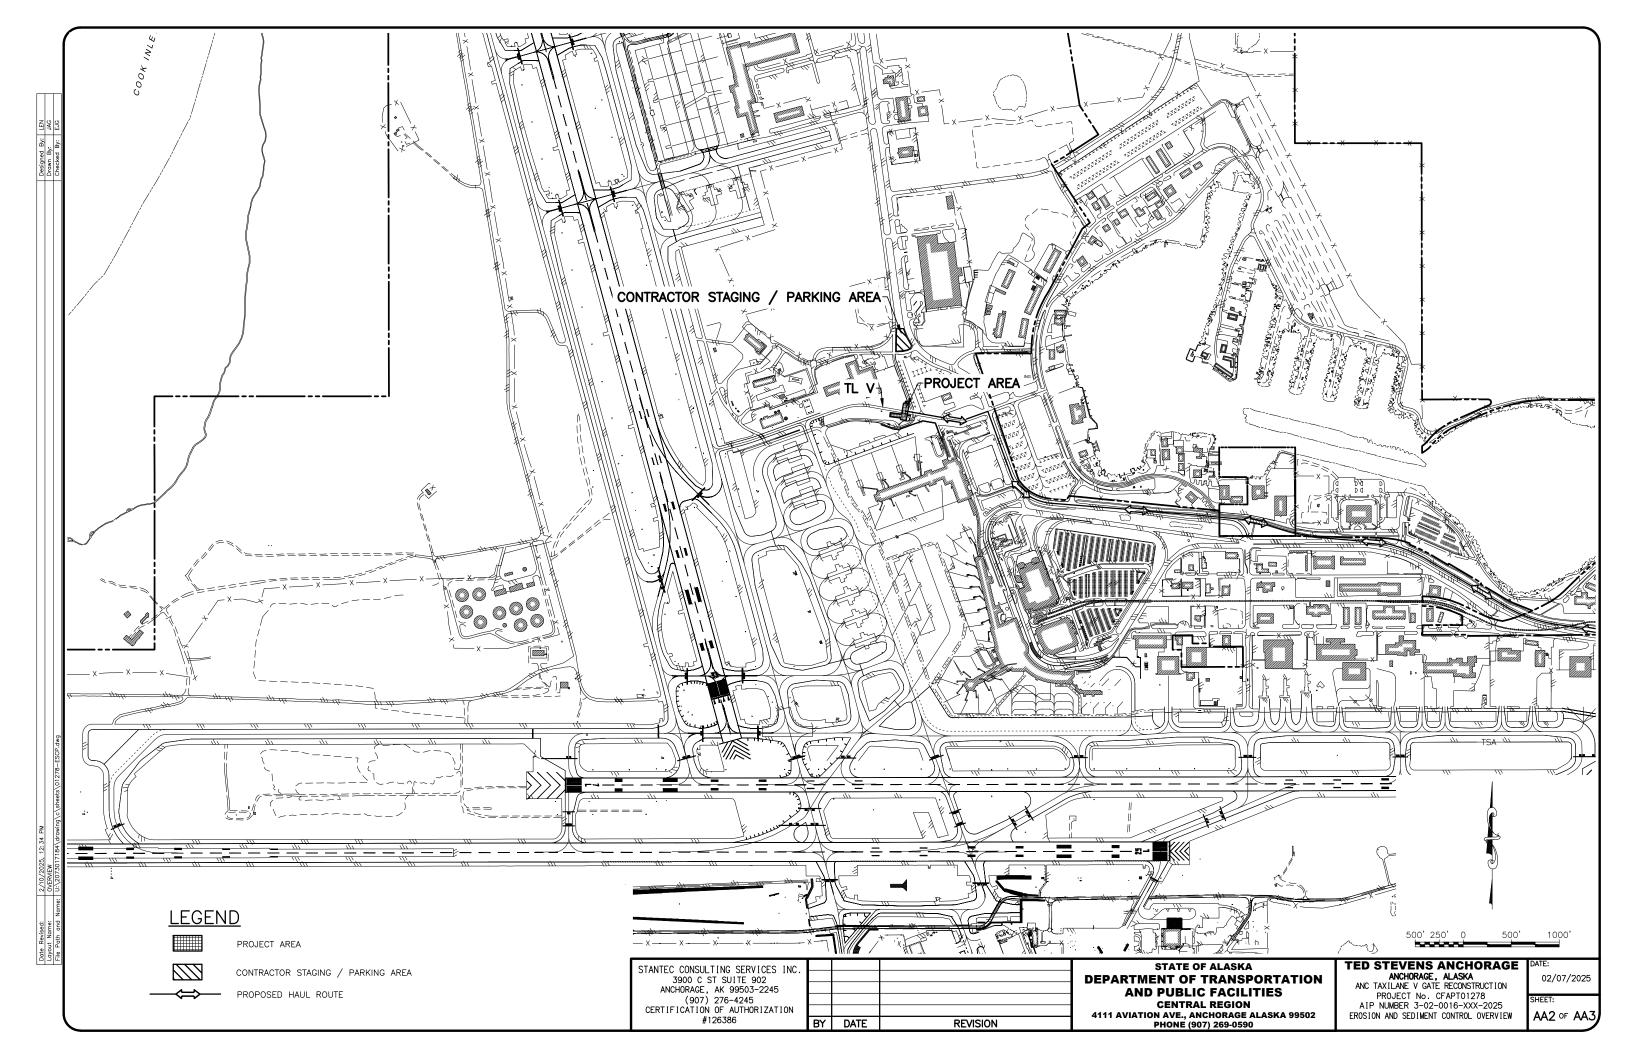

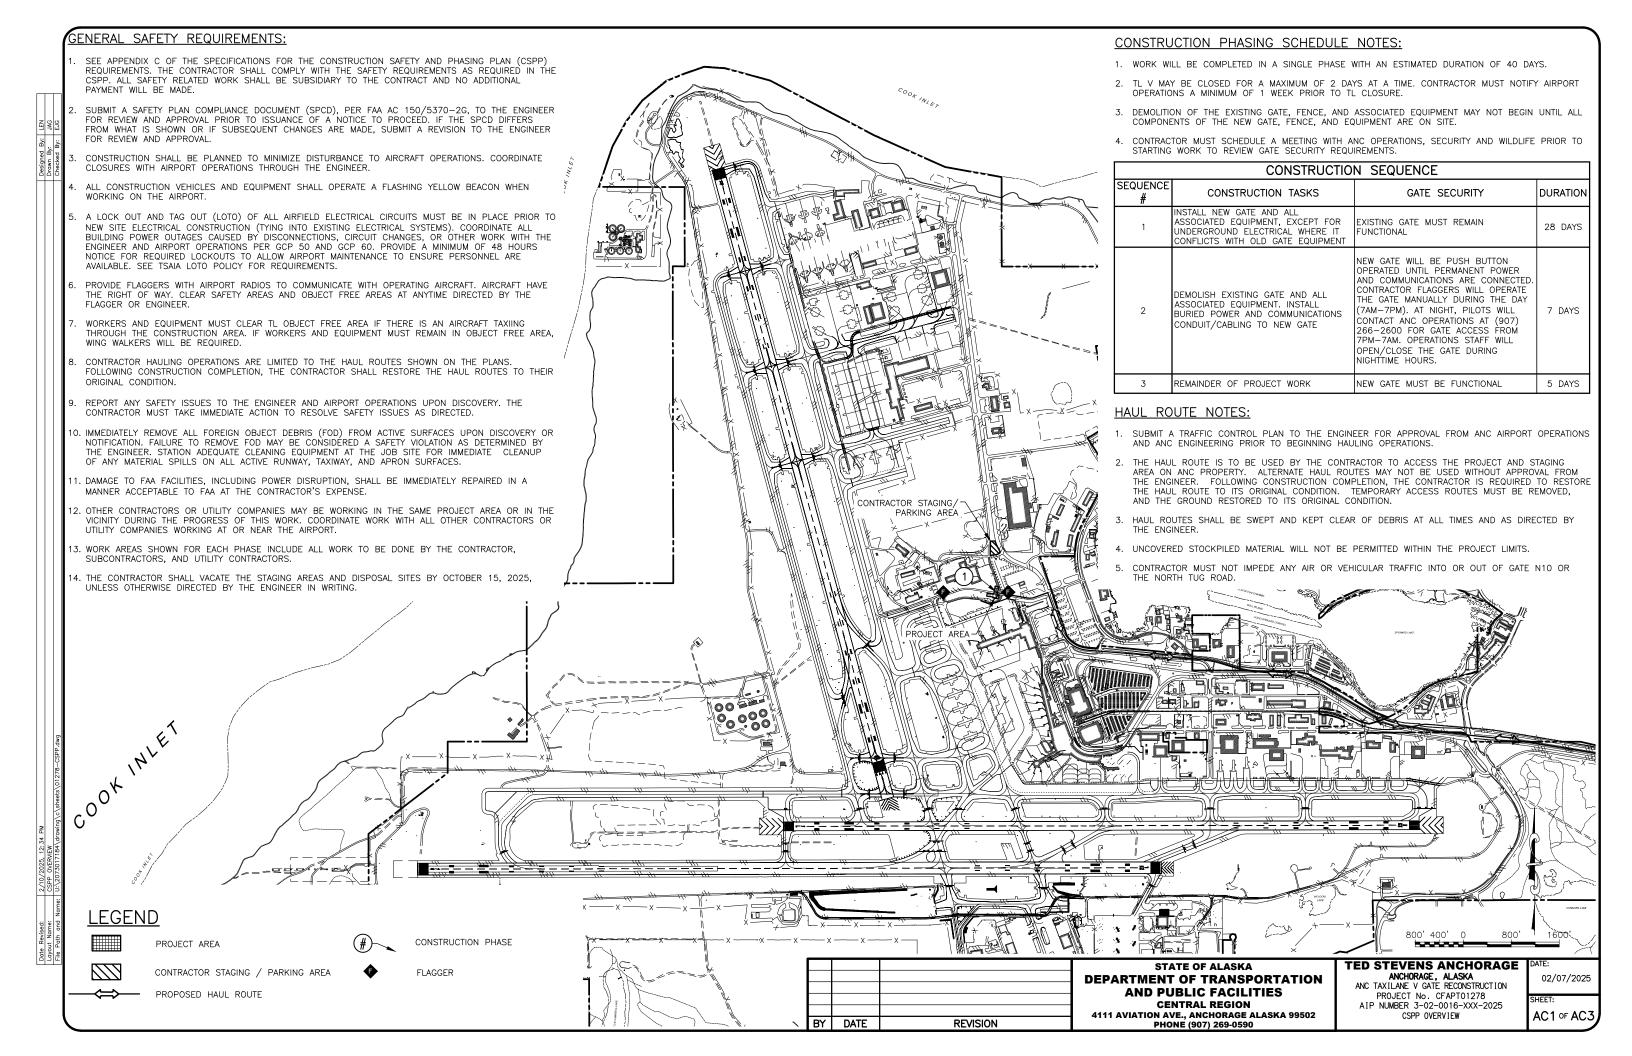

COMPLETE THE FOLLOWING DURING CONSTRUCTION:

- SAWCUT AND REMOVE EXISTING ASPHALT PAVEMENT FOR GATE CONTROLLER FOUNDATIONS, ELECTRICAL TRENCHES, AND EXCAVATE AS NEEDED FOR NEW INFRASTRUCTURE
- INSTALL NEW GATE POST FOUNDATIONS AND POSTS, OPERATOR FOUNDATIONS, GATE OPERATORS, FENCE, BOLLARDS, AND BURIED POWER AND COMMUNICATIONS CONDUIT/CABLING.
- PROVIDE TEMPORARY POWER TO NEW GATE FOR USE OF MANUAL PUSH BUTTON OPENING OF EACH NEW GATE PANEL
- DEMOLISH ORIGINAL TL V GATE AND ASSOCIATED INFRASTRUCTURE.
- CONNECT POWER AND COMMUNICATIONS TO NEW GATE.
- BACKFILL, GRADE, COMPACT, PAVE, AND PAINT IN THE AREAS WHERE PAVEMENT OR MARKINGS WERE REMOVED.

COMPLETE THE FOLLOWING AFTER CONSTRUCTION:

- REMOVE HAZARD MARKER BARRIERS
- REMOVE BMPS

TSA WIDTH						
TAXIWAY/TAXILANE	TDG	WIDTH (FT)				
TAXILANE V (EAST OF TW E)	ADG I	49'				
TAXILANE V (WEST OF TW E)	ADG I	49'				

	TOFA WIDTH	
TAXIWAY/TAXILANE	ADG	WIDTH (FT)
TAXILANE V (EAST OF TW E)	ADG I	79'
TAXILANE V (WEST OF TW E)	ADG I	89'

WORK AREA



CONSTRUCTION PHASE



FLAGGER



HAZARD MARKER BARRIER



PROPOSED HAUL ROUTE

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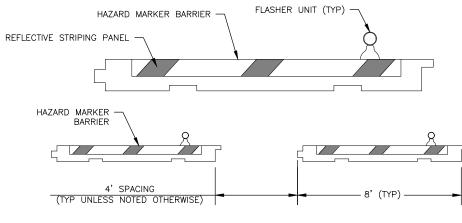
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PROJECT No. CFAPT01278 AIP NUMBER 3-02-0016-XXX-2025

02/07/2025 AC2 of AC3

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CSPP PHASE 1



NOTES:

- 1. PLACE BARRIERS TO SEPARATE CONSTRUCTION AREAS FROM OPEN PORTIONS OF THE AIRPORT.
- 2. DISTANCE BETWEEN BARRIERS CAN BE ADJUSTED FOR CONSTRUCTION TRAFFIC.
- 3. BARRIERS MUST BE LOCATED OUTSIDE THE SAFETY AREA OF ACTIVE TAXIWAYS AND TAXILANES.
- 4. RED FLASHERS MUST BE USED FOR HAZARD MARKER BARRIERS.
- 5. FILL AND MAINTAIN BARRIERS PER SPECIFICATION P-670-3.1.b.
- 6. ESTIMATED QUANTITY BASED ON MOST DEMANDING PHASE.

AC3

HAZARD MARKER BARRIER DETAIL

SCALE: NTS

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TED STEVENS ANCHORAGE ANCHORAGE, ALASKA ANC TAXILANE V GATE RECONSTRUCTION ANCHORAGE

ANC TAXILANE V GATE RECONSTRUCTION PROJECT No. CFAPT01278 AIP NUMBER 3-02-0016-XXX-2025 CSPP DETAILS 02/07/2025

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