


LOCATION MAP

NOT TO SCALE

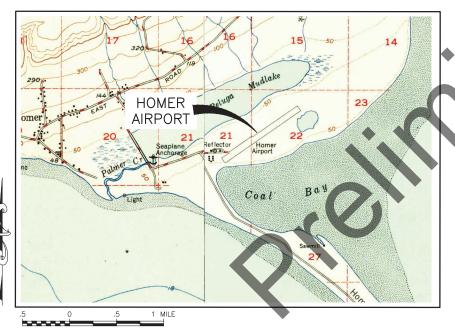

VICINITY MAP

SCALE 1"= 1/2 MILE SECTION 21, AND 22, T 6 S, R 13 SEWARD MERIDIAN U.S.G.S. SELDOVIA (C-4), ALASKA

CONSTRUCTION PLANS HOMER AIRPORT

HOMER, ALASKA HOMER AIRPORT IMPROVEMENTS PROJECT No. CFAPT00491 AIRPORT IMPROVEMENT PROGRAM No. 3-02-0122-020-2022 2022

> PS&E **FEBRUARY 2022**

> > **APPROVED** DATE REGIONAL PRECONSTRUCTION ENGINEER LUKE S. BOWLAND, P.E **APPROVED** DATE JENELLE R. BRINKMAN, P.E AVIATION DESIGN GROUP CHIEF **APPROVED** DATE MATHEW H. HANSEN, P.E. PROJECT MANAGER CONCUR DATE JOEL G. ST. AUBIN, P.E. REGIONAL CONSTRUCTION ENGINEER


- 1	NO. AECL861	BY	DATE	REVISION	Ι.
- 1	CERTIFICATE OF AUTHORIZATION				Ι,
- 1	(907) 564-2120				
- 1	ANCHORAGE, AK 99503				-
- 1	3335 ARCTIC BOULEVARD, STE 100				D
	HDL ENGINEERING CONSULTANTS, LLC				

STATE OF ALASKA DEPARTMENT OF TRANSPORTATION **AND PUBLIC FACILITIES CENTRAL REGION** 4111 AVIATION AVE., ANCHORAGE ALASKA 99502 PHONE (907) 269-0590

HOMER AIRPORT HOMER, ALASKA HOMER AIRPORT IMPROVEMENTS PROJECT No. CFAPTO491
AIP No. 3-02-0122-020-2022
TITLE, SIGNATURES, LOCATION MAP
& VICINITY MAP

2/2022 1 of 57

INDE	X			STANDARD	PLANS
Sheet Title	Sheet Number	Sheet Title	Sheet Number	SHEET TITLE	SHEET N
TILE, SIGNATURES, LOCATION MAP & VICINITY MAP	1	GA APRON GRADING & LAYOUT PLAN	32		
NDEX	2	P1 DRAINAGE PLAN & PROFILE	33	CULVERT PIPE AND ARCH INSTALLATION DETAILS	D-01.02
GEND AND ABBREVIATIONS	3	P2 DRAINAGE PLAN & PROFILE	34	PIPE AND ARCH TABLES	D-04.22
STIMATED QUANTITIES	4	P3 DRAINAGE PLAN & PROFILE	35	CULVERT END SECTIONS	D-06.10
STIMATED QUANTITIES AND FACTORS	5	P4 DRAINAGE PLAN & PROFILE	36	TYPE II HEADWALL	D-31.01
ROJECT LAYOUT PLAN	6	P10 DRAINAGE PLAN & PROFILE	37		
EMOLITION PLAN	7	DITCH DRAINAGE PLAN & PROFILE	38		
EMOLITION PLAN	8	STORM DRAIN MANHOLE, TYPE I DETAILS	39		
YPICAL SECTIONS	9	DRAINAGE PIPE SUMMARY AND DETAIL	40		
PICAL SECTIONS	10	RUNWAY MARKING PLAN	41	*	
PICAL SECTIONS	11	RUNWAY MARKING PLAN	42	APPENDIX DR	AWINGS
PICAL SECTIONS	12	TAXIWAY C & D MARKING PLAN	43		
JNWAY PLAN & PROFILE	13	TAXIWAY B MARKING PLAN	44	SHEET TITLE	SHEET N
JNWAY PLAN & PROFILE	14	TAXIWAY A MARKING PLAN	45		
JNWAY PLAN & PROFILE	15	TAXIWAY J MARKING PLAN	46	SURVEY CONTROL (TO BE PROVIDED WITH NEXT SUBMITTAL)	AB1
XIWAY B PLAN & PROFILE	16	TAXIWAY G MARKING PLAN	47	CONSTRUCTION SAFETY AND PHASING PLAN	AD1 – AD1
XIWAY A & J PLAN & PROFILE	17	GA APRON MARKING PLAN	48		
AXIWAY G PLAN & PROFILE	18	GA APRON MARKING PLAN	49	REFERENCE D	RAWINGS
ROAD PLAN AND PROFILE	19	GA APRON MARKING PLAN	50	SHEET TITLE	SHEET N
ROAD PLAN AND PROFILE	20	GA APRON AND GA GRAVEL APRON MARKING RLAN	51	JILLI IIILL	JILLI
XXIWAY C, D GRADING & LAYOUT PLAN	21	RUNWAY MARKING DETAILS	52		
.XIWAY B — SOUTH GRADING & LAYOUT PLAN	22	RUNWAY MARKING DETAILS	53		
XIWAY B — NORTH GRADING & LAYOUT PLAN	23	TAXIWAY MARKING DETAILS	54		
XXIWAY A GRADING & LAYOUT PLAN	24	TAXIWAY MARKING DETAILS	55		
AXIWAY J GRADING & LAYOUT PLAN	25	TIE-DOWN MARKING DETAILS	56		
XIWAY G GRADING & LAYOUT PLAN	26	CLOSURE MARKER DETAILS	57		
SPOSAL AREA GRADING PLAN	27	ELECTRICAL PLANS AND DETAILS	E1-30		
APRON GRADING & LAYOUT PLAN	28				
APRON GRADING & LAYOUT PLAN	29				
A APRON GRADING & LAYOUT PLAN	30				
		•			
GA APRON GRADING & LAYOUT PLAN	31				
		HDL ENGINEERING CONSULTANTS, LLC			HOMER AIRPORT DATE
		3335 ARCTIC BOULEVARD, STE 100 ANCHORAGE, AK 99503 (907) 564-2120 CERTIFICATE OF AUTHORIZATION	DATE REVISION	AND PUBLIC FACILITIES	HOMER, ALASKA IER AIRPORT IMPROVEMENTS PROJECT No. CFAPT00491 P No. 3-02-0122-020-2022 INDEX 2

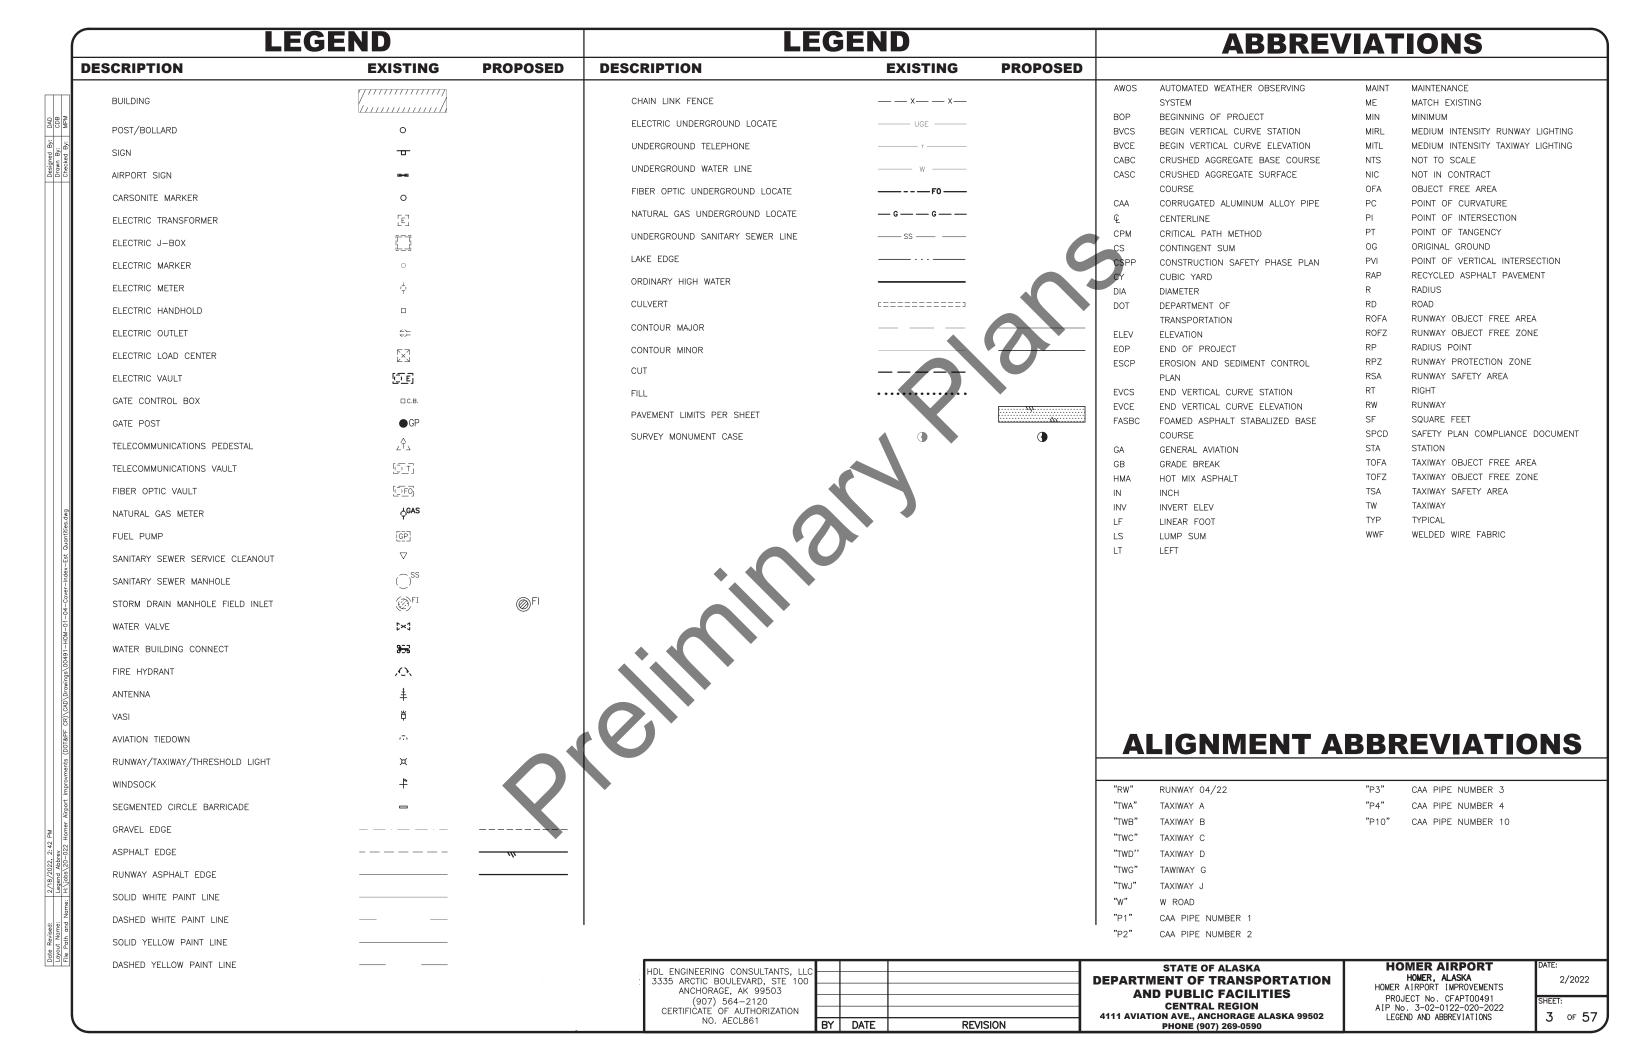

(ESTIMATED QUANTITIES											
	No.	ITEM	UNIT	QUANTITY	No.	ITEM	UNIT	QUANTITY	No.	ITEM	UNIT	QUANTITY
DAD CDB MPM	D701.040.0018	CAA PIPE, 18-INCH	LF	60.00	G150.010.0075	EQUIPMENT RENTAL, DOZER 75-HP MINIMUM	HR	120.00	L125.110.0000	RELOCATE EXISTING AIRPORT SIGN, TYPE L-858	EACH	9.00
igned By: wn By: scked By:	D701.040.0024	CAA PIPE, 24-INCH	LF	134.00	G150.030.0000	EQUIPMENT RENTAL, VAC-TRUCK	CS	ALL REQUIRED	L125.130.0000	AIRPORT SIGN, L-858	EACH	12.00
Dra	D701.040.0036	CAA PIPE, 36-INCH	LF	681.00	G200.010.0000	CONTRACTOR QUALITY CONTROL PROGRAM	LS	ALL REQUIRED	L125.150.0000	HANDHOLE, L-867, SIZE B	EACH	24.00
	D701.040.0042	CAA PIPE, 42-INCH	LF	122.00	G300.010.0000	CPM SCHEDULING	LS	ALL REQUIRED	L125.170.0000	SPARE PARTS	CS	ALL REQUIRED
	D701.040.0048	CAA PIPE, 48-INCH	LF	676.00	G300.020.0000	SCHEDULE PRICE ADJUSTMENT	CS	ALL REQUIRED	1125.180.0000	TEMPORARY RUNWAY LIGHTING SYSTEM	LS	ALL REQUIRED
	D701.190.0018	CAA PIPE END SECTION, 18-INCH	EACH	2.00	G301.010.0000	PULL PLANNING	LS	ALL REQUIRED	L125.250.0000	REMOVE AIRPORT SIGN	EACH	3.00
	D701.190.0024	CAA PIPE END SECTION, 24-INCH	EACH	1.00	G310.010.0000	PUBLIC UPDATES	LS	ALL REQUIRED	L125.400.0000	ADJUST HANDHOLE	EACH	1.00
	D701.190.0036	CAA PIPE END SECTION, 36-INCH	EACH	12.00	G700.010.0000	AIRPORT FLAGGER	CS	ALL REQUIRED	L132.040.0000	APROACH LIGHTING AIDS MODIFICATIONS	LS	ALL REQUIRED
	D701.190.0042	CAA PIPE END SECTION, 42-INCH	EACH	2.00	G705.010.0000	WATERING FOR DUST CONTROL	MGAL	700.00	P151.040.0000	CLEARING & GRUBBING	LS	ALL REQUIRED
	D751.010.0048	MANHOLE, TYPE I, 48-INCH	EACH	1.00	L107.050.0000	RELOCATE WIND CONE	EACH	1.00	P152.010.0000	UNCLASSIFIED EXCAVATION	СУ	276,000.00
	D752.060.3020	CONCRETE HEADWALL, TYPE II	EACH	4.00	L108.010.2008	UNDERGROUND CABLE #8 AWG, COPPER, 5KV FAA TYPE C, 1-824	LF	52,121.00	P152.200.0010	BORROW, TYPE A	TON	0.00
ss.dwg	G100.010.0000	MOBILIZATION AND DEMOBILIZATION	LS	ALL REQUIRED	L108.030.0006	#6 BARE COPPER GROUND CONDUCTOR	LF	67,133.00	P152.390.0000	DITCH LINING	TON	50,000.00
Est Quantitie	G115.010.0000	WORKER MEALS AND LODGING, OR PER DIEM	LS	ALL REQUIRED	L108.070.0000	GROUND ROD	EACH	84.00	P154.020.0000	SUBBASE COURSE	TON	32,700.00
over-Index-	G130.010.0000	FIELD OFFICE	LS	ALL REQUIRED	L108.080.0014	UNDERGROUND CABLE #14 AWG, 2-CONDUCTOR, COPPER, 600V, TYPE "SOOW-A/SOOW"	LF	520.00	P161.010.0000	RECYCLED ASPHALT PAVEMENT	SY	102,000.00
1-01-04-Cc	G130.020.0000	FIELD LABORATORY	LS	ALL REQUIRED	L110.050.1004	RIGID STEEL CONDUIT, 4-INCH	LF	2,310.00	P165.040.0000	REMOVAL OF STORM DRAIN PIPE	LS	ALL REQUIRED
00491-HOM	G130.060.0000	NUCLEAR TESTING EQUIPMENT STORAGE SHED	EACH	1.00	L110.080.1002	HDPE CONDUIT, 2-INCH	LF	32,654.00	P165.050.0010	REMOVAL OF STORM DRAIN MANHOLE	EACH	1.00
(D\Drawings	G130.090.0000	ENGINEERING COMMUNICATIONS	CS	ALL REQUIRED	L110.240.0000	DRYWELL	EACH	23.00	P170.020.0000	SOIL TESTING PROGRAM	CS	ALL REQUIRED
&PF CR)\C/	G131.010.0000	ENGINEERING TRANSPORTATION (TRUCK)	EACH	4.00	L119.010.0000	OBSTRUCTION LIGHT	EACH	1.00	P170.040.0000	SUPPLEMENTAL LABORATORY TEST	CS	ALL REQUIRED
ments (DOT	G135.010.0000	CONSTRUCTION SURVEYING BY THE CONTRACTOR	LS	ALL REQUIRED	L125.020.0000	REGULATOR, L-828	EACH	1.00	P170.080.0000	"HOT" MATERIAL OFFSITE TRANSPORTATION AND DISPOSAL	CS	ALL REQUIRED
rport Improv	G135.020.0000	EXTRA THREE PERSON SURVEY PARTY	HR	132.00	L125.030.0000	MEDIUM INTENSITY RUNWAY EDGE AND THRESHOLD LIGHT, L-861 AND L-861E	EACH	81.00	P171.010.0000	TEMPORARY CONTAMINATED SOIL STOCKPILE	CS	ALL REQUIRED
55 PM 22 Homer Ai	G135.050.0000	CONTRACTOR FURNISHED ENGINEERING TOOLS	CS	ALL REQUIRED	L125.040.0000	TAXIWAY EDGE LIGHT, L-861T	EACH	151.00	P171.050.0000	CONTAMINATED SOIL SEPARATOR LINER	SY	500.00
18/2022, 1: t Quantities jobs\20-02	G135.210.0000	ADJUST EXISTING MONUMENT CASE	EACH	4.00	L125.070.0000	REMOVE RUNWAY AND TAXIWAY LIGHT	EACH	190.00	P180.020.0000	RIPRAP, CLASS I	TON	190.00
2/1 Est Name: H:\												
te Revised: /out Name: } Path and									l			
Date Layou File F					HDL	ENGINEERING CONSULTANTS, LLC				ATE OF ALASKA HOMER		

HDL ENGINEERING CONSULTANTS, LLC
3335 ARCTIC BOULEVARD, STE 100
ANCHORAGE, AK 99503
(907) 564-2120
CERTIFICATE OF AUTHORIZATION
NO. AECL861
BY DATE REVISION

STATE OF ALASKA
DEPARTMENT OF TRANSPORTATION
AND PUBLIC FACILITIES
CENTRAL REGION
4111 AVIATION AVE., ANCHORAGE ALASKA 99502
PHONE (907) 269-0590

HOMER AIRPORT

HOMER, ALASKA

HOMER AIRPORT IMPROVEMENTS

PROJECT No. CFAPT00491

AIP No. 3-02-0122-020-2022

ESTIMATED QUANTITIES

2/2022

SHEET: **4** OF **57**

E	STIMATED QUANT	<u> </u>	ES	E	STIMATED QUA	ANTITIE	S		ESTIMATING FAC	CTORS
No.	ITEM	UNI	F QUANTITY	No.	ITEM	UNIT	QUANTITY	No.	ITEM	FACTOR
P209.020.0000	CRUSHED AGGREGATE BASE COURSE	TON	35,900.00	P655.010.0000	AIRCRAFT RELOCATION	EACH	81.00	G705.010.0000	WATERING FOR DUST CONTROL	40 GAL/SY
P299.020.0000	CRUSHED AGGREGATE SURFACE COURSE	TON	5,850.00	P670.010.0000	HAZARD MARKER BARRIER, PLASTIC	EACH	160.00	P152.190.0010	BORROW, TYPE A	130 LB/CF
P318.020.0000	FOAMED ASPHALT STABILIZED BASE COURSE	SY	75,000.00	P671.010.0000	RUNWAY CLOSURE MARKER, VINYL MESH	EACH	13.00	P152.390.0000	DITCH LINING	110 LB/CF
P318.040.0000	ASPHALT BINDER	TON	810.00	P671.020.0000	RUNWAY CLOSURE MARKER, ILLUMINATED	EACH	2.00	P154.020.0000	SUBBASE COURSE	135 LB/CF
P318.050.0000	PORTLAND CEMENT	TON	590.00	P681.010.0000	GEOTEXTILE, SEPARATION	SY	401,000.00	P180.010.0000	RIPRAP, CLASS I	108 LB/CF
P401.010.0030	HOT MIX ASPHALT TYPE II, CLASS A	TON	36,000.00	T901.010.0000	SEEDING	ACRE	34.00	P209.020.0000	CRUSHED AGGREGATE BASE COURSE	144 LB/CF
P401.020.5834	ASPHALT BINDER, PG 58-34	TON	2,000.00	T901.030.0000	WATER FOR MAINTENANCE	MGAL	1,480.00	P299.020.0000	CRUSHED AGGREGATE SURFACE COURSE	144 LB/CF
P401.070.0000	JOINT ADHESIVE	LF	77,000.00	T905.010.0010	TOPSOILING, CLASS A	SY	164,000.00	P318.020.0000	FOAMED ASPHALT STABILIZED BASE COURSE	130 LB/CF
P401.080.0000	HOT MIX ASPHALT PRICE ADJUSTMENT	CS	ALL REQUIRED	T908.010.0000	MULCHING	SY	164,000.00	P318.040.0000	ASPHALT BINDER	2.75% OF P318.020.0000
P401.090.0000	ASPHALT MATERIAL PRICE ADJUSTMENT	CS	ALL REQUIRED	U200.060.0030	ADJUST SANITARY SEWER MANHOLE BY GRADE RING	EACH	2.00	P318.050.0000	PORTLAND CEMENT	2.0% OF P318.020.0000
P602.010.0010	PRIME COAT, CSS-1	TON	610.00			1		P401.010.0030	HOT MIX ASPHALT TYPE II, CLASS A	151 LB/CF
P603.010.0010	TACK COAT, STE-1	TON	103.00					P401.020.5834	ASPHALT BINDER PG 58-34	5.3% OF P401.010.0030
P620.010.0000	RUNWAY AND TAXIWAY PAINTING	SF	90,000.00		~'0			P603.010.0010	TACK COAT, STE-1	0.000334 TON/SY
P620.060.0000	PAINTED MARKING REMOVAL	LS	ALL REQUIRED					T901.010.0000	SEEDING	0.002 LB/SF
P620.070.0000	TEMPORARY RUNWAY & TAXIWAY PAINTING	LS	ALL REQUIRED					T901.030.0000	WATER FOR MAINTENANCE	0.001 MGAL/SF
P621.020.0000	SAW-CUT GROOVES	LS	ALL REQUIRED	*						
P641.010.0000	EROSION, SEDIMENT, AND POLLUTION CONTROL ADMINISTRATION	LS	ALL REQUIRED							
P641.020.0000	TEMPORARY EROSION, SEDIMENT, AND POLLUTION CONTROL	CS	ALL REQUIRED	. (7)						
P641.060.0000	WITHHOLDING	CS	ALL REQUIRED							
P641.070.0000	SWPPP MANAGER	LS	ALL REQUIRED							
P650.010.0000	AIRCRAFT TIE-DOWN	EACH	123.00							
P650.050.0000	REMOVE TIE-DOWN	EACH	81.00							
				HDI	_ ENGINEERING CONSULTANTS, LLC			ST	ATE OF ALASKA HOMER	AIRPORT DATE:


HDL ENGINEERING CONSULTANTS, LLC


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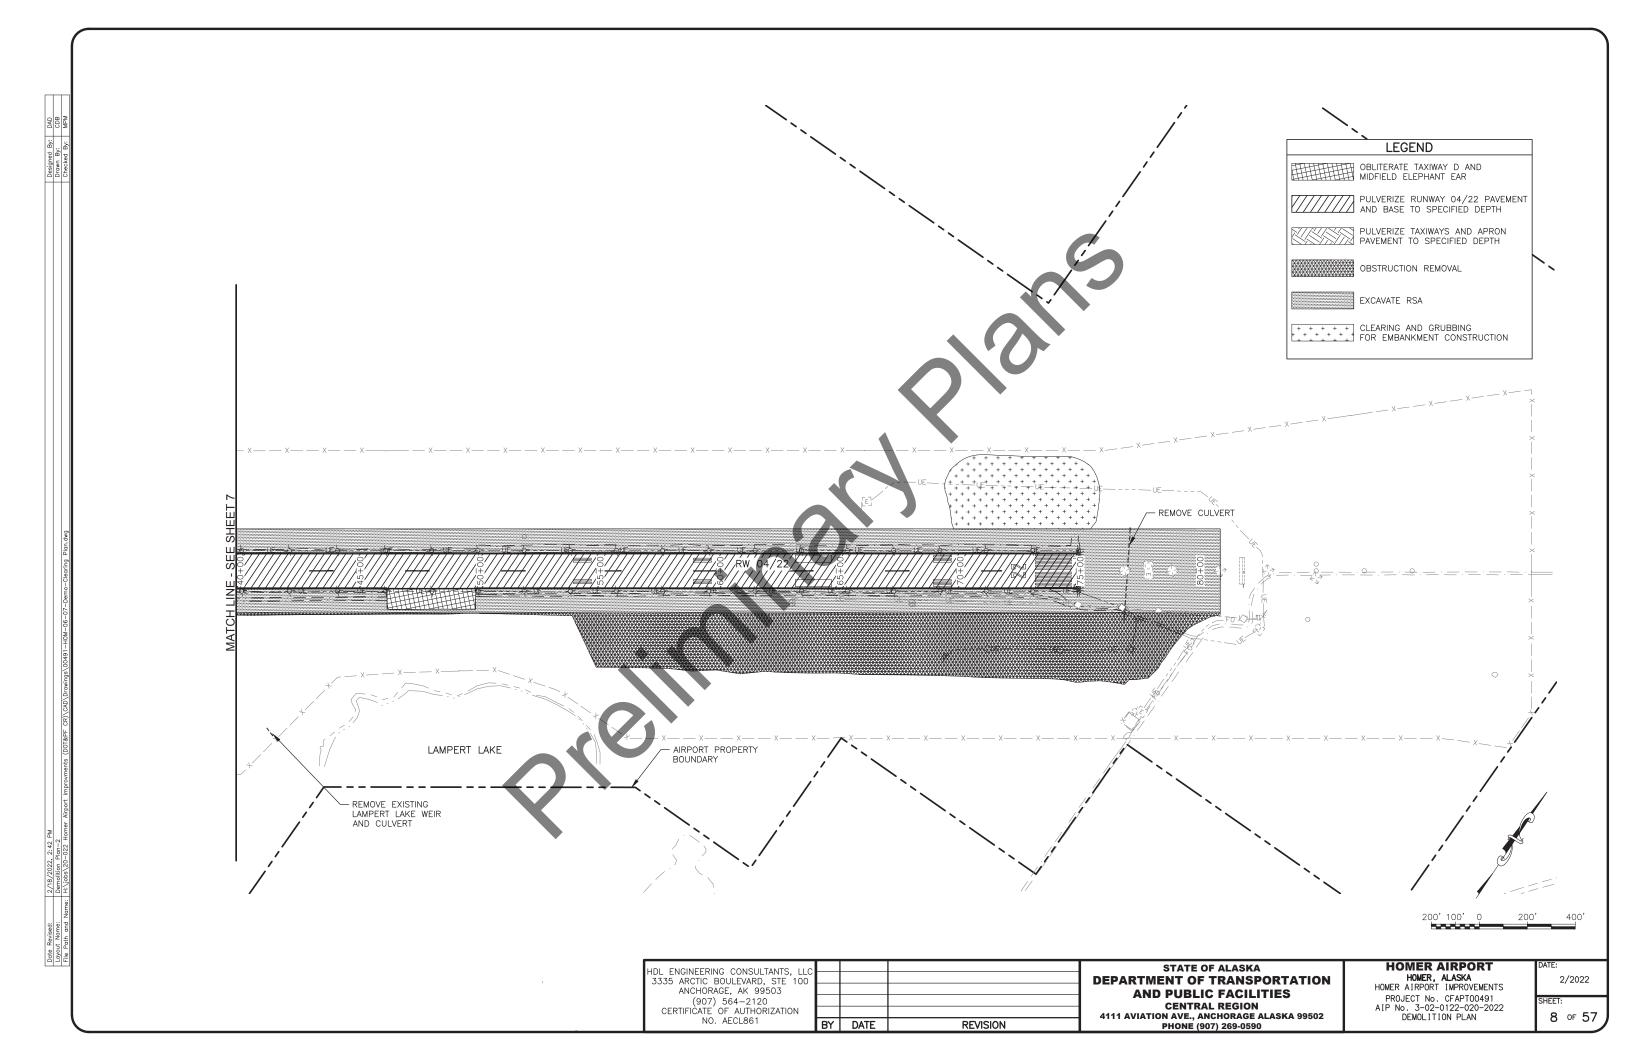
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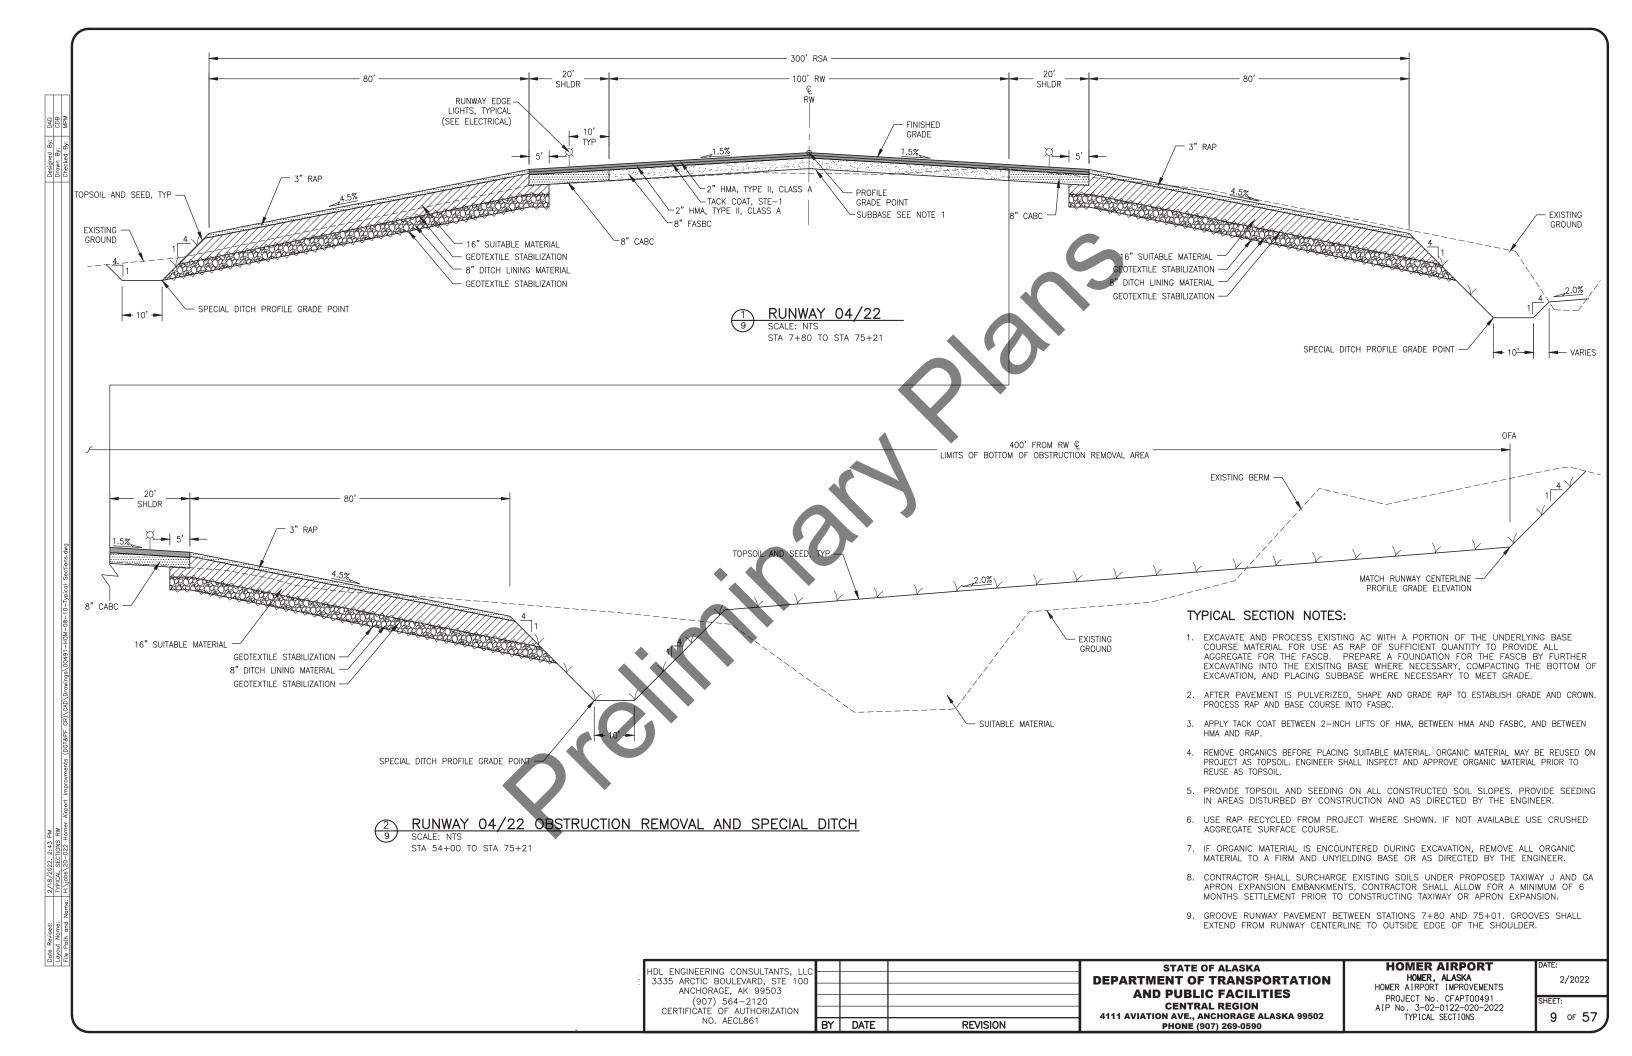
HOMER AIRPORT
HOMER, ALASKA
HOMER AIRPORT IMPROVEMENTS
PROJECT No. CFAPT00491
AIP No. 3-02-0122-020-2022
ESTIMATED QUANTITIES AND FACTORS


2/2022 SHEET: 5 OF 57







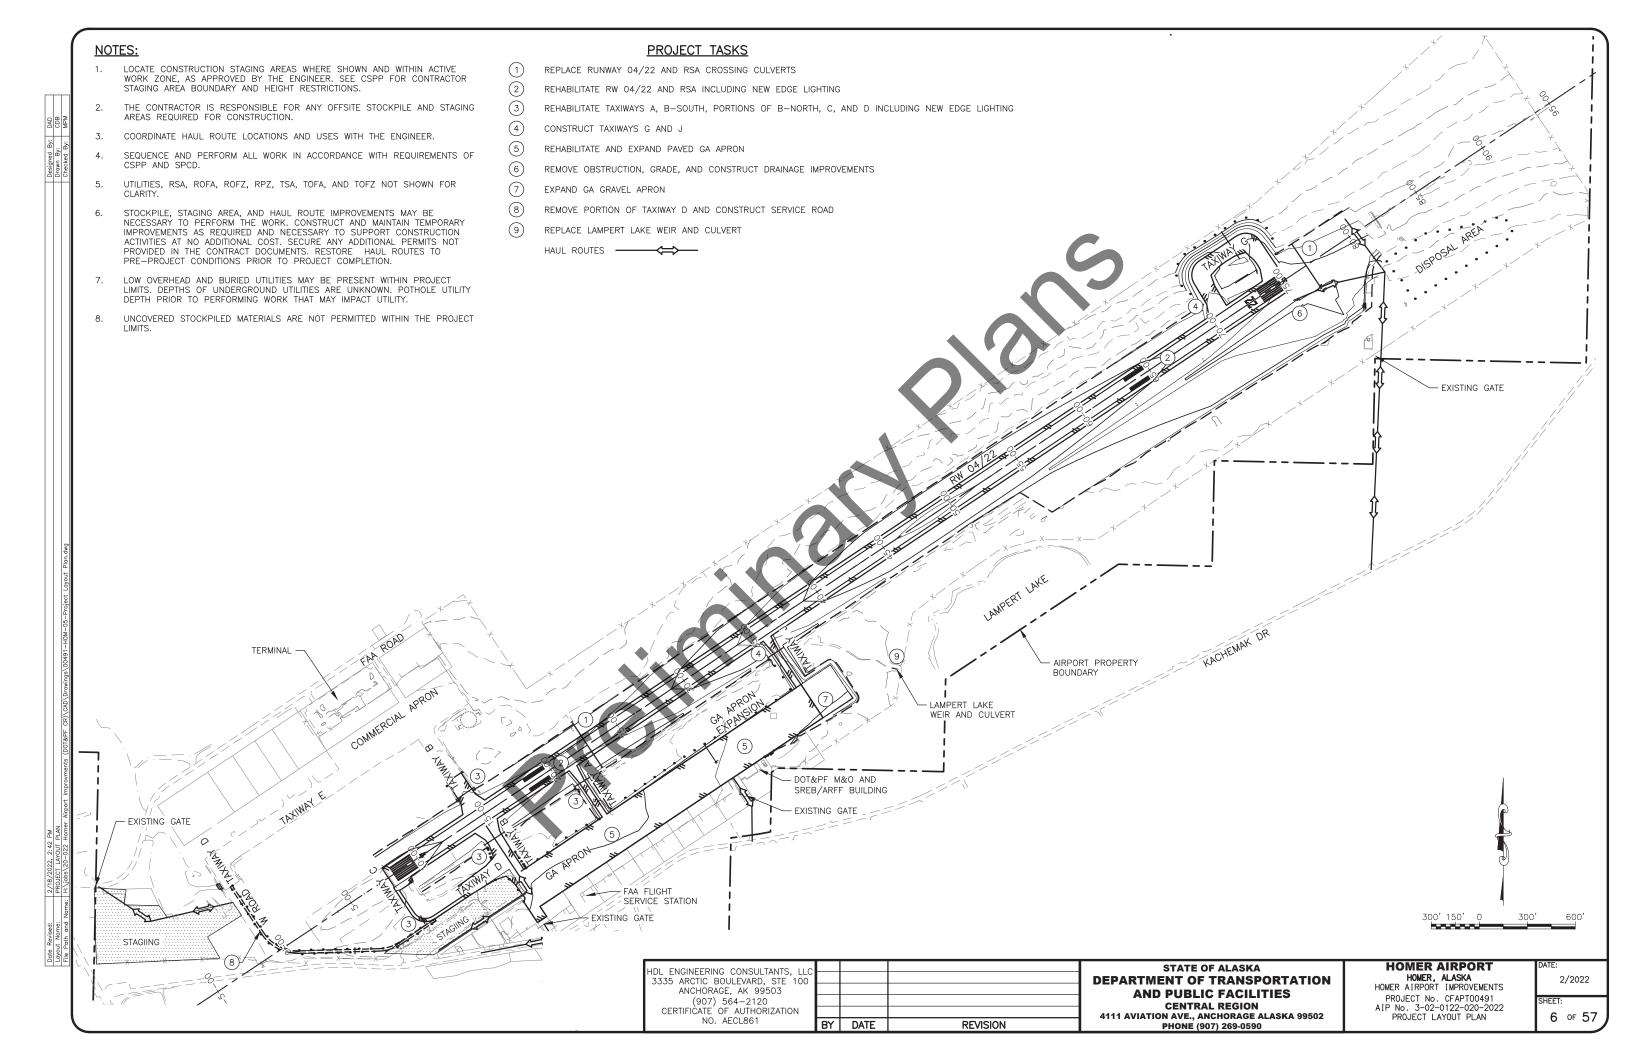


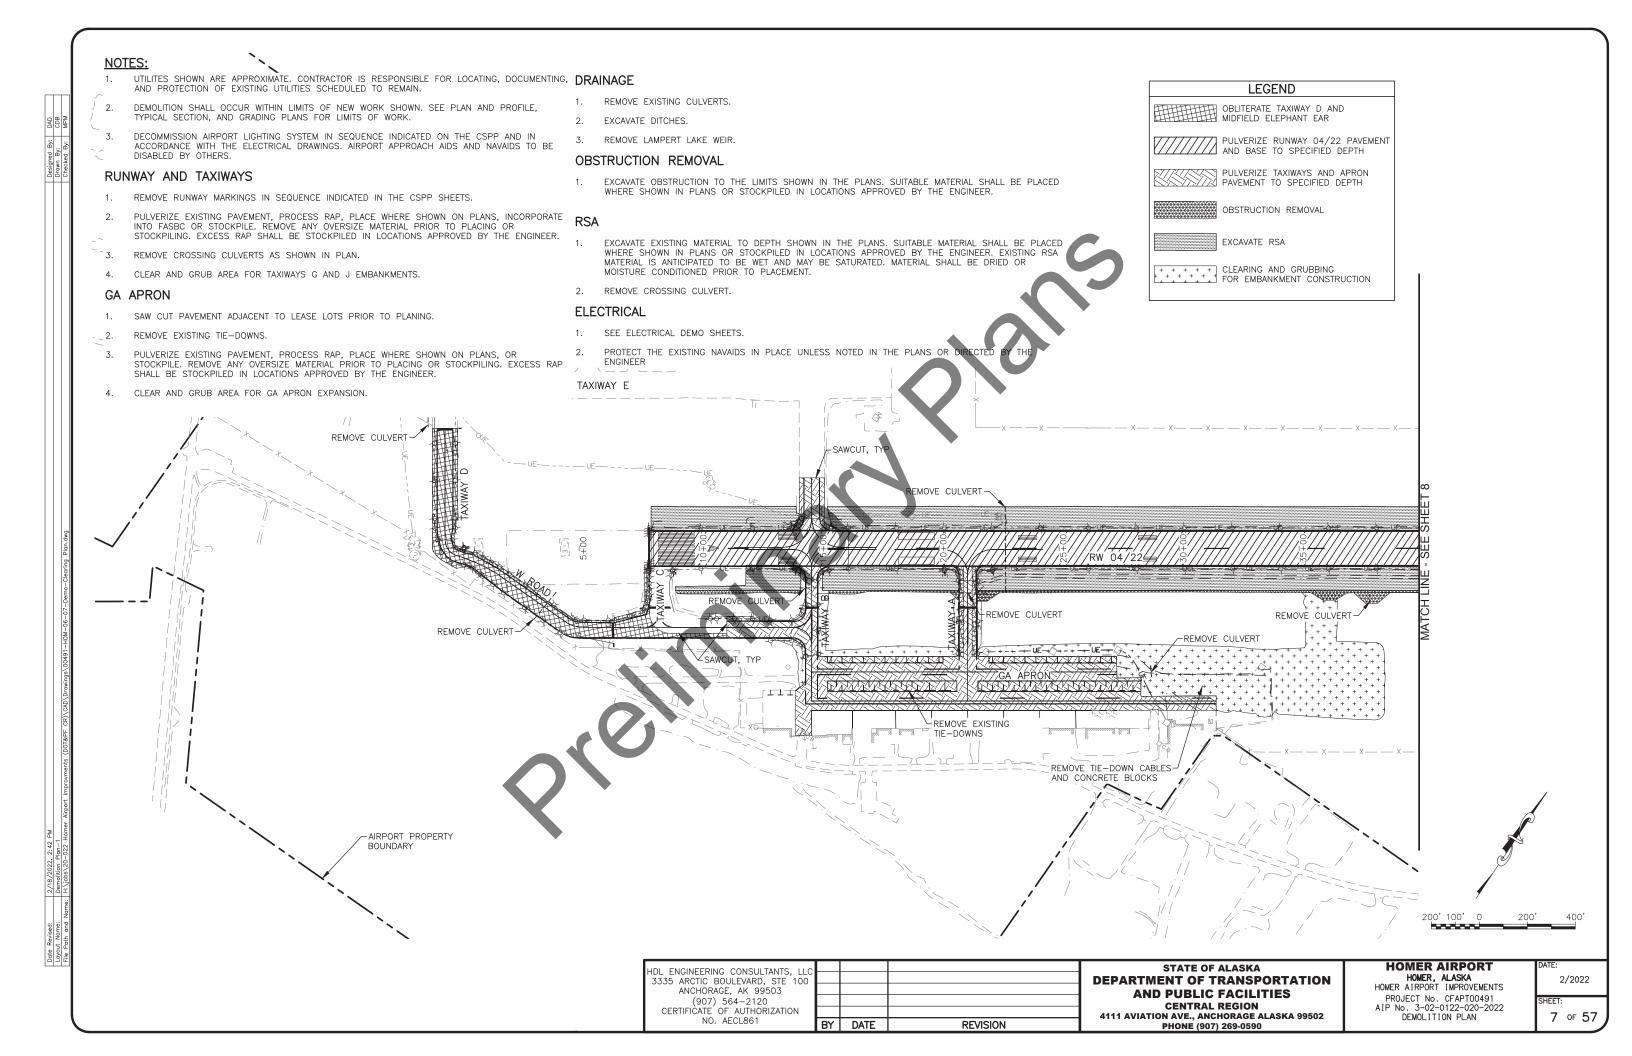


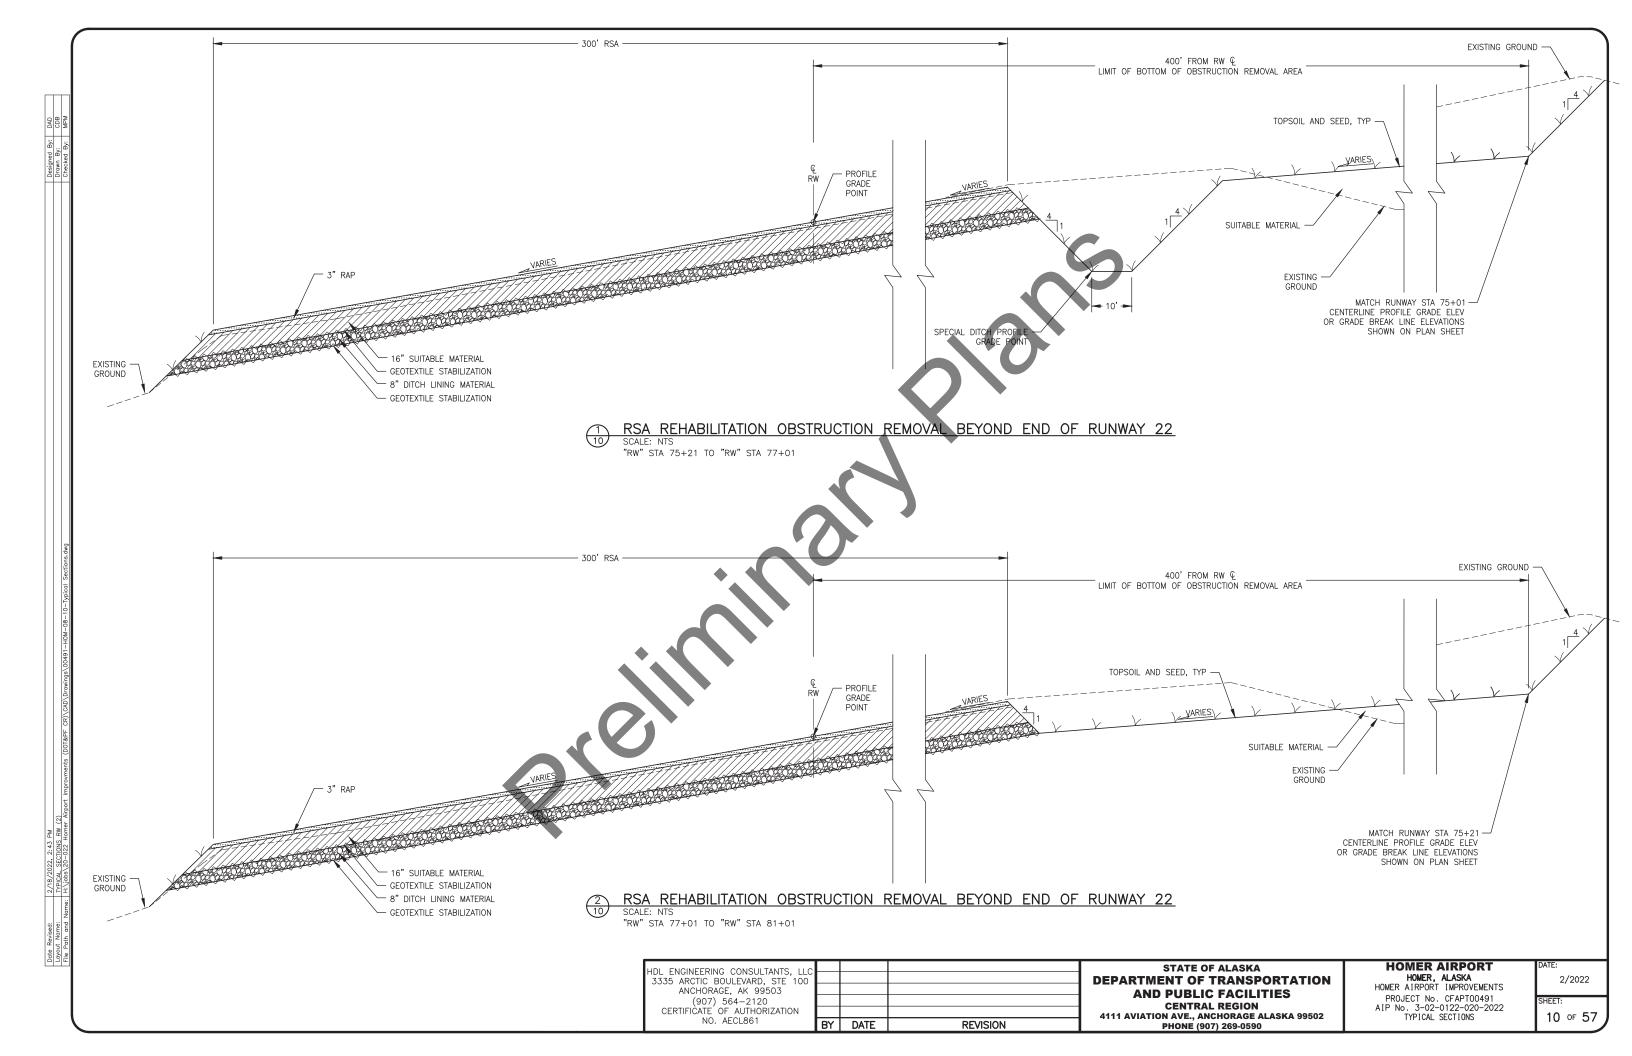


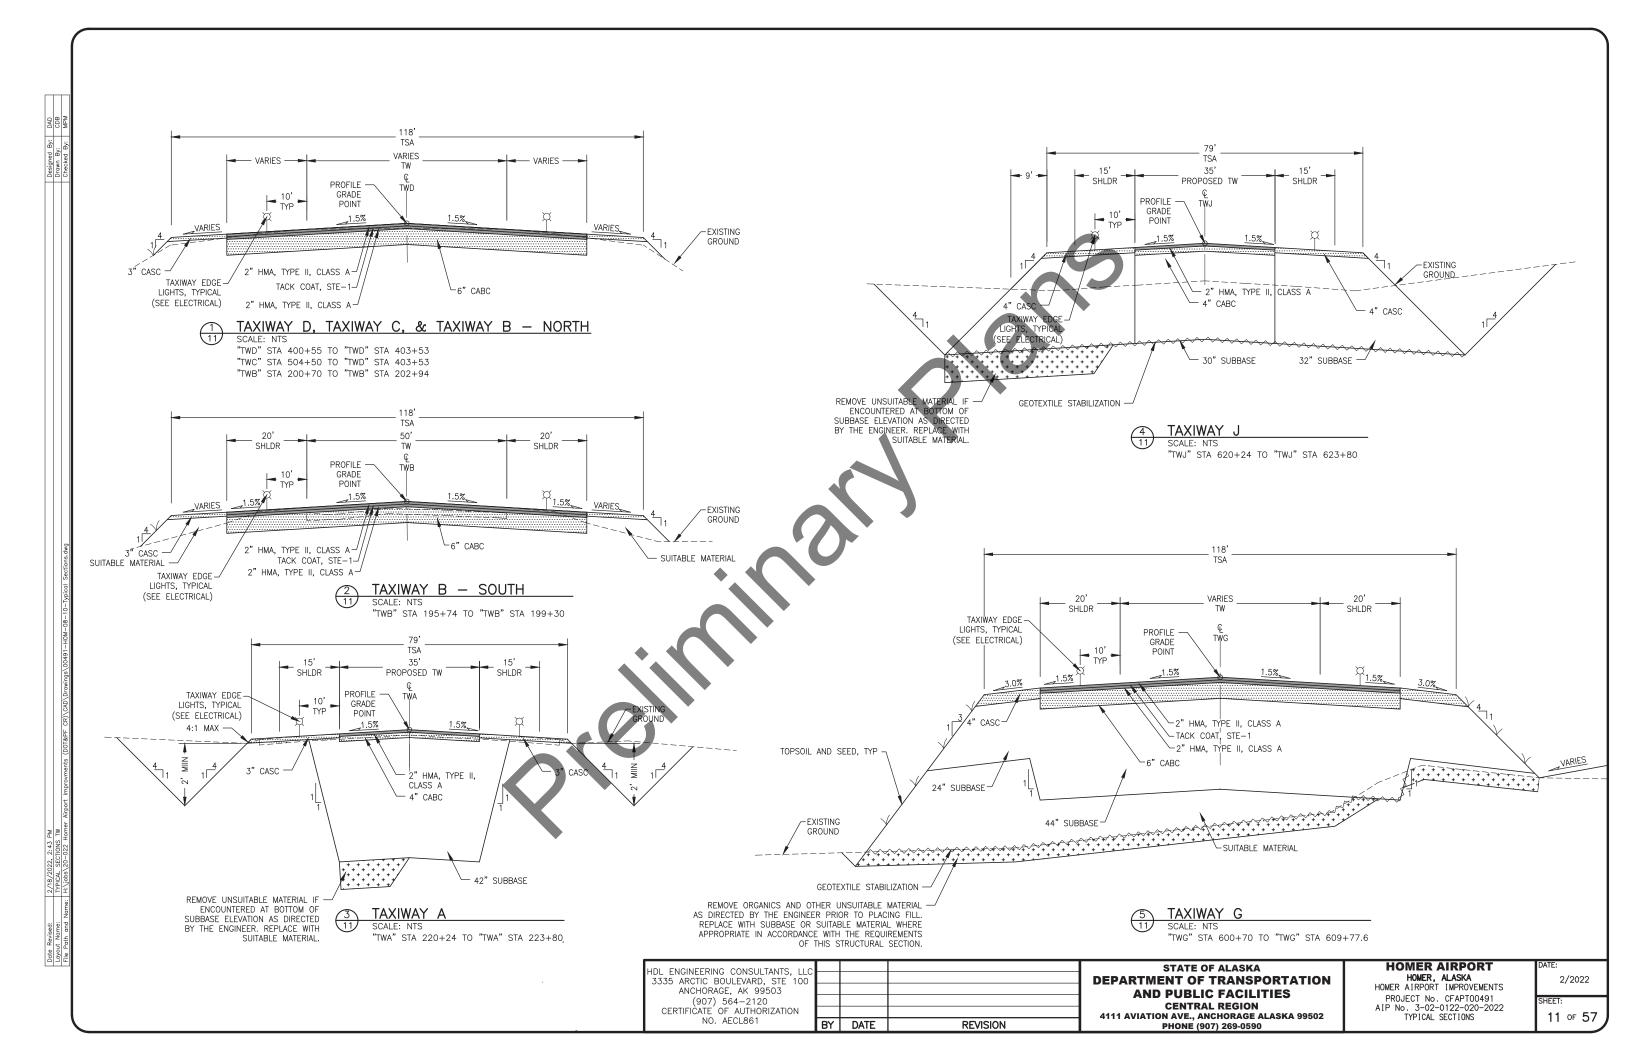


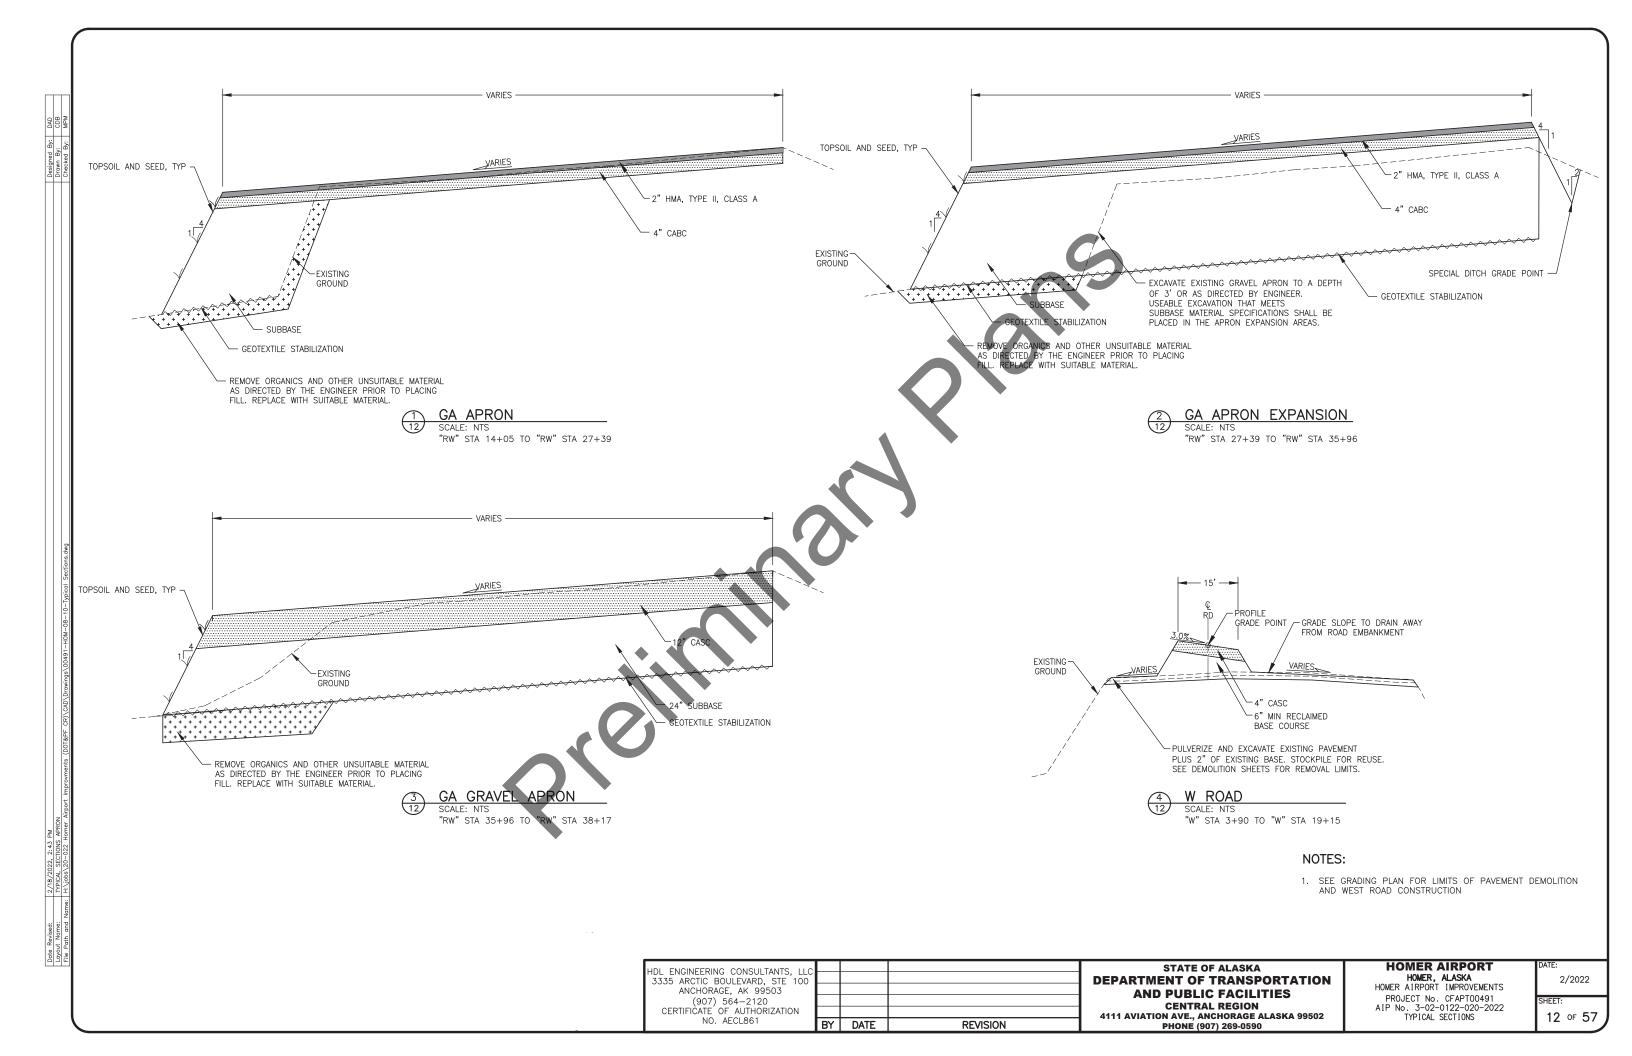


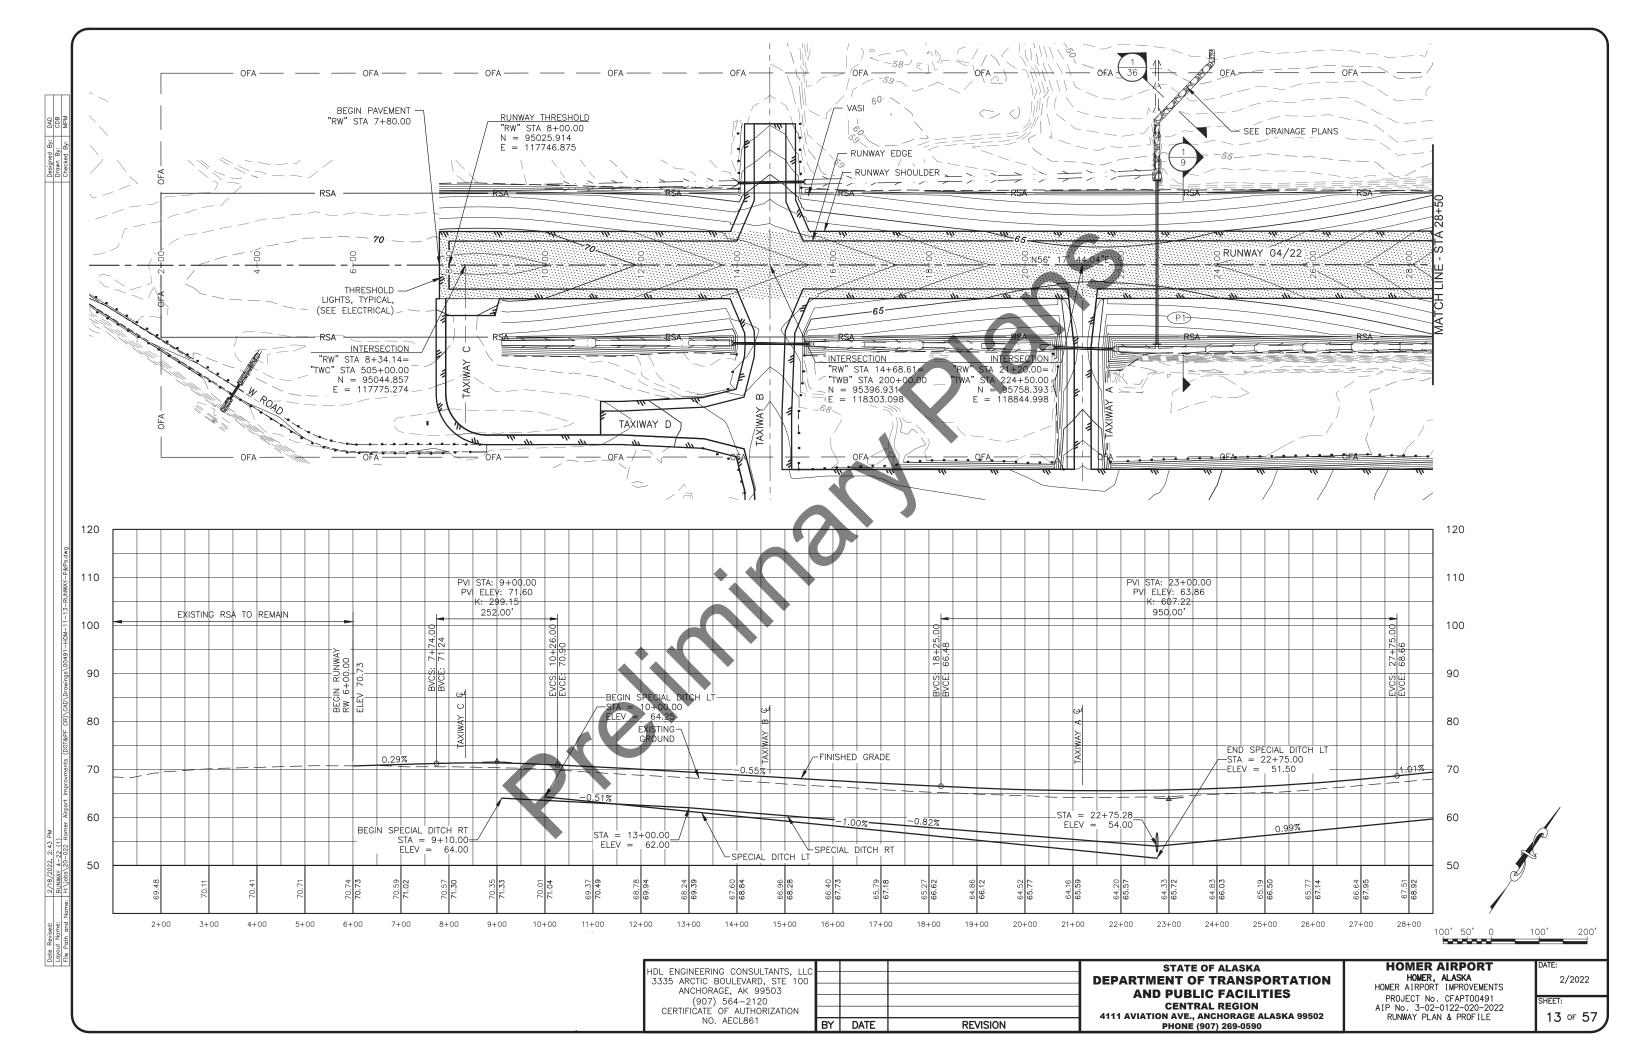


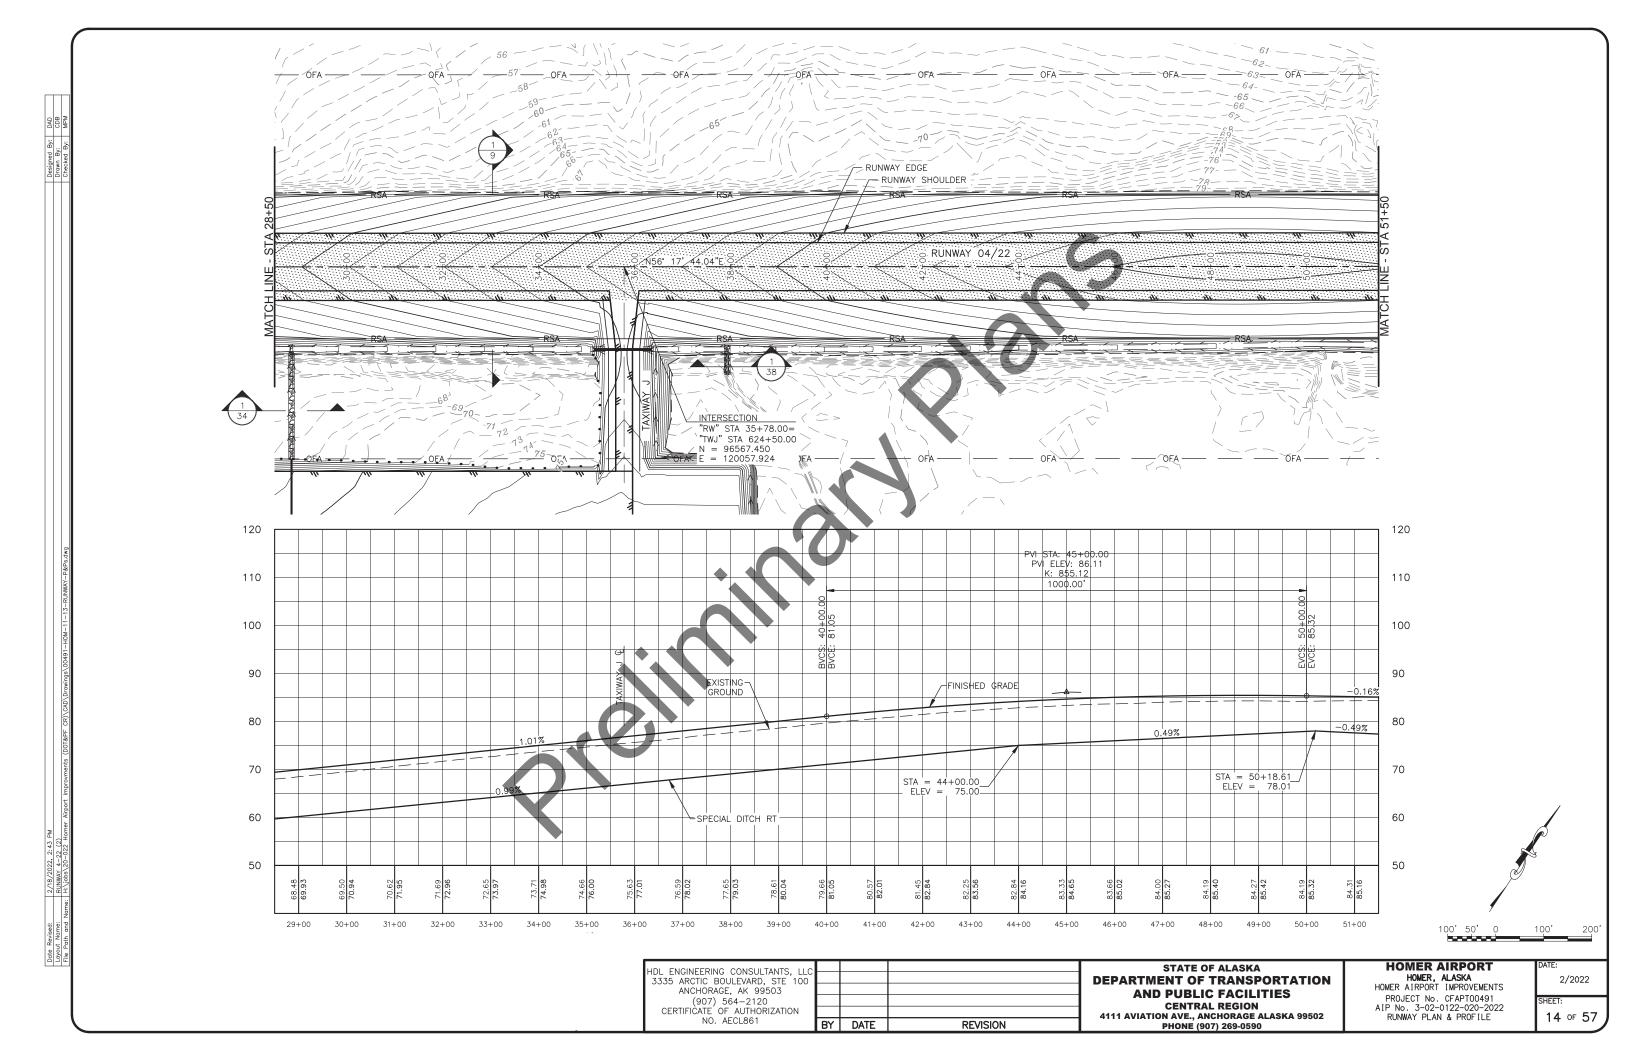


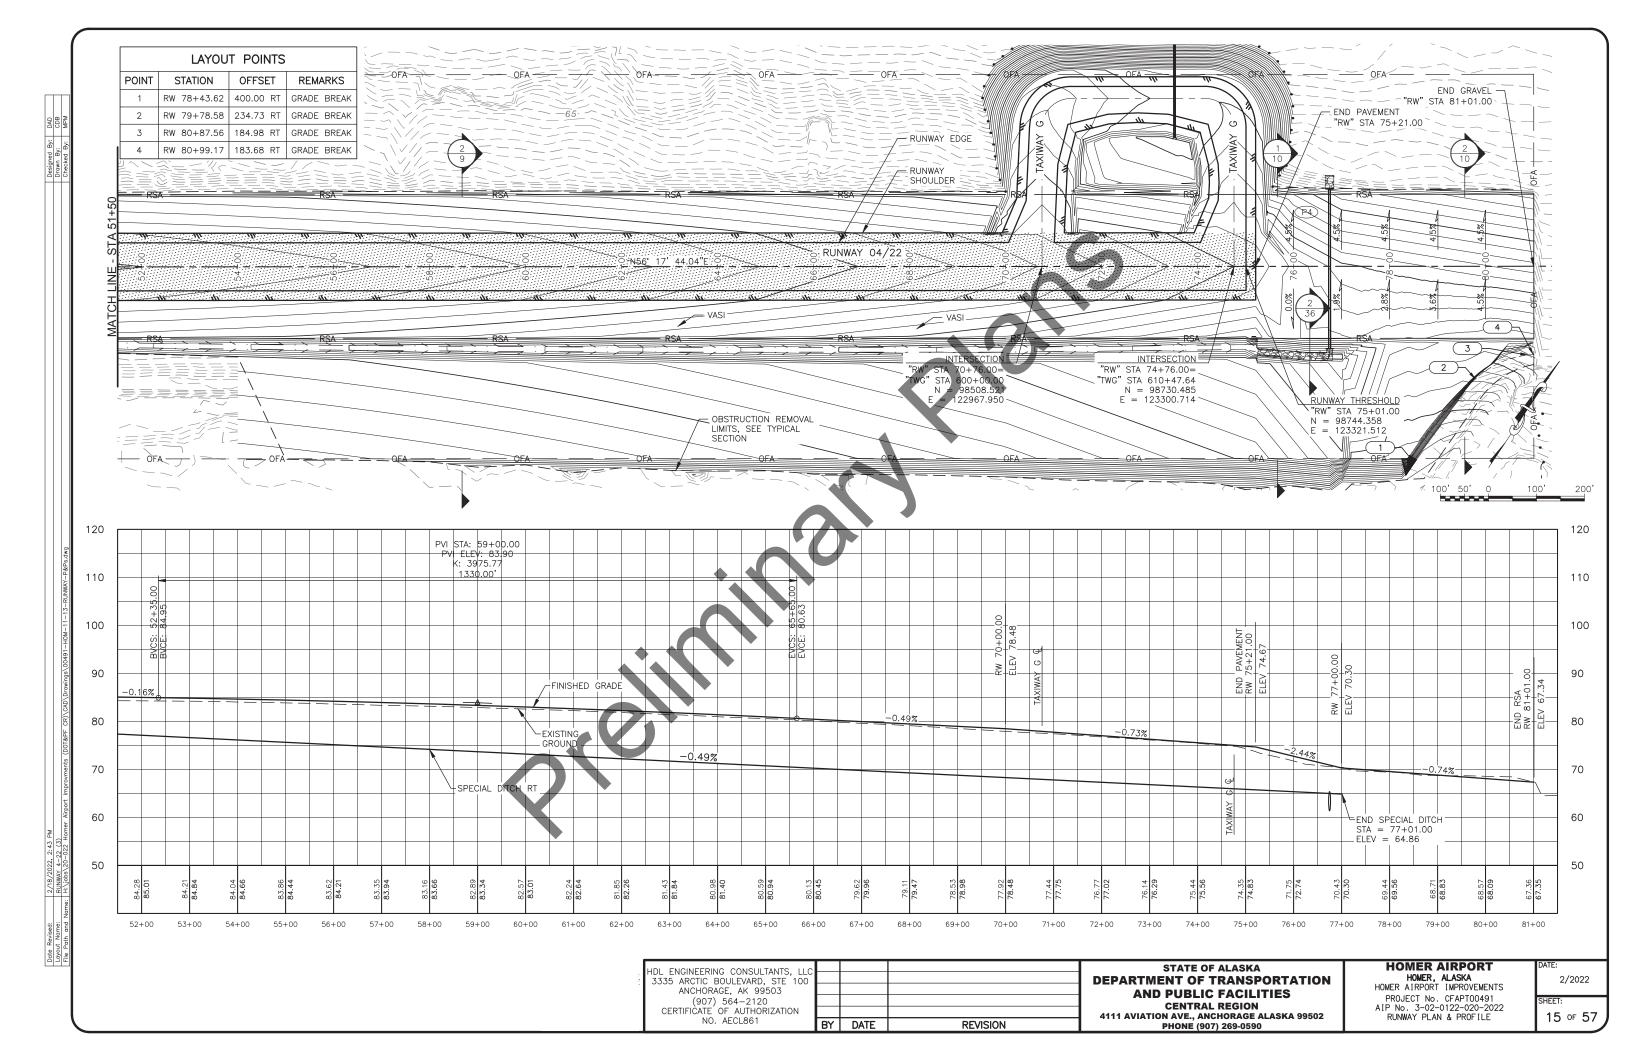


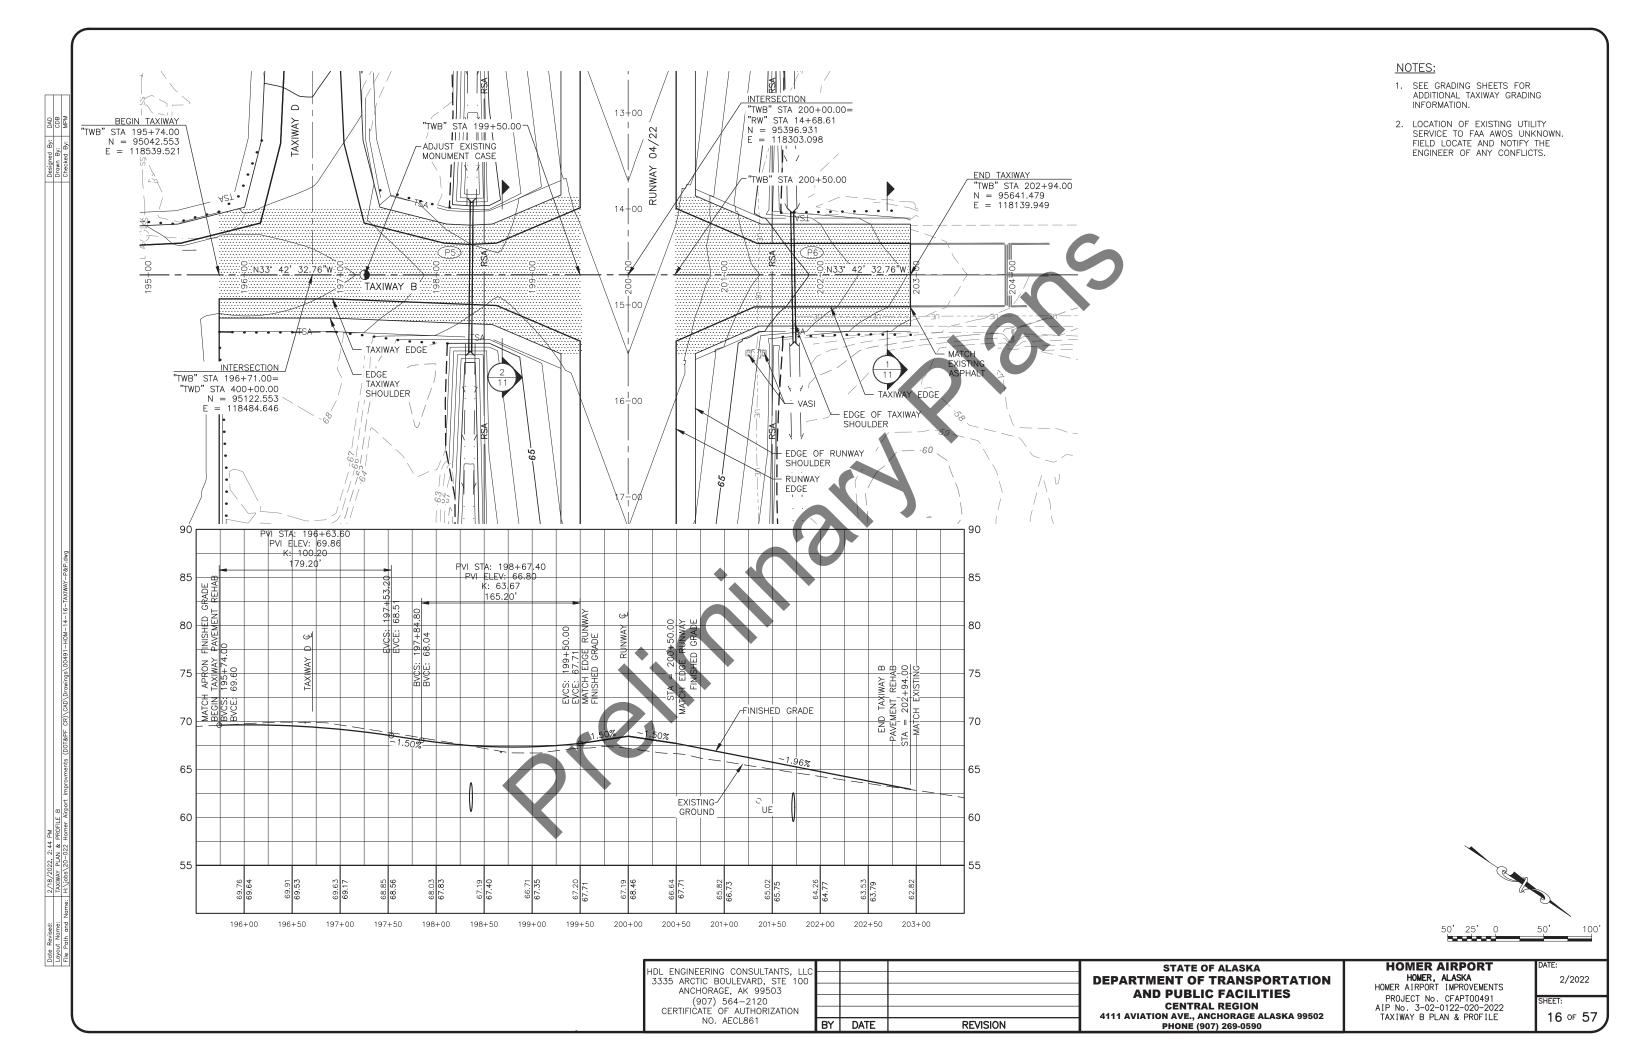


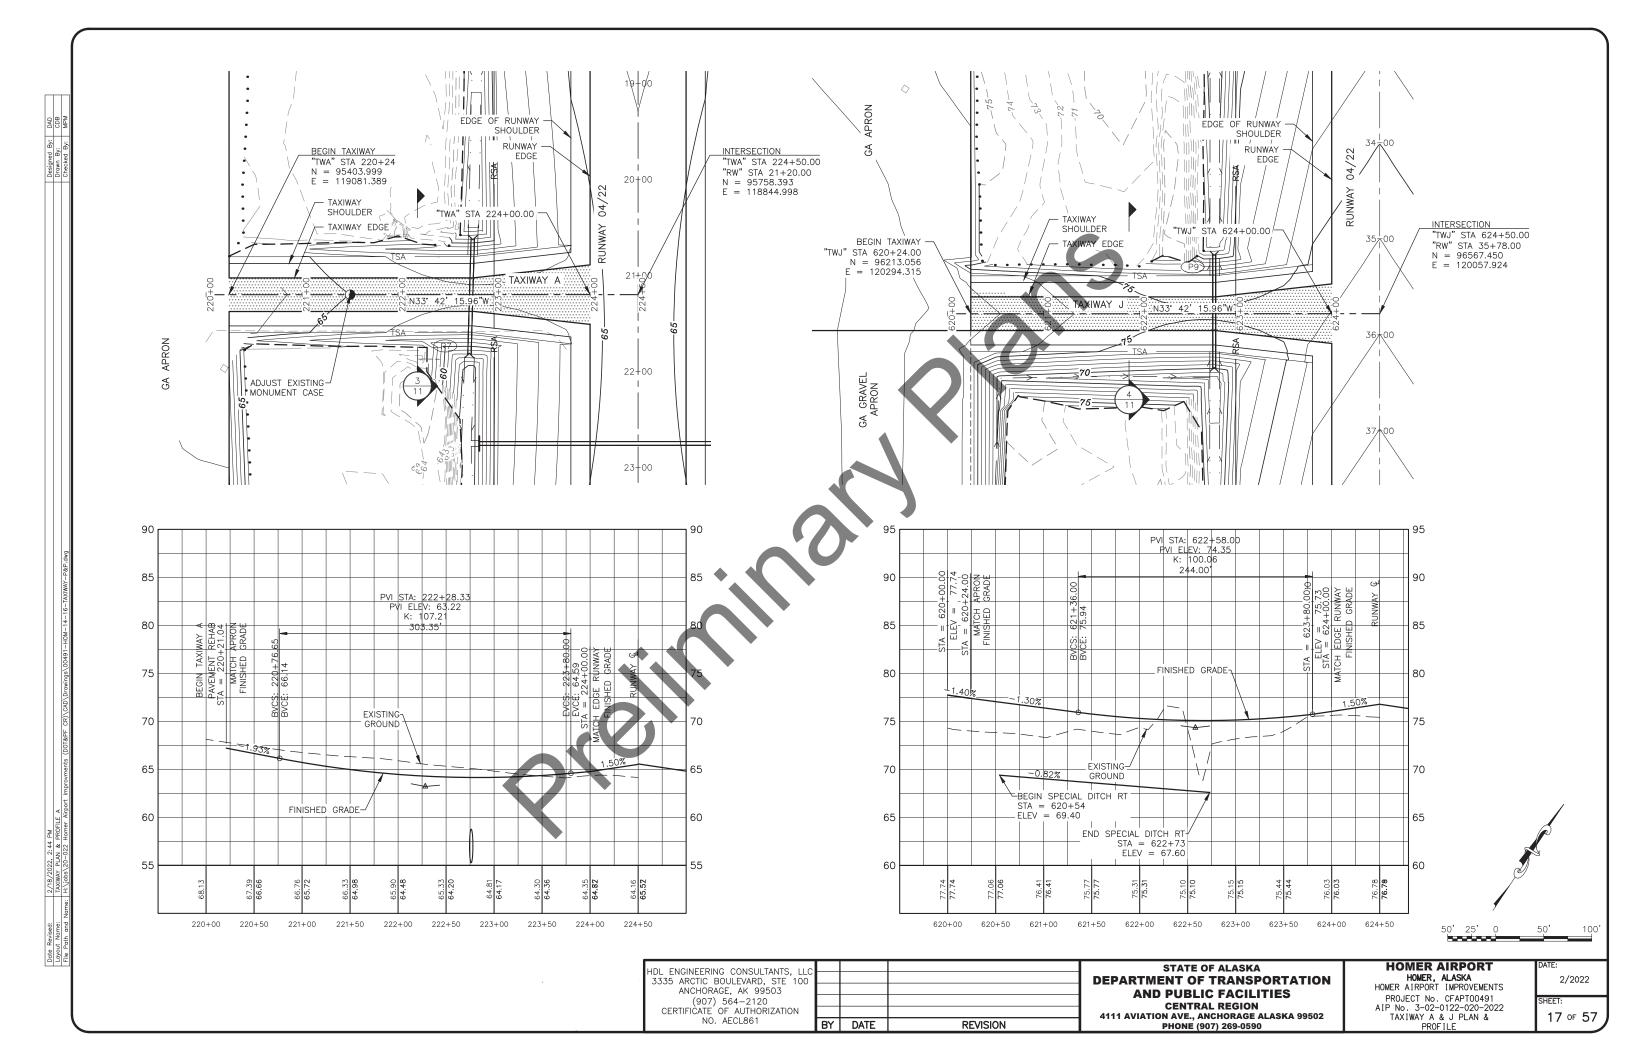


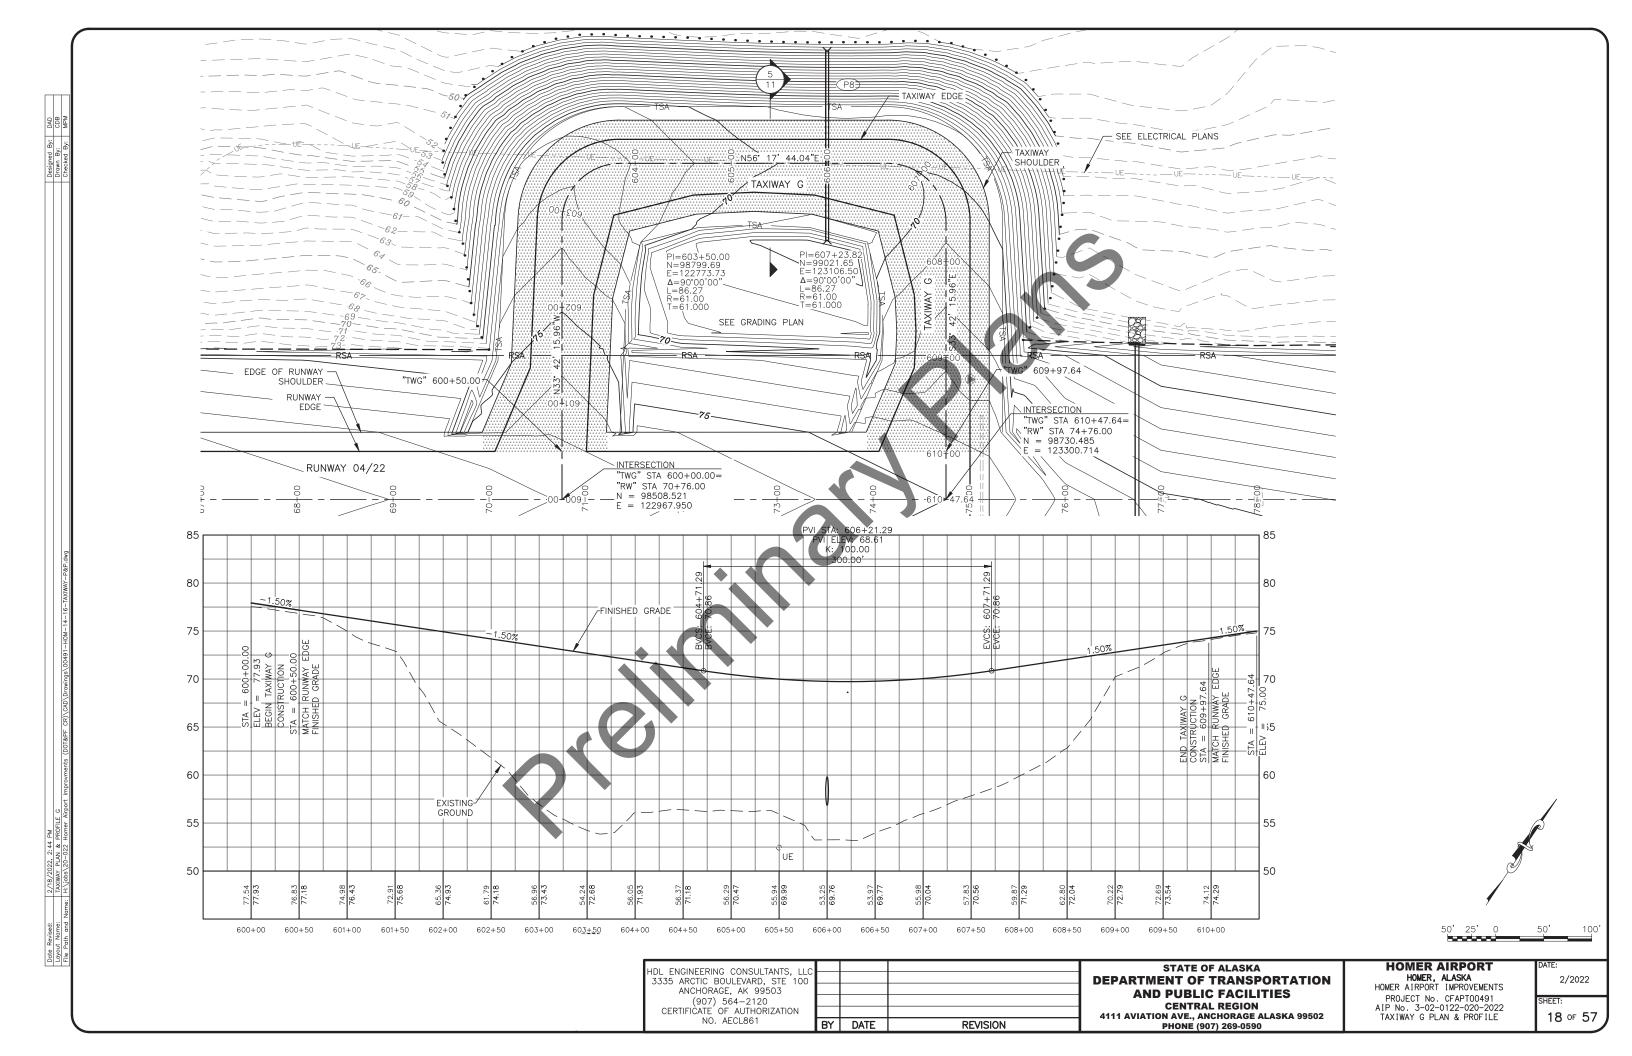


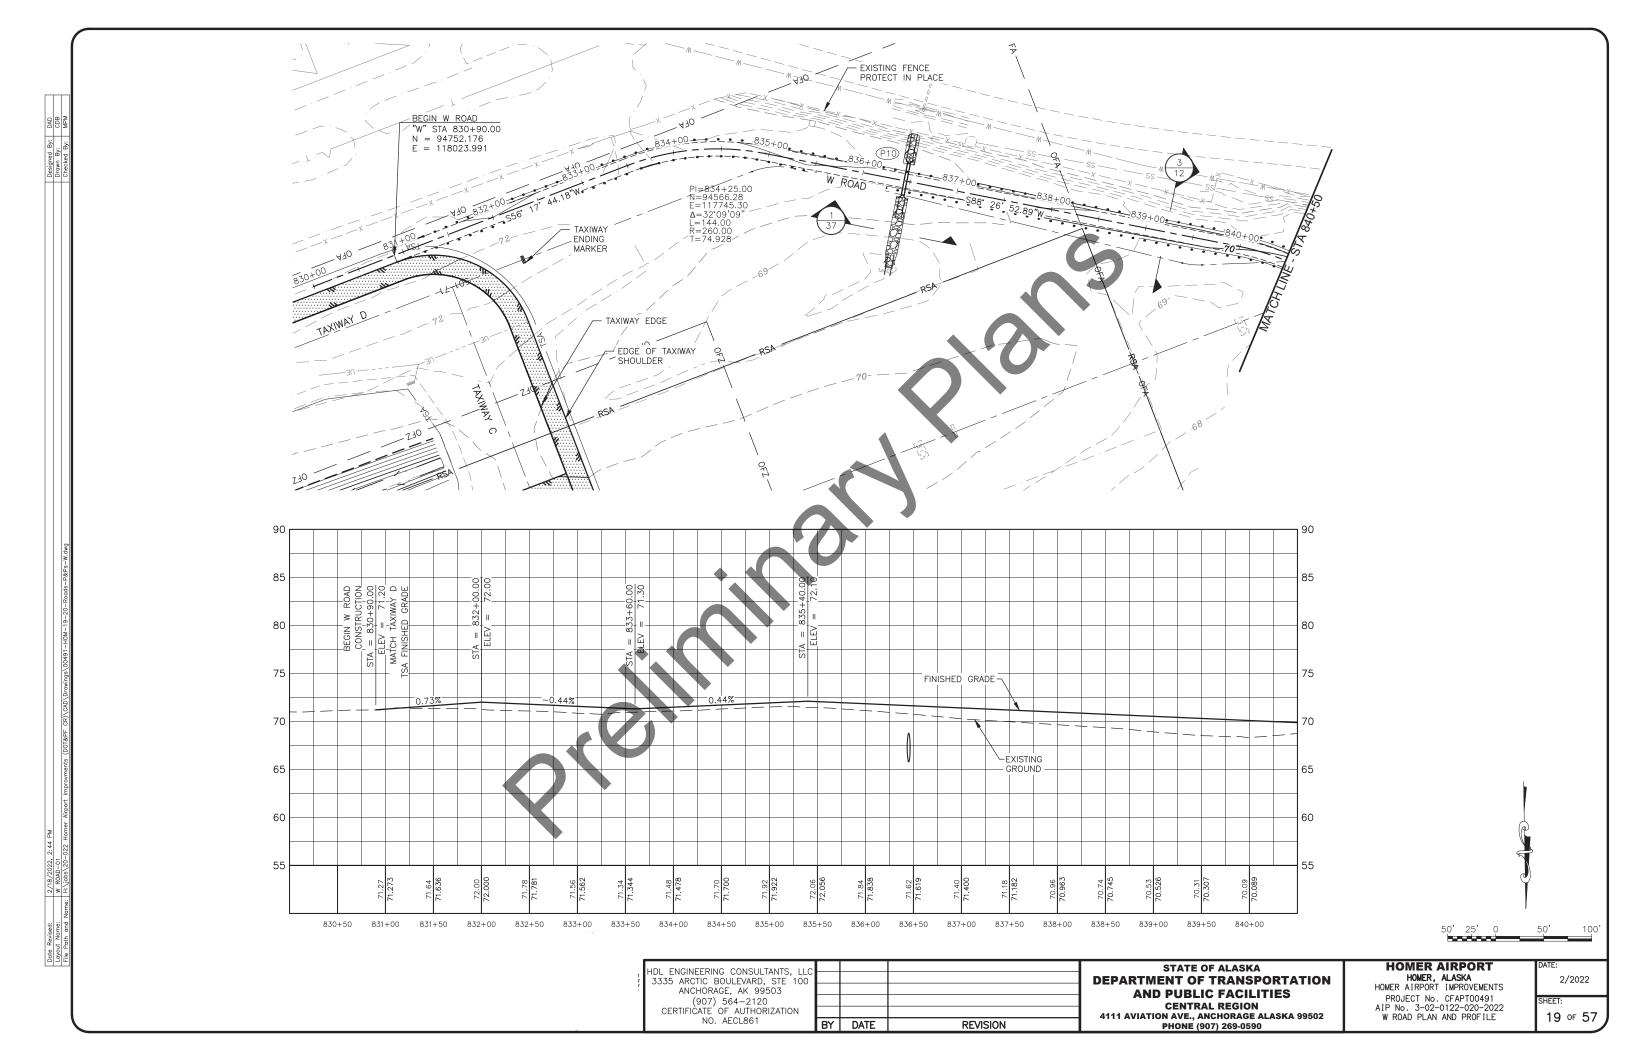


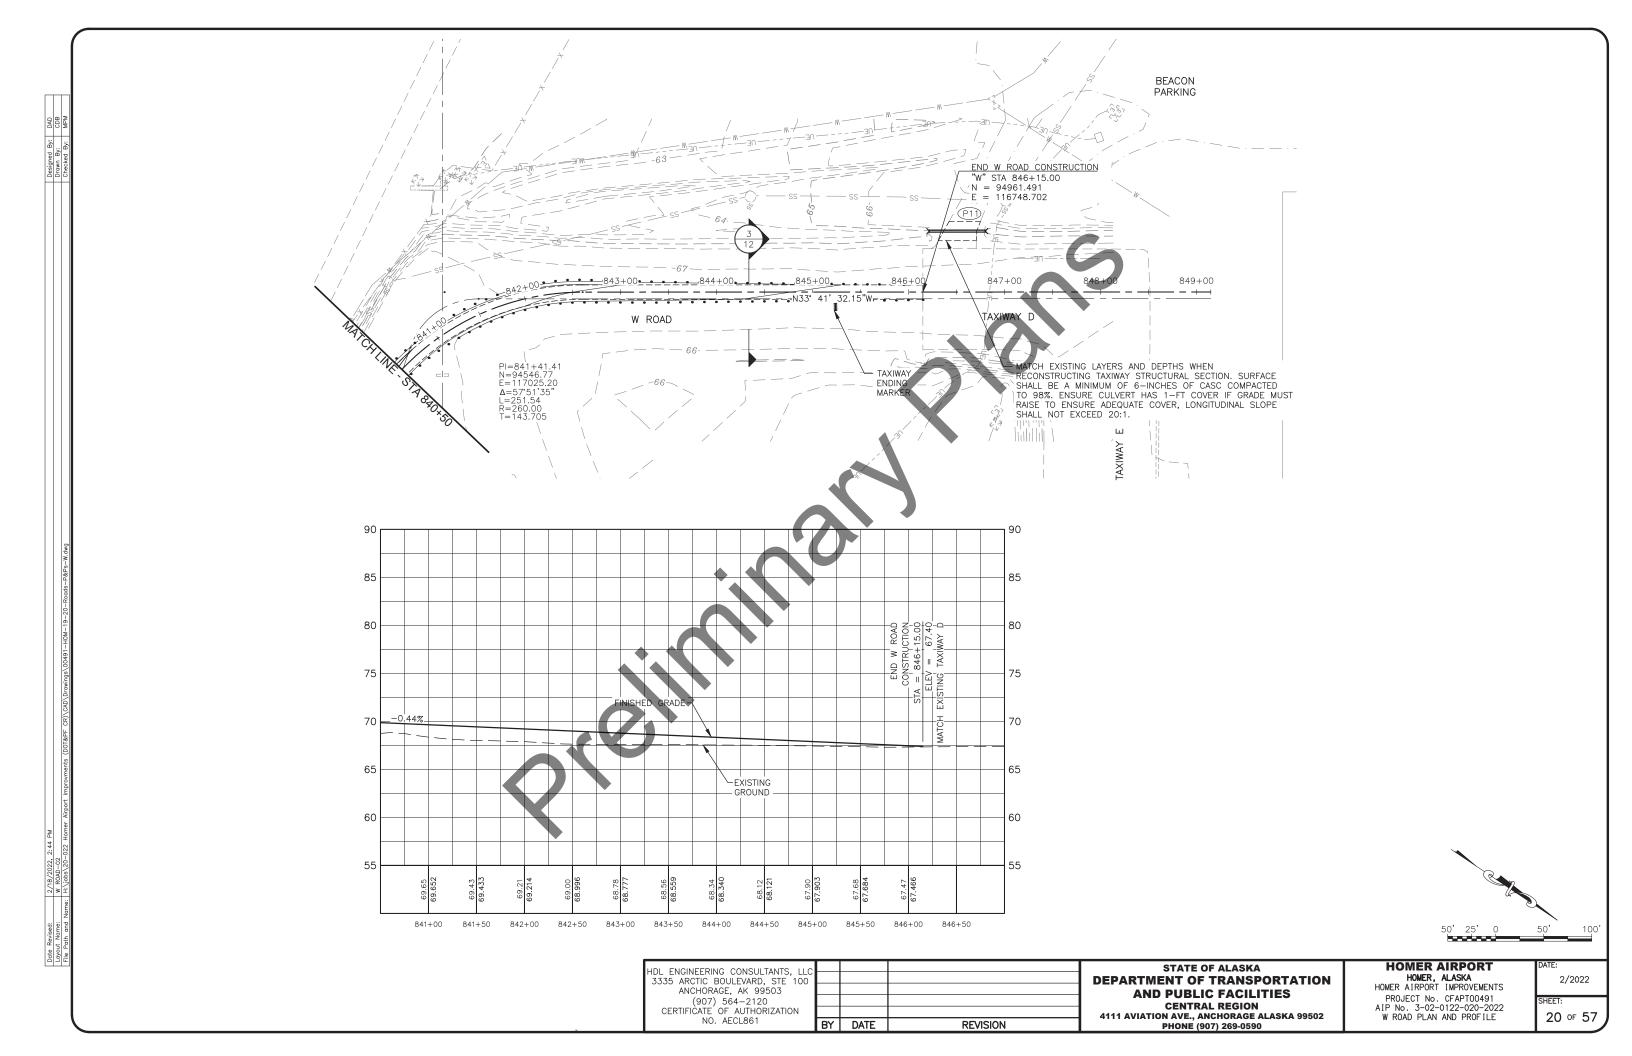


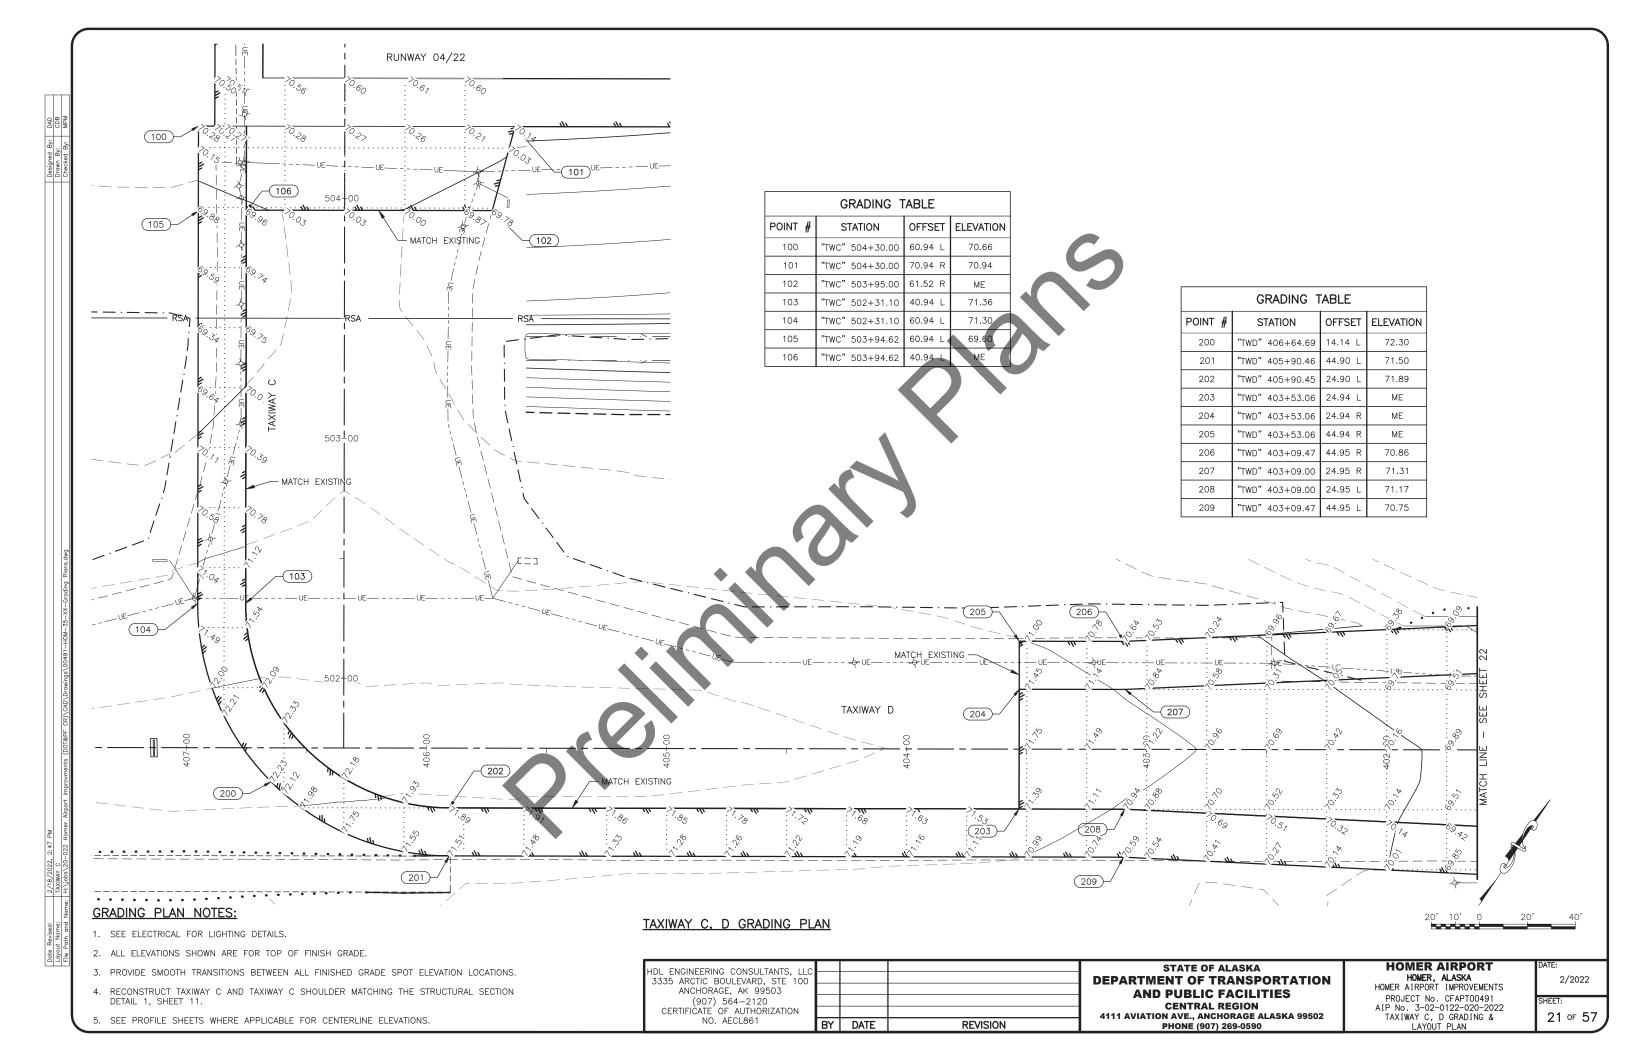


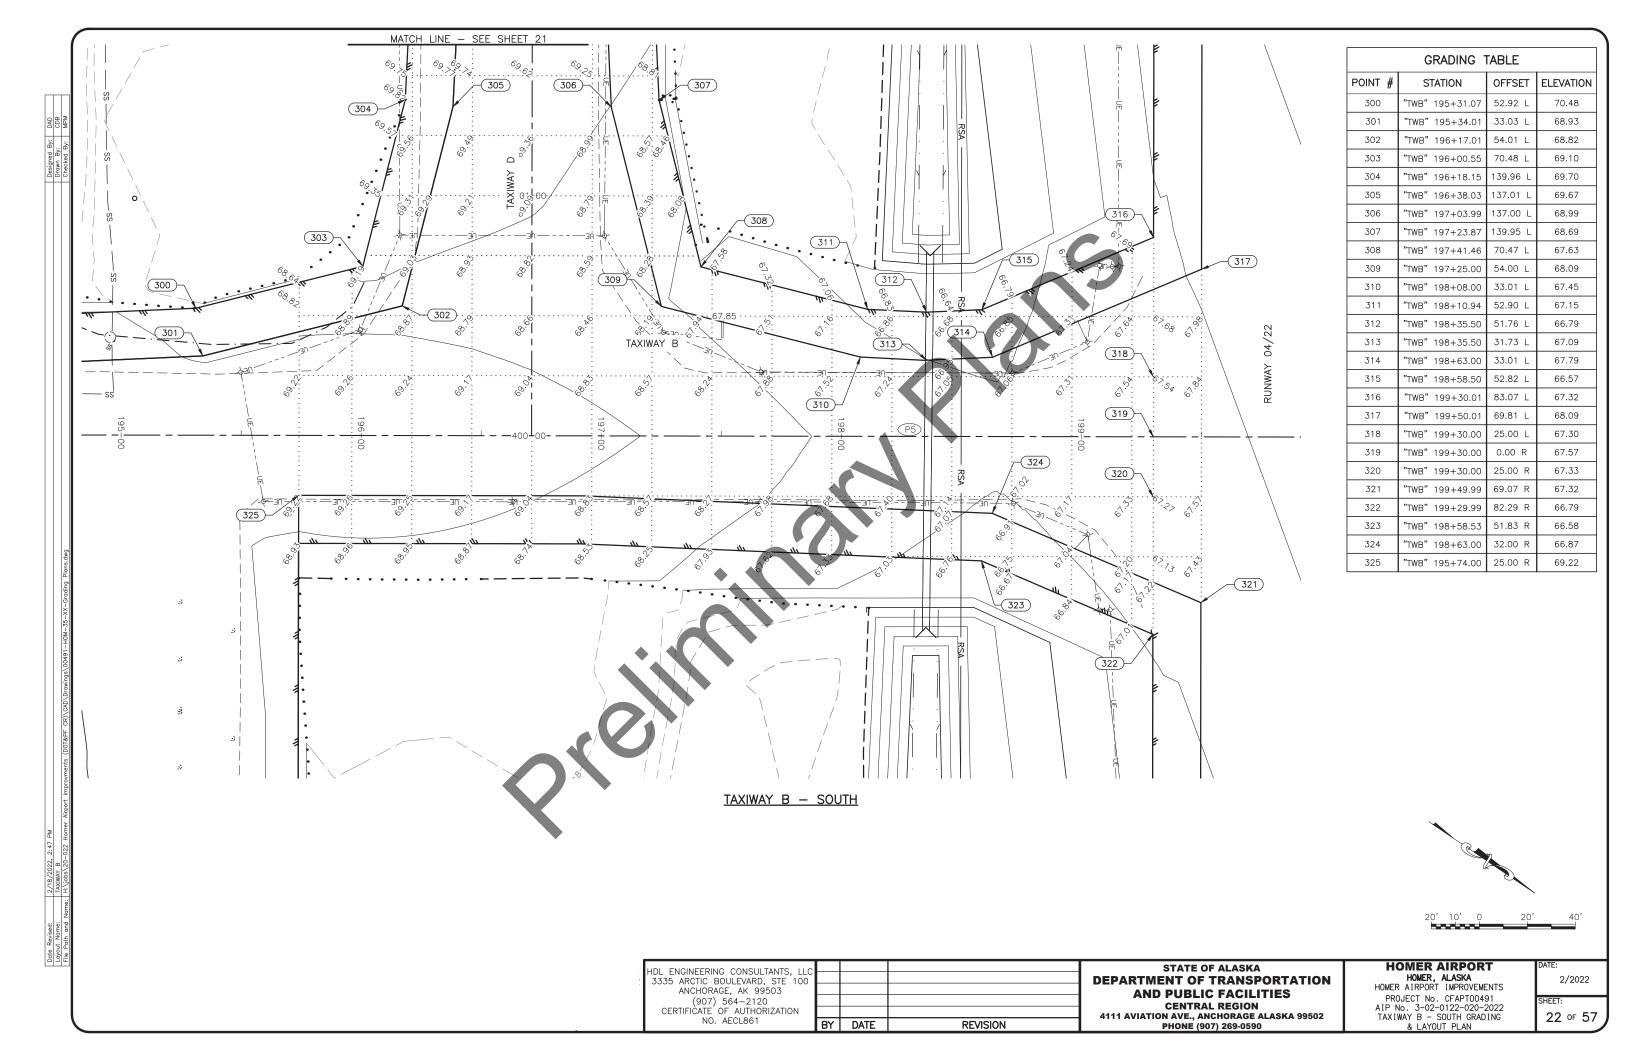


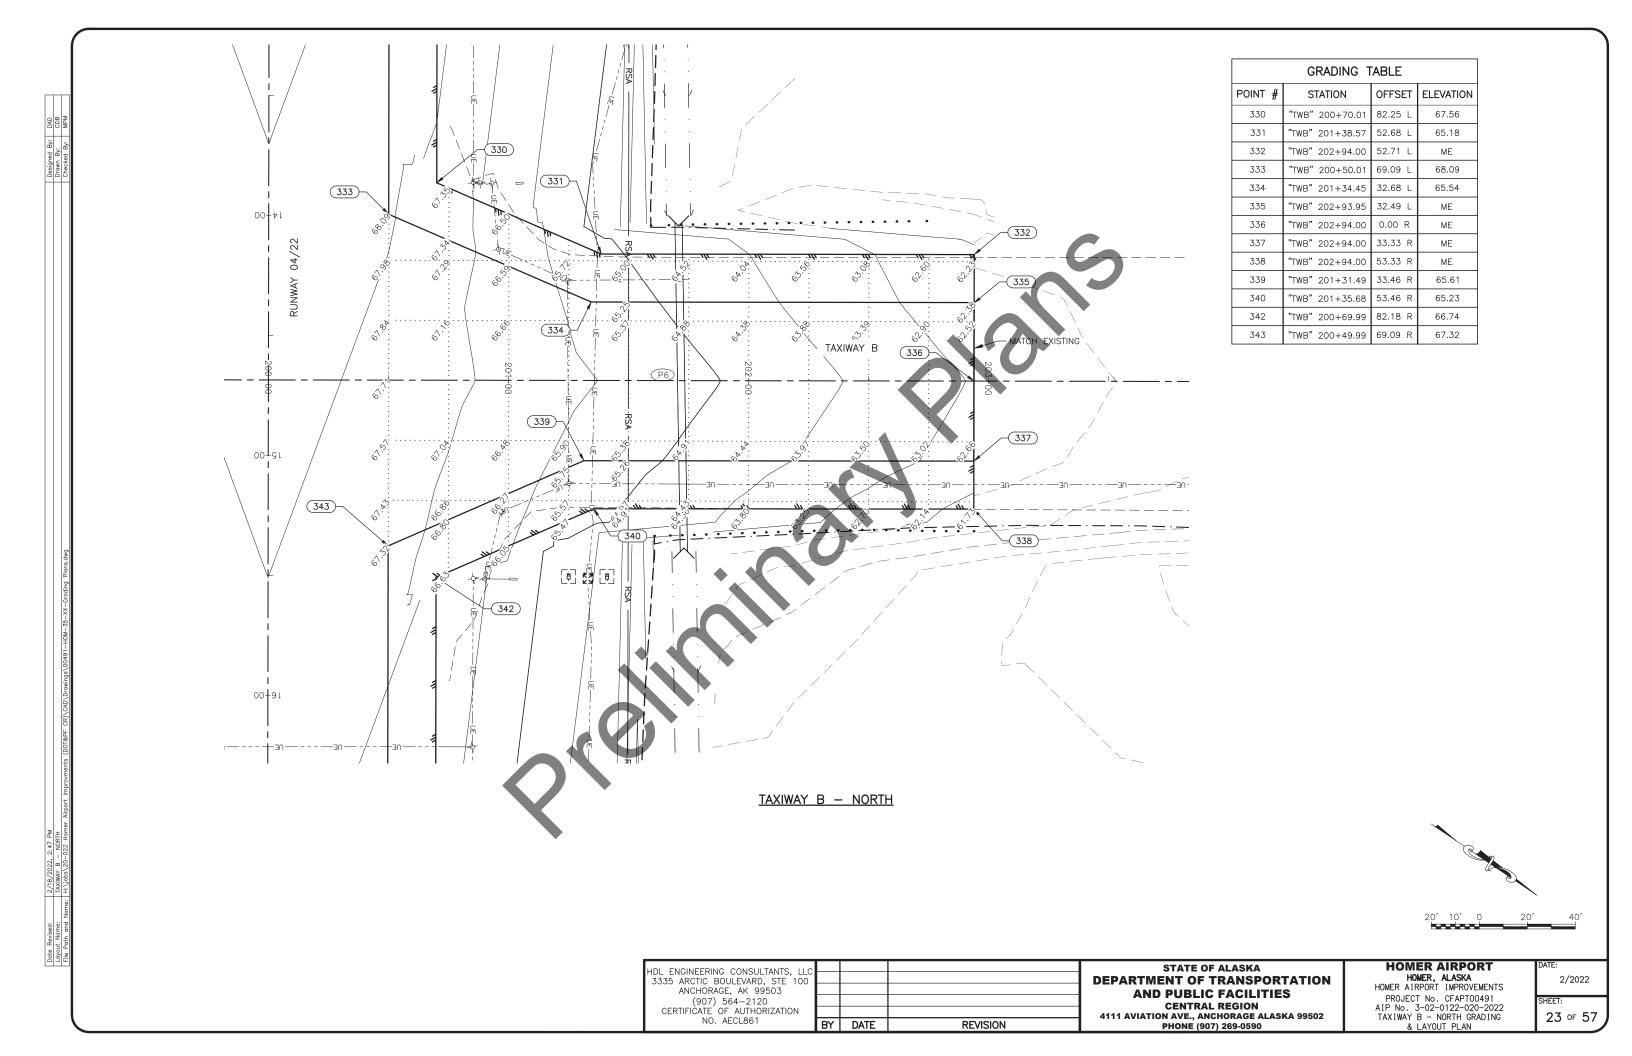


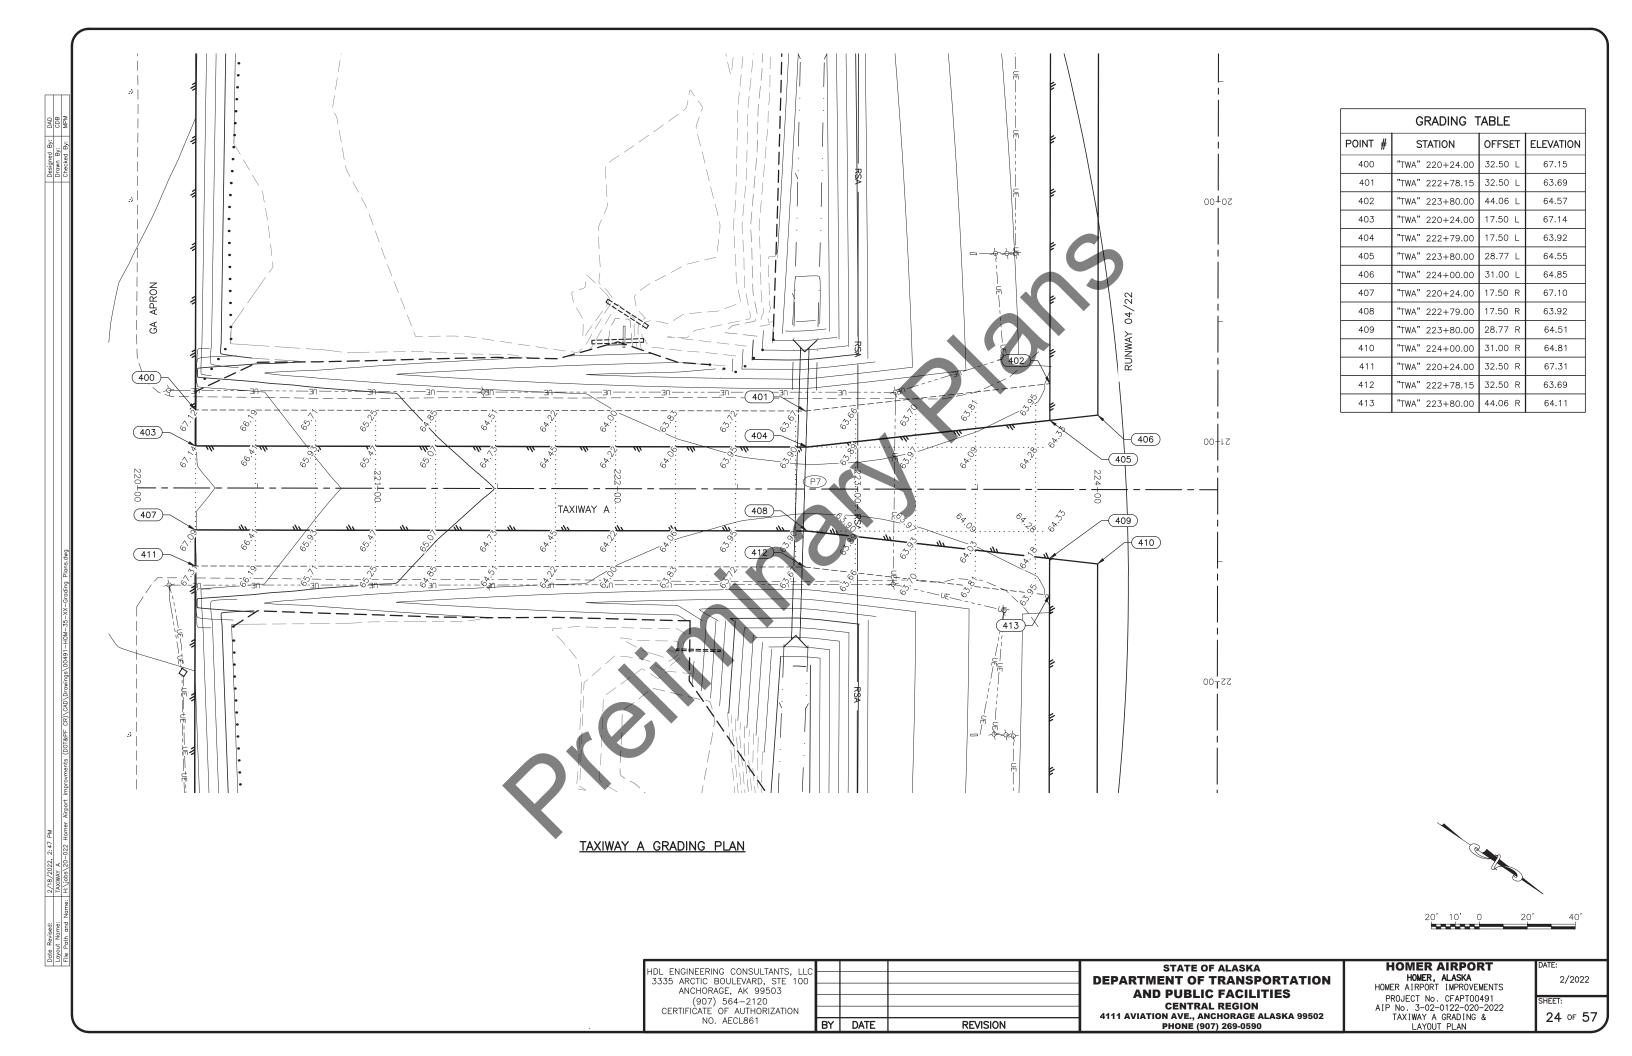


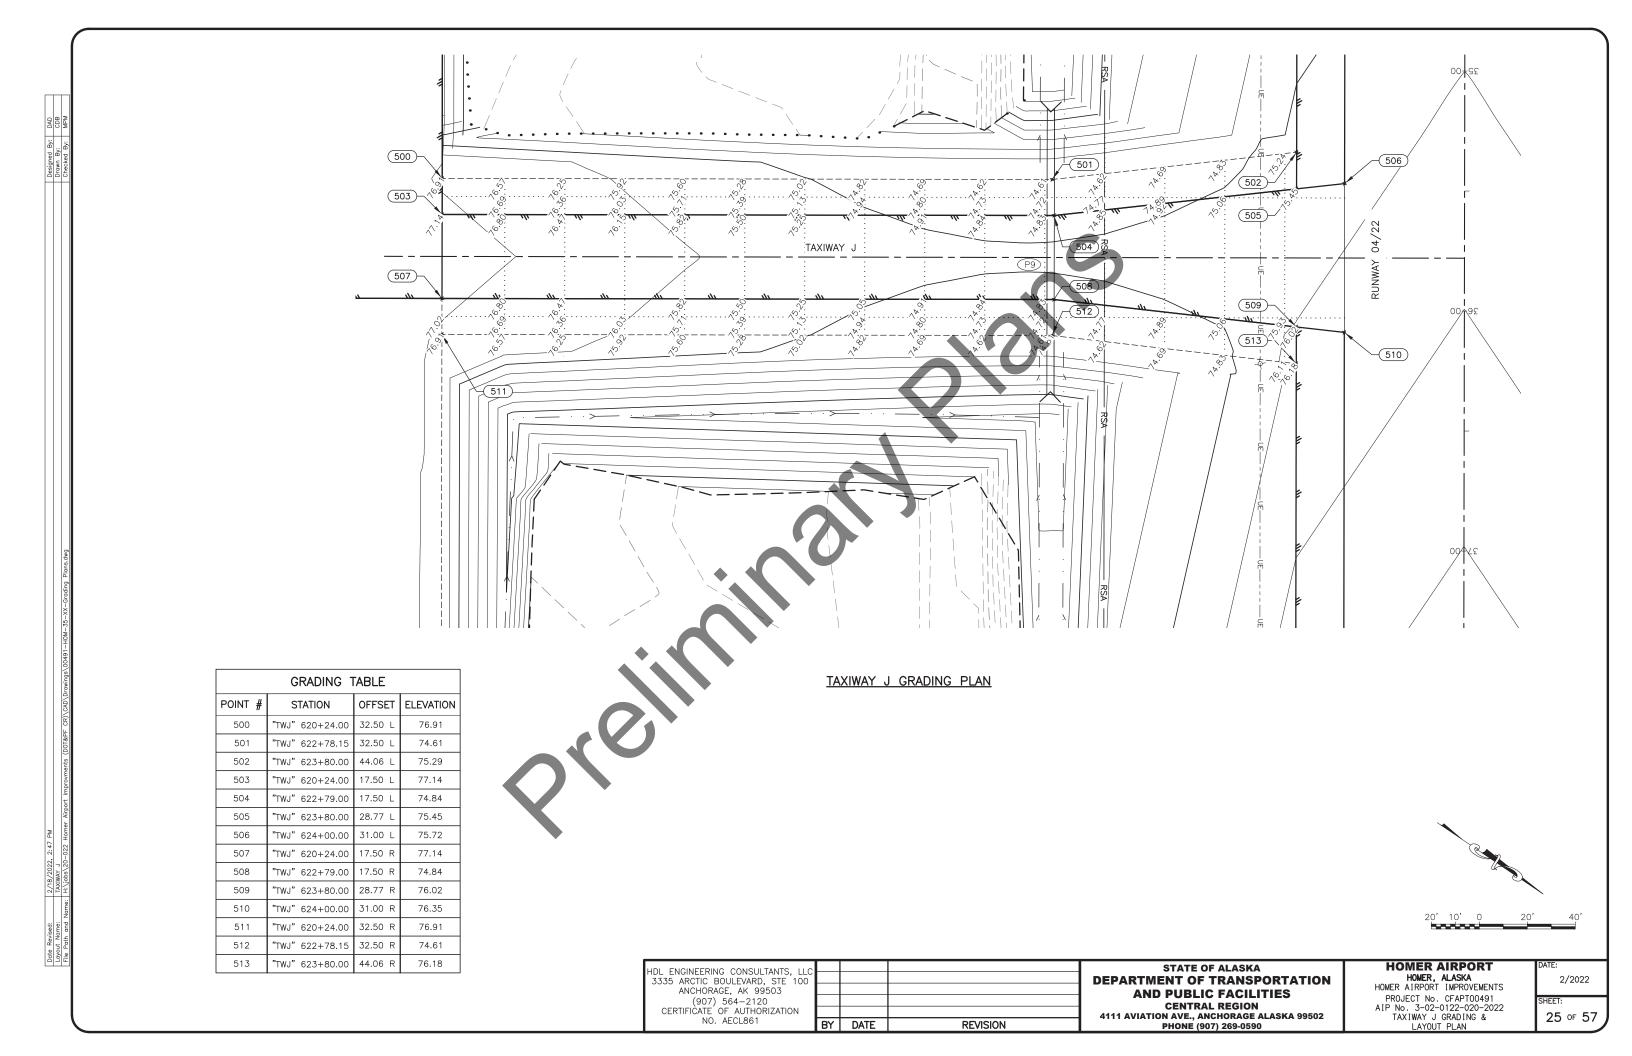


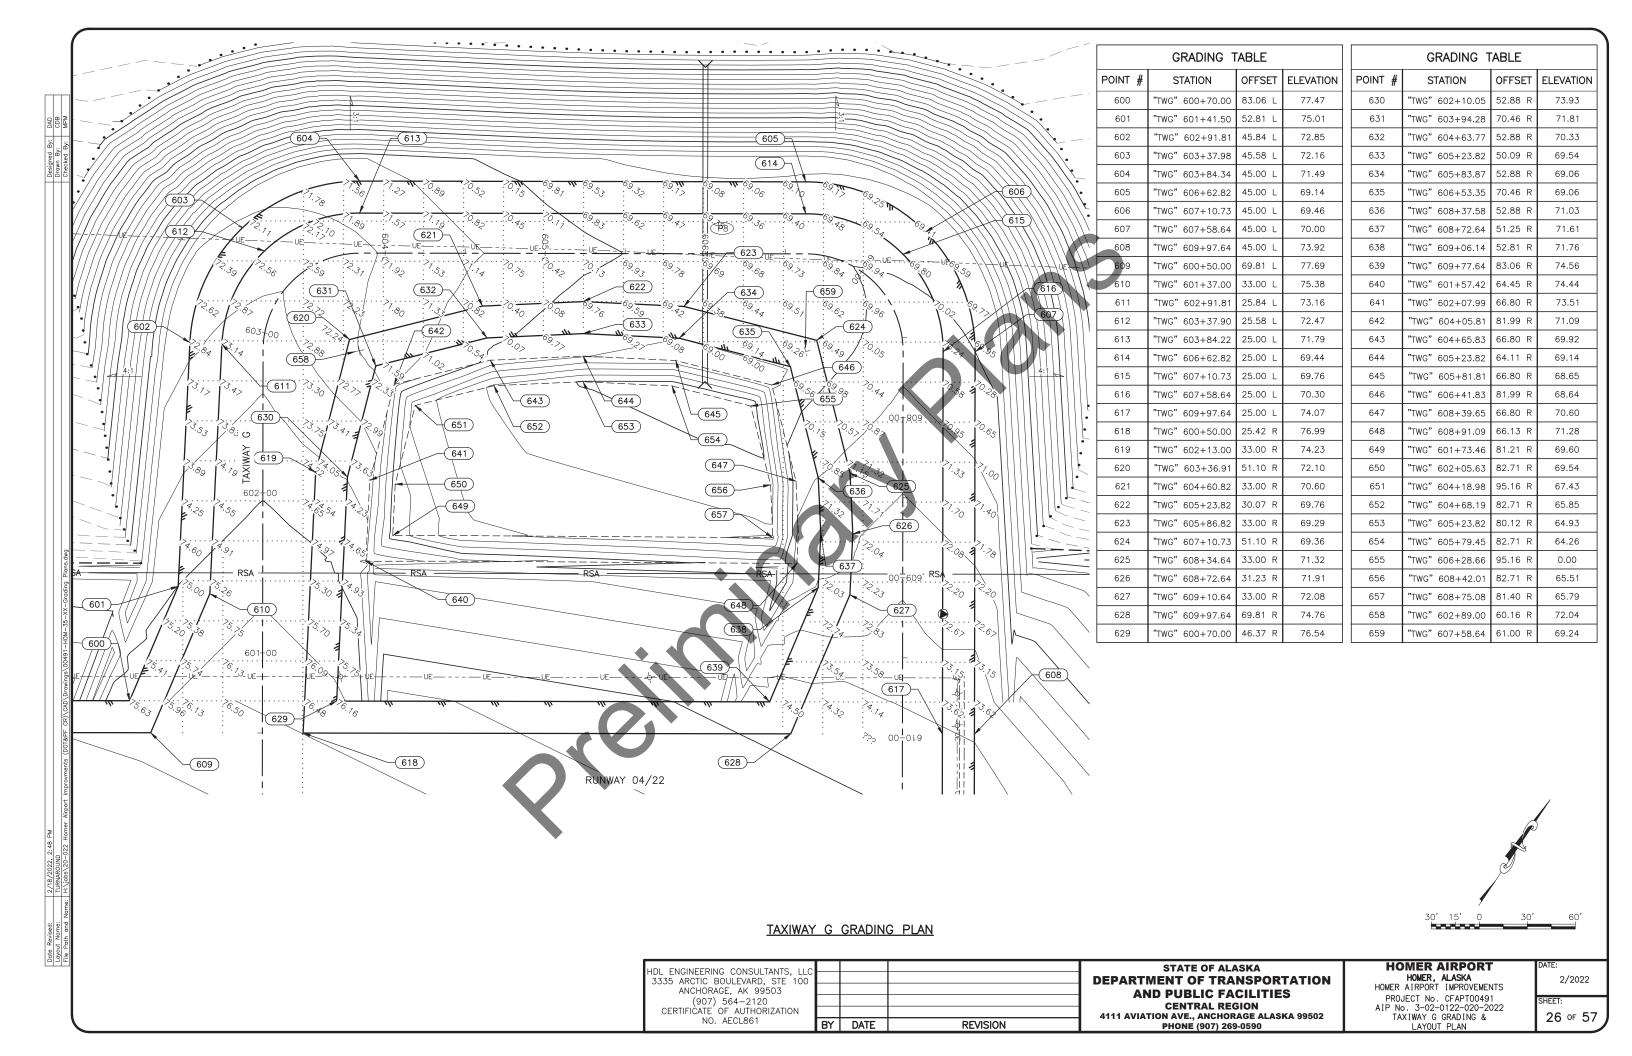


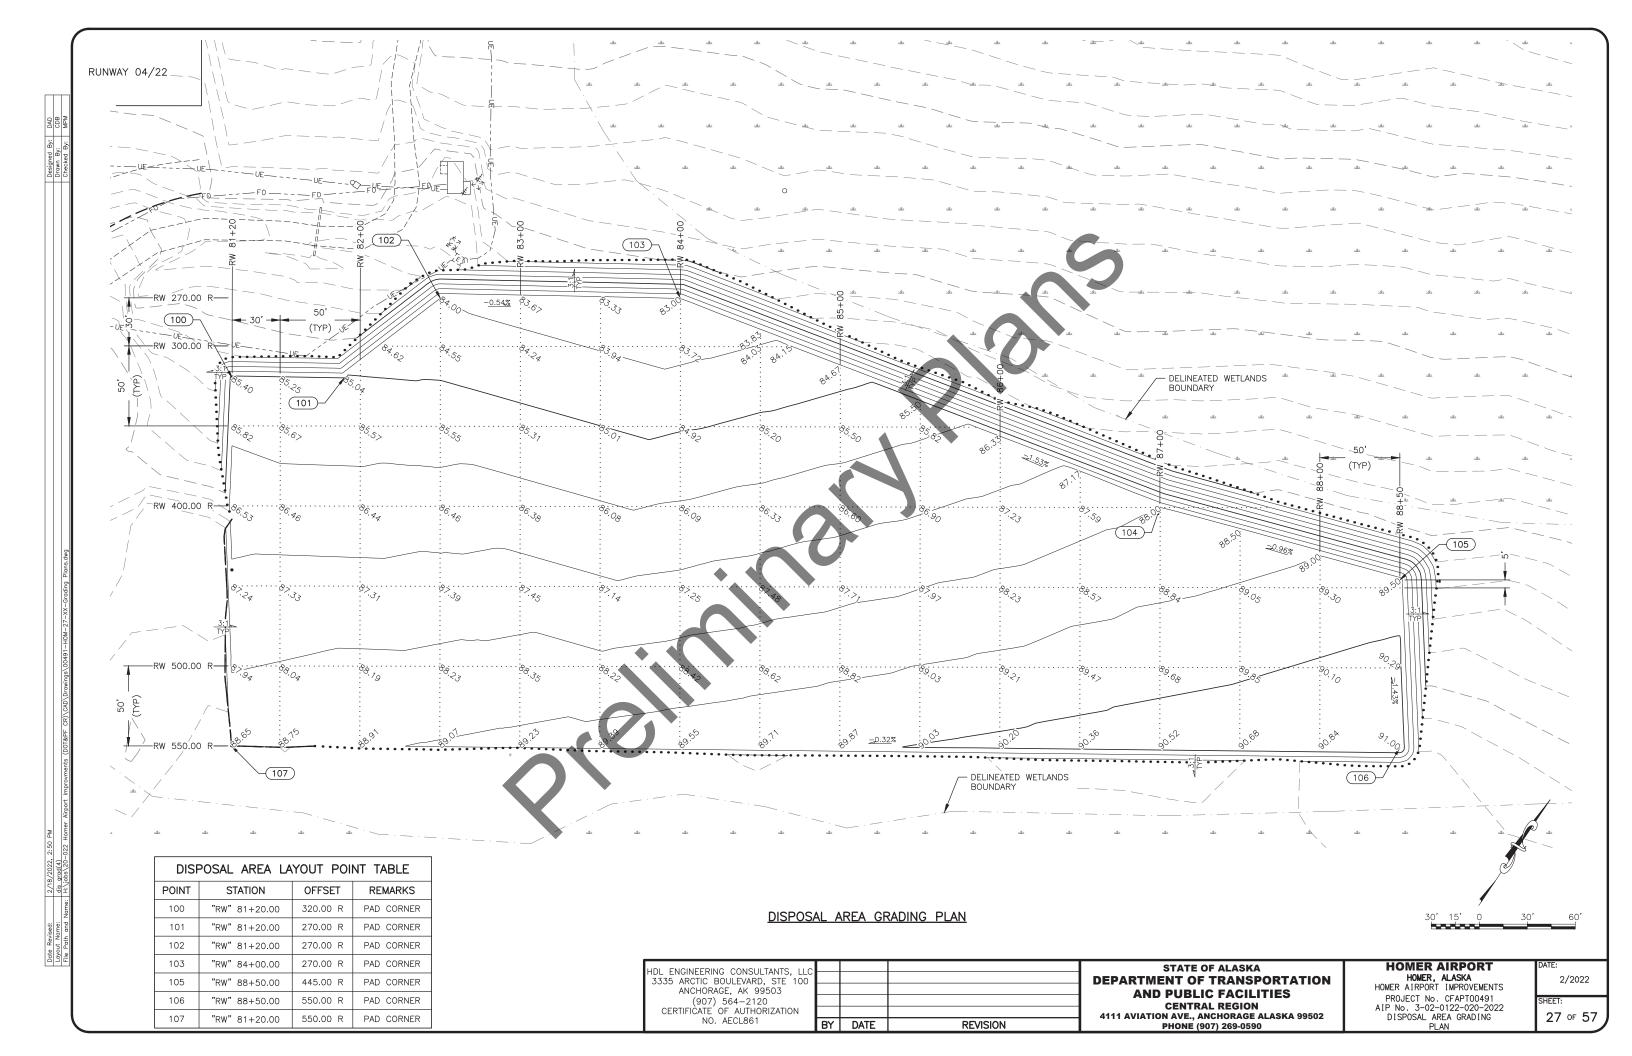


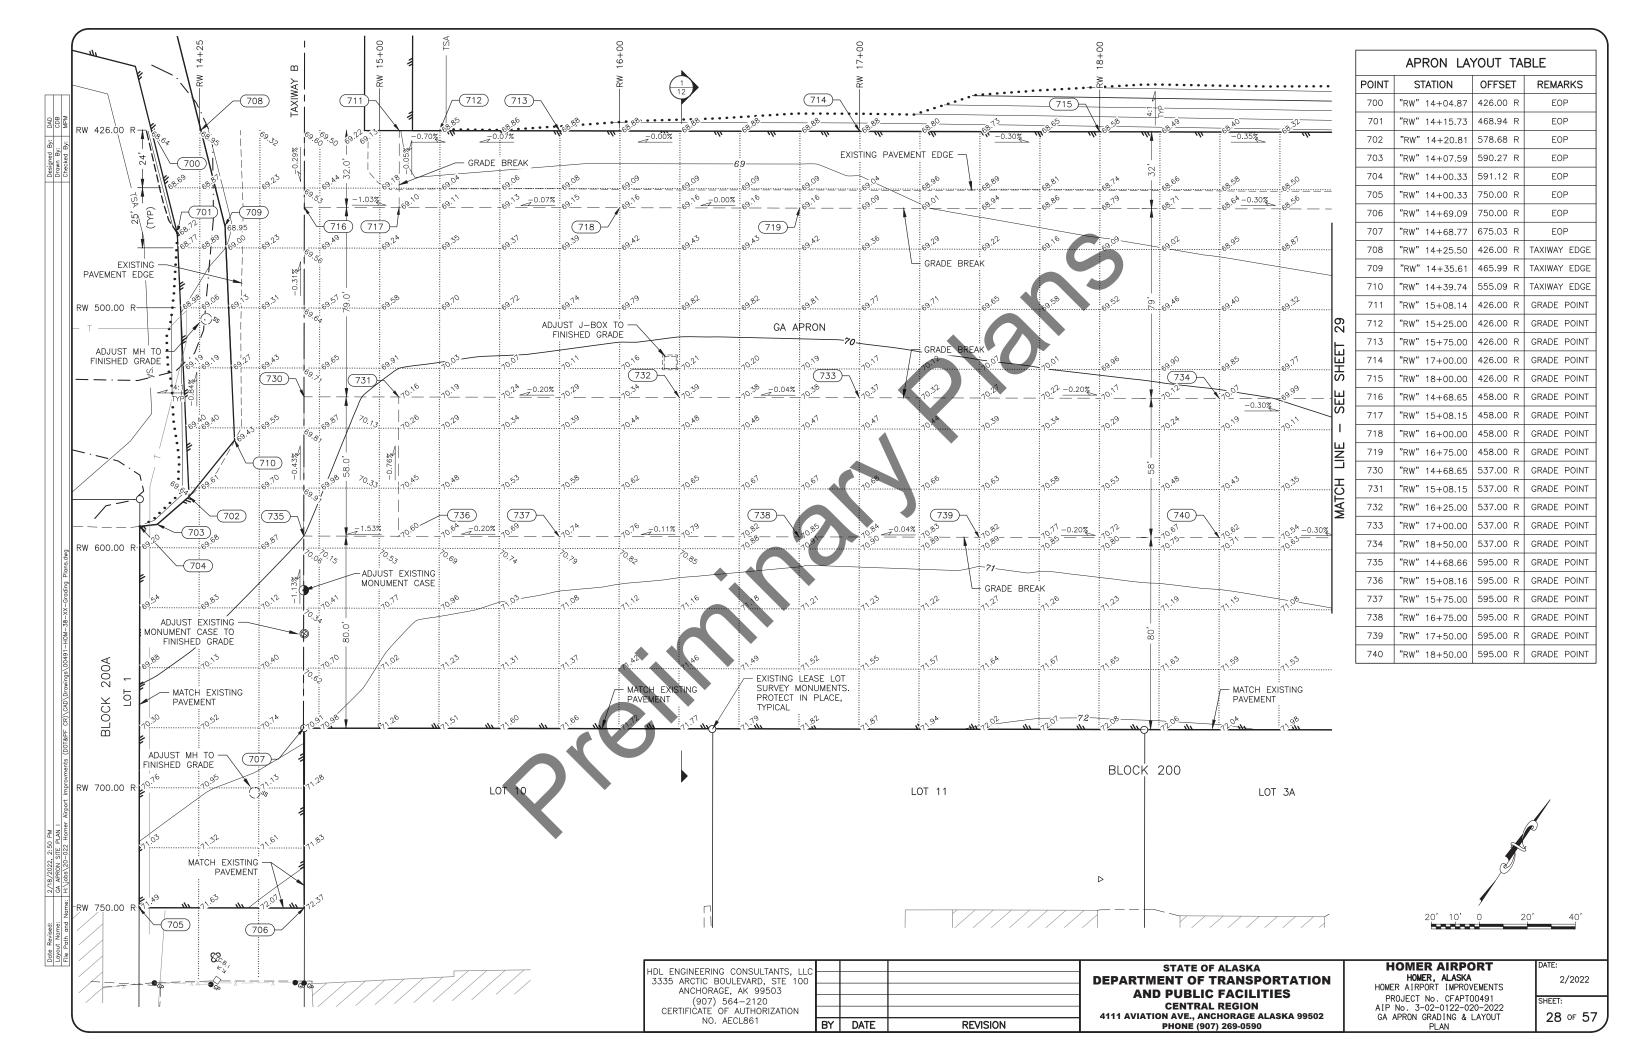

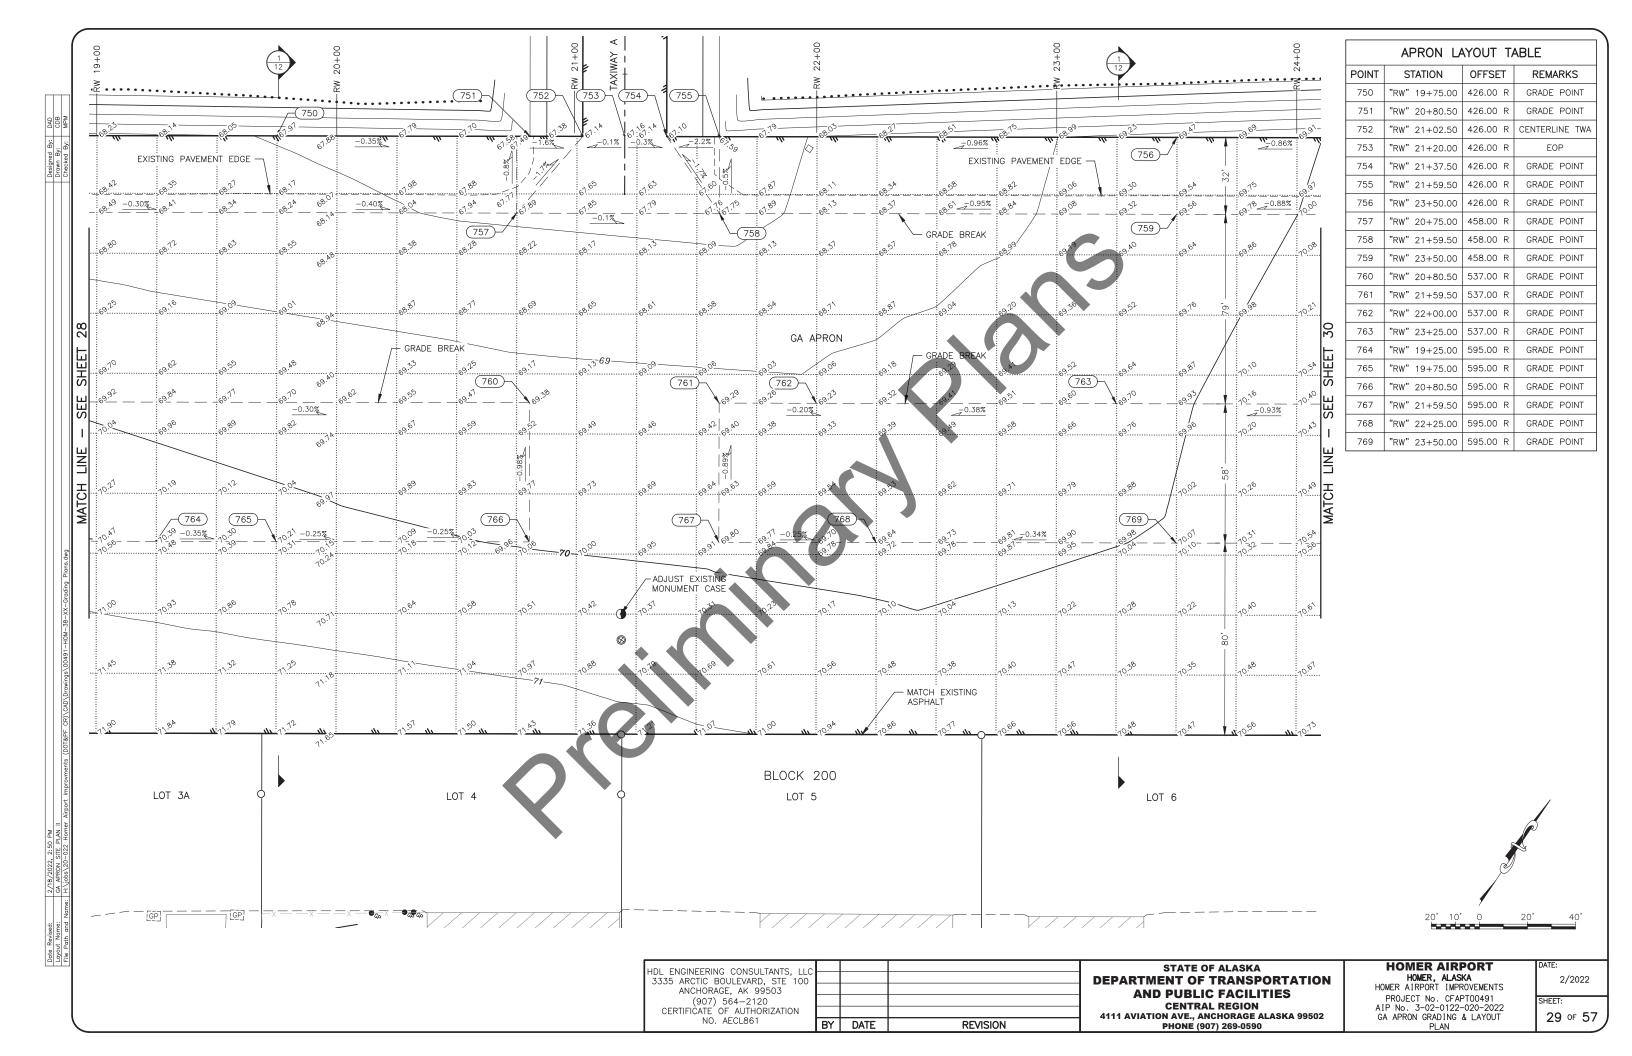


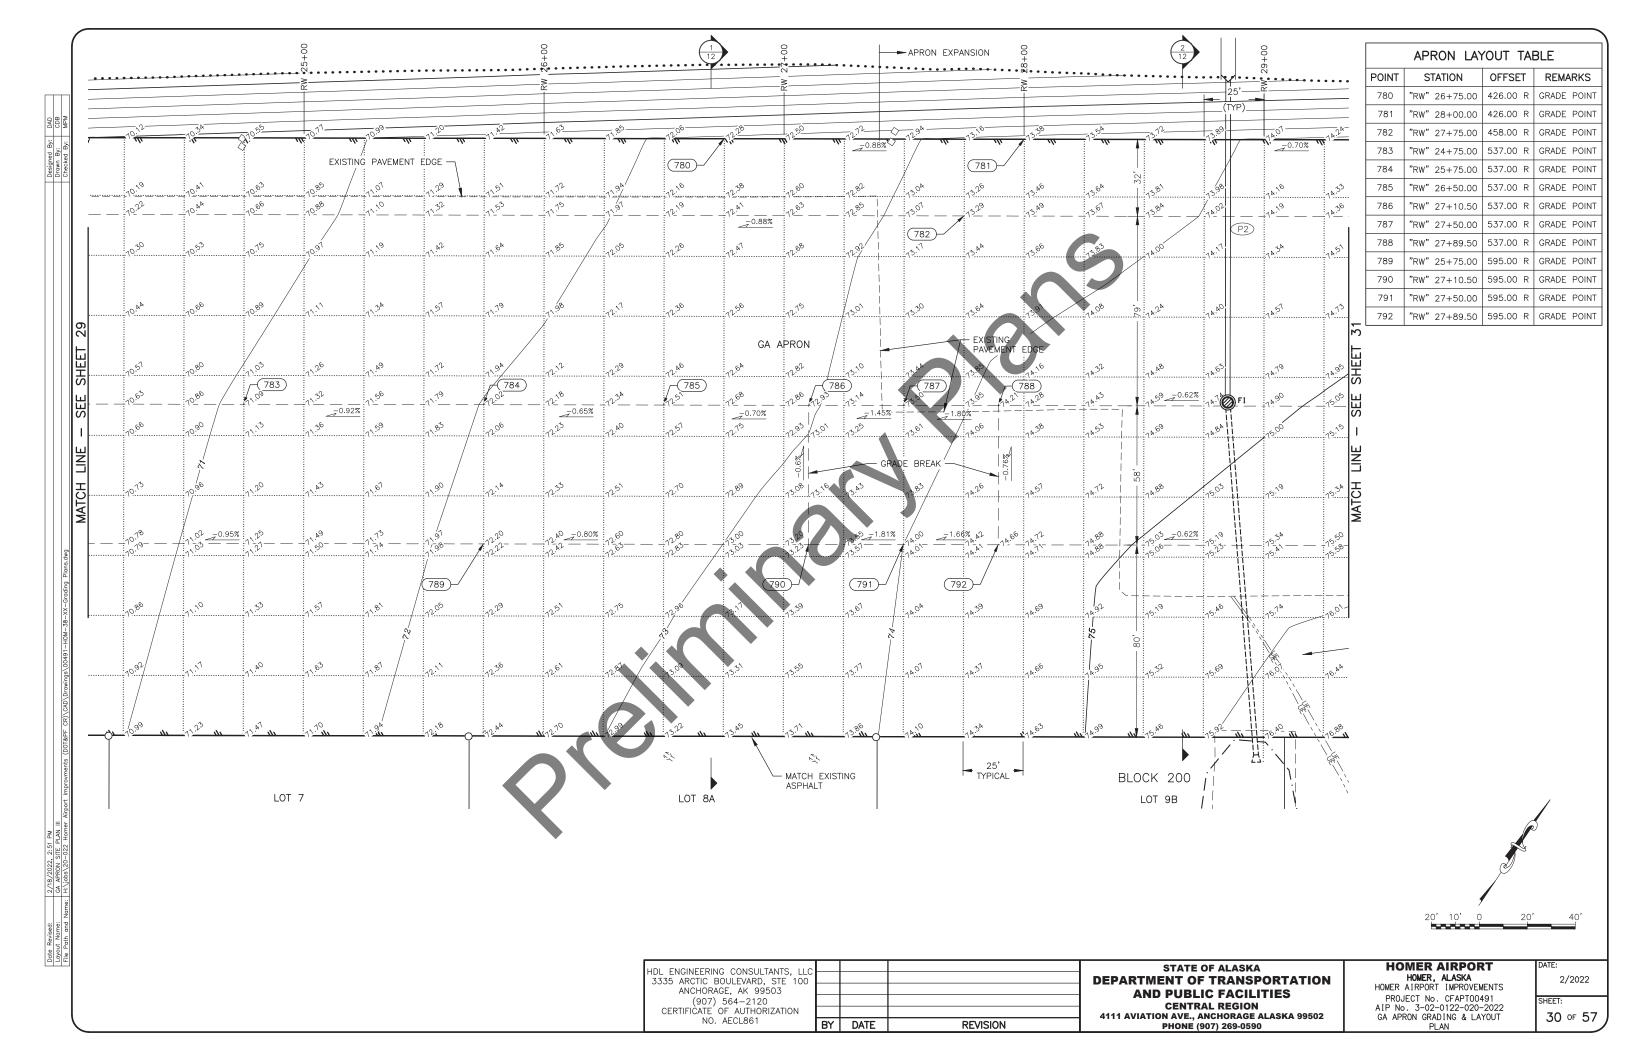

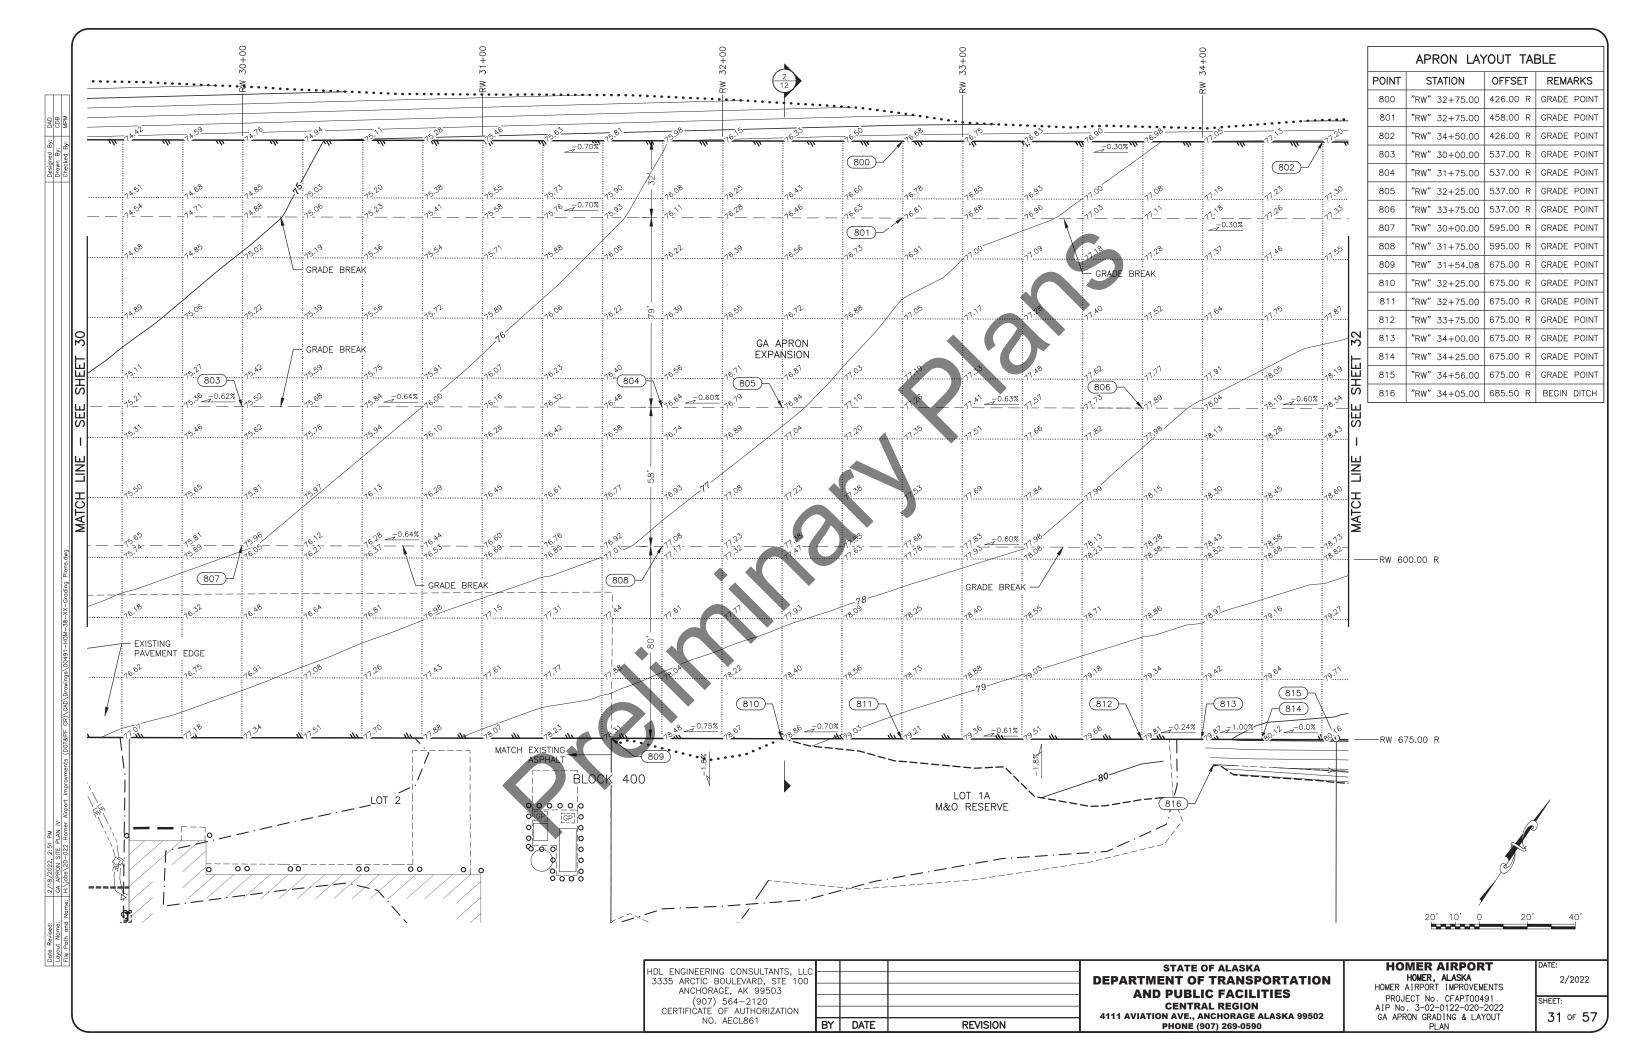

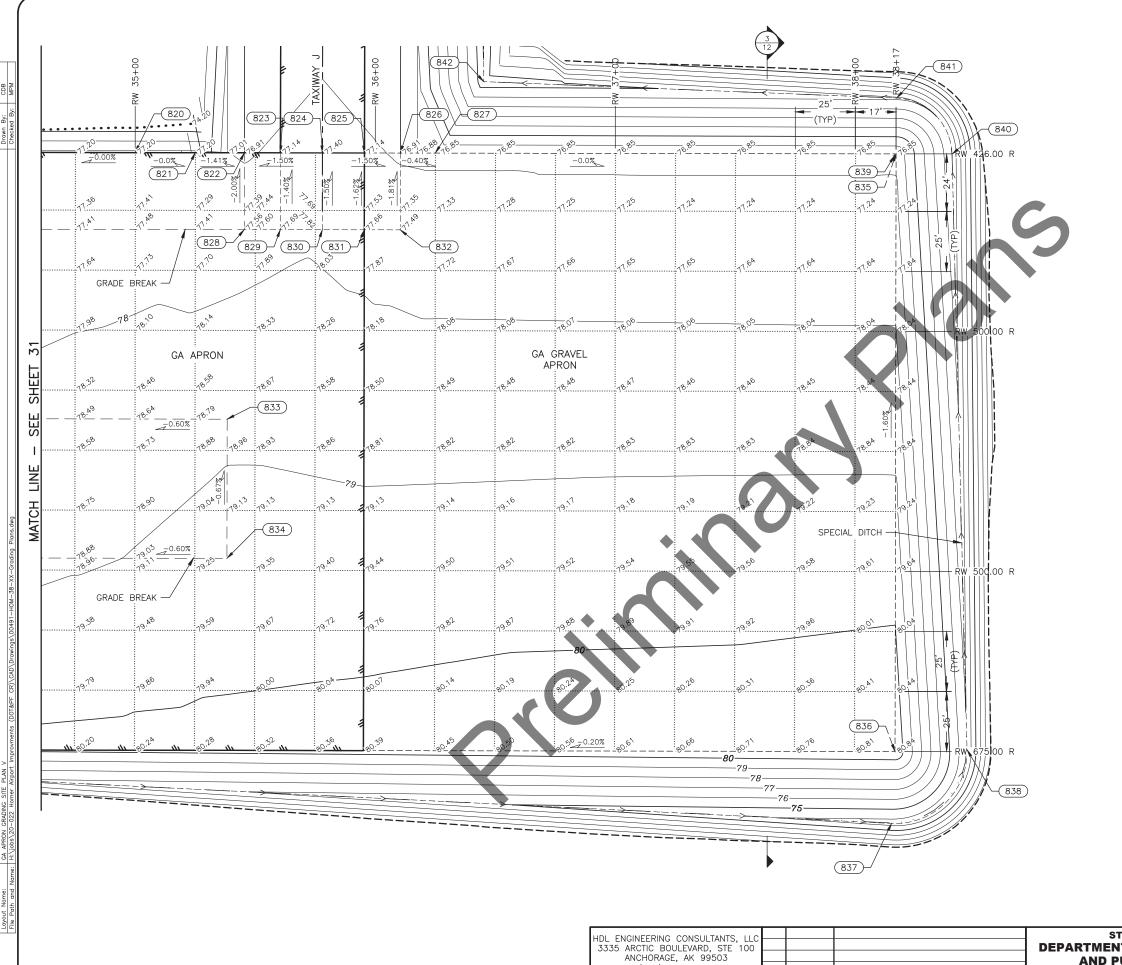

APRON LAYOUT TABLE									
POINT	STATION	OFFSET	REMARKS						
820	"RW" 35+00.00	426.00 R	BREAK POINT						
821	"RW" 35+25.00	426.00 R	BREAK POINT						
822	"RW" 35+45.50	426.00 R	BREAK POINT, TWJ SHOULDER						
823	"RW" 35+60.50	426.00 R	BREAK POINT, TWJ EOP						
824	"RW" 35+78.00	426.00 R	BREAK POINT, TWJ CENTER						
825	"RW" 35+95.50	426.00 R	BREAK POINT, TWJ EOP						
826	"RW" 36+10.50	426.00 R	BREAK POINT, TWJ SHOULDER						
827	"RW" 36+25.00	426.00 R	BREAK POINT						
828	"RW" 35+45.50	458.00 R	BREAK POINT						
829	"RW" 35+60.50	458.00 R	BREAK POINT						
830	"RW" 35+78.00	458.00 R	BREAK POINT1						
831	"RW" 35+95.50	458.00 R	BREAK POINT						
832	"RW" 36+10.50	458.00 R	BREAK POINT						
833	"RW" 35+38.50	537.00 R	BREAK POINT						
834	"RW" 35+38.50	595.00 R	BREAK POINT						
835	"RW" 38+17.00	426.00 R	APRON CORNER						
836	"RW" 38+17.00	675.00 R	APRON CORNER, DITCH RP, R=30'						
837	"RW" 38+15.58	704.97 R	DITCH PC						
838	"RW" 38+46.99	674.19 R	DITCH PT						
839	"RW" 38+16.32	426.70 R	DITCH RP, R=24'						
840	"RW" 38+40.32	426.08 R	DITCH PC						
841	"RW" 38+17.24	402.72 R	DITCH PT						
842	"RW" 36+45.14	396.18 R	DITCH ANGLE POINT						

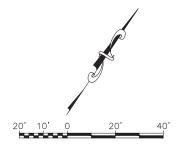


HDL ENGINEERING CONSULTANTS, LLC
3335 ARCTIC BOULEVARD, STE 100
ANCHORAGE, AK 99503
(907) 564-2120
CERTIFICATE OF AUTHORIZATION NO. AECL861 DATE REVISION

STATE OF ALASKA **DEPARTMENT OF TRANSPORTATION AND PUBLIC FACILITIES** CENTRAL REGION 4111 AVIATION AVE., ANCHORAGE ALASKA 99502 PHONE (907) 269-0590


HOMER AIRPORT
HOMER, ALASKA
HOMER AIRPORT IMPROVEMENTS PROJECT No. CFAPT00491 AIP No. 3-02-0122-020-2022 GA APRON GRADING & LAYOUT PLAN

2/2022 SHEET:


32 of 57

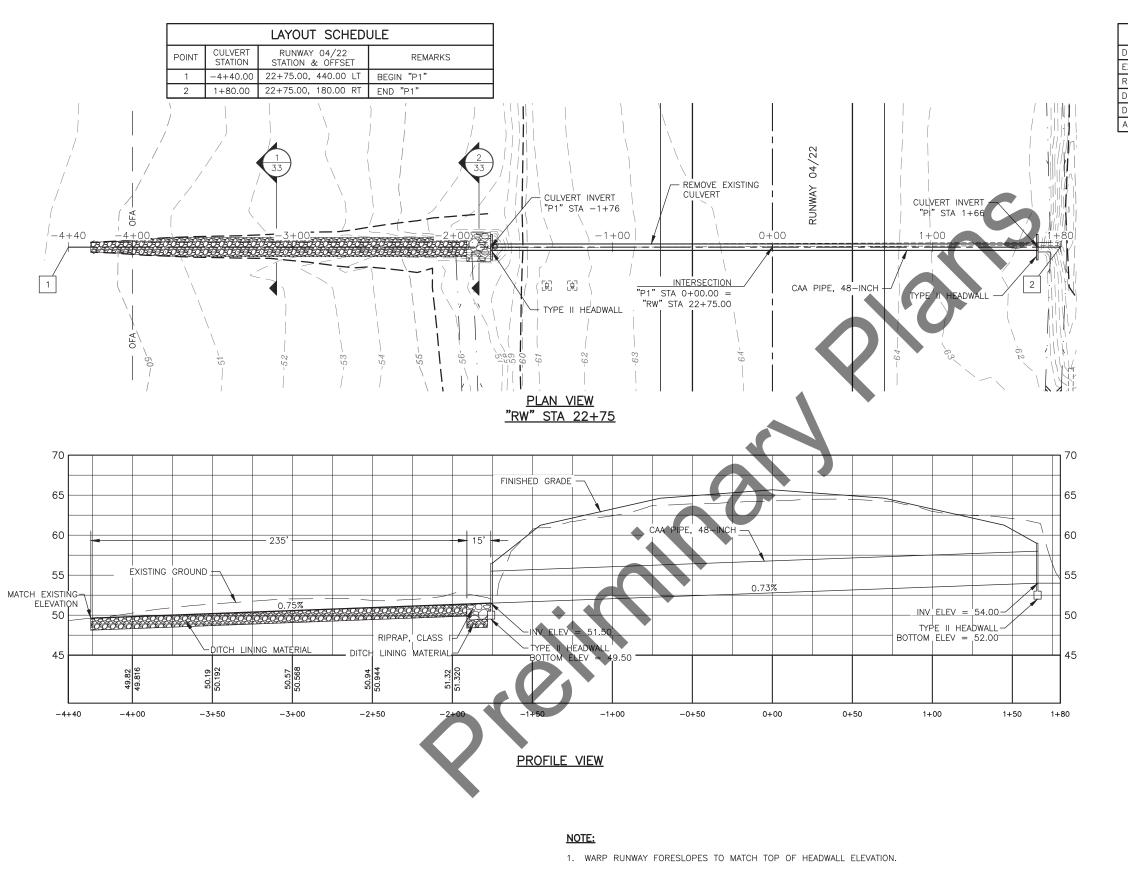


HYDRAULIC AND H	YDROLOGIC SUMM	ARY - P1
DRAINAGE AREA	0.39 SQUARE MILES	
EXCEEDANCE PROBABILITY	2% (DESIGN)	1%
RETURN PERIOD	50 YEAR (Q ₅₀)	100 YEAR (Q ₁₀₀)
DESIGN DISCHARGE	32 CFS	45 CFS
DESIGN HIGH WATER ELEVATION	56.7 FEET	57.4 FEET
ANTICIPATED ADDITIONAL BACKWATER	AT $Q_{100} = 0.0$ FFFT	=

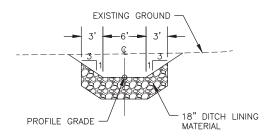



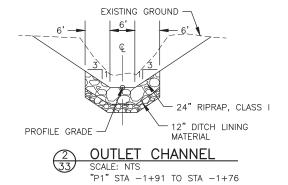

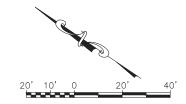

HDL ENGINEERING CONSULTANTS, LLC
3335 ARCTIC BOULEVARD, STE 100
ANCHORAGE, AK 99503
(907) 564-2120
CERTIFICATE OF AUTHORIZATION
NO. AECL861


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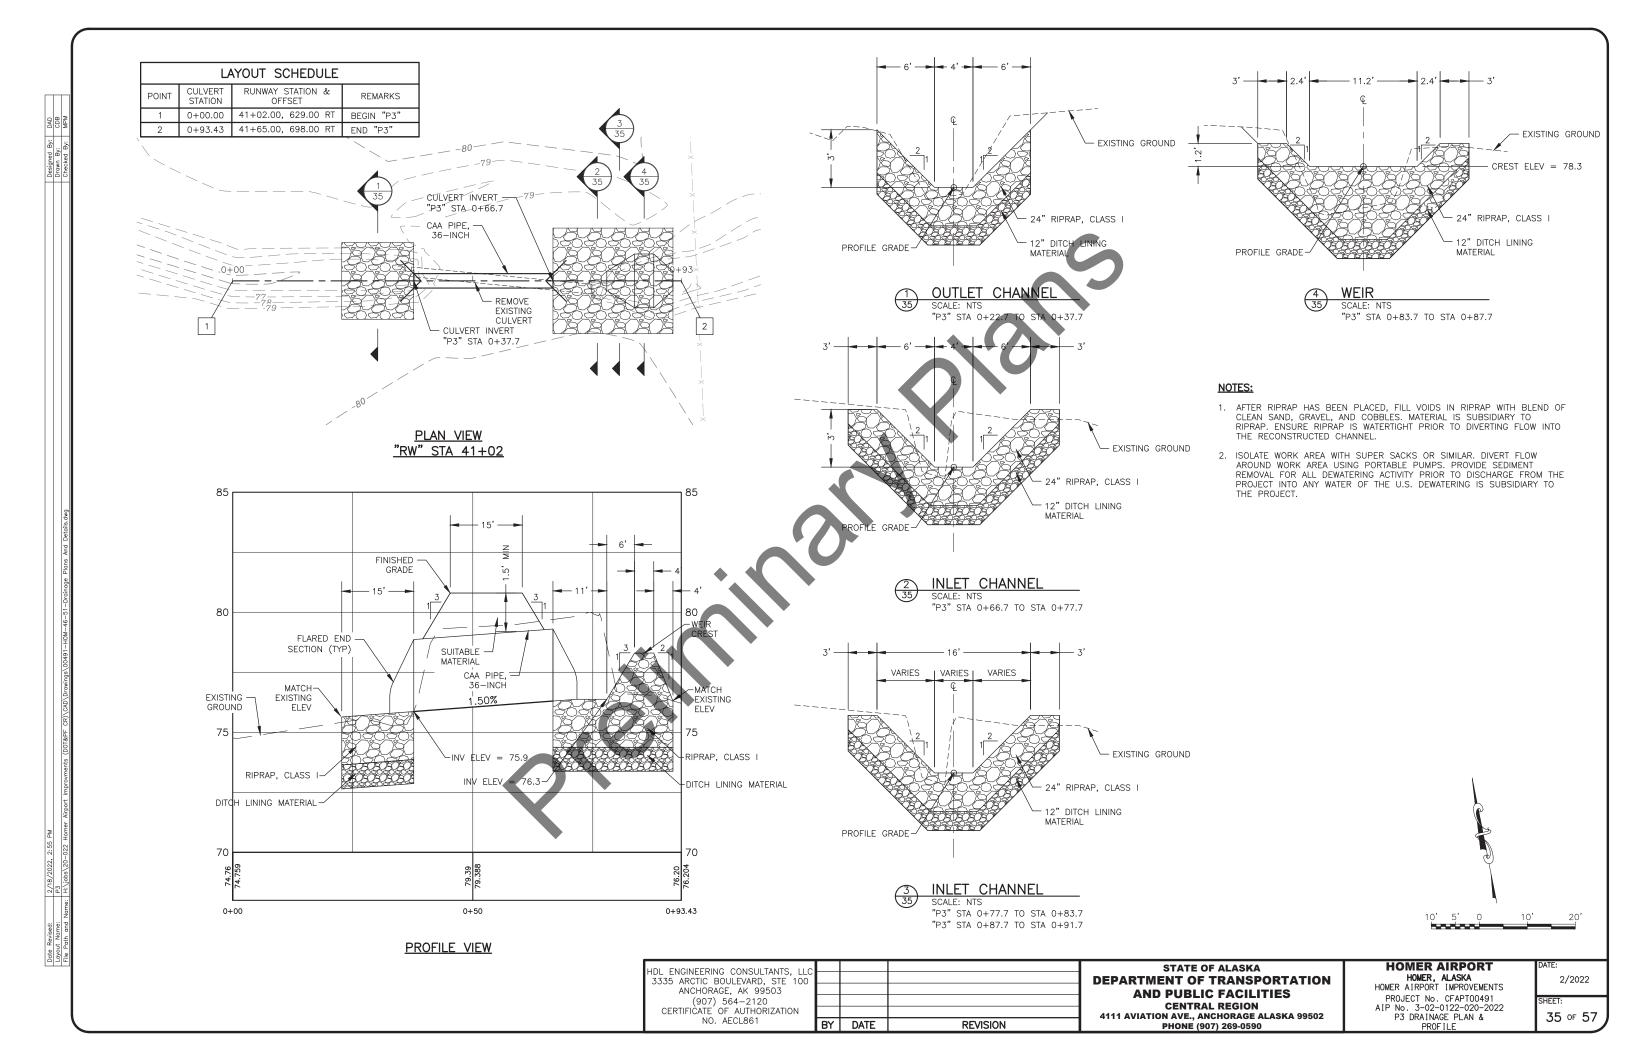
REVISION


STATE OF ALASKA
DEPARTMENT OF TRANSPORTATION
AND PUBLIC FACILITIES
CENTRAL REGION
4111 AVIATION AVE., ANCHORAGE ALASKA 99502
PHONE (907) 269-0590


HOMER AIRPORT
HOMER, ALASKA
HOMER AIRPORT IMPROVEMENTS
PROJECT No. CFAPTO0491
AIP No. 3-02-0122-020-2022
P1 DRAINAGE PLAN &
PROFILE


2/2022 SHEET: 33 OF 57




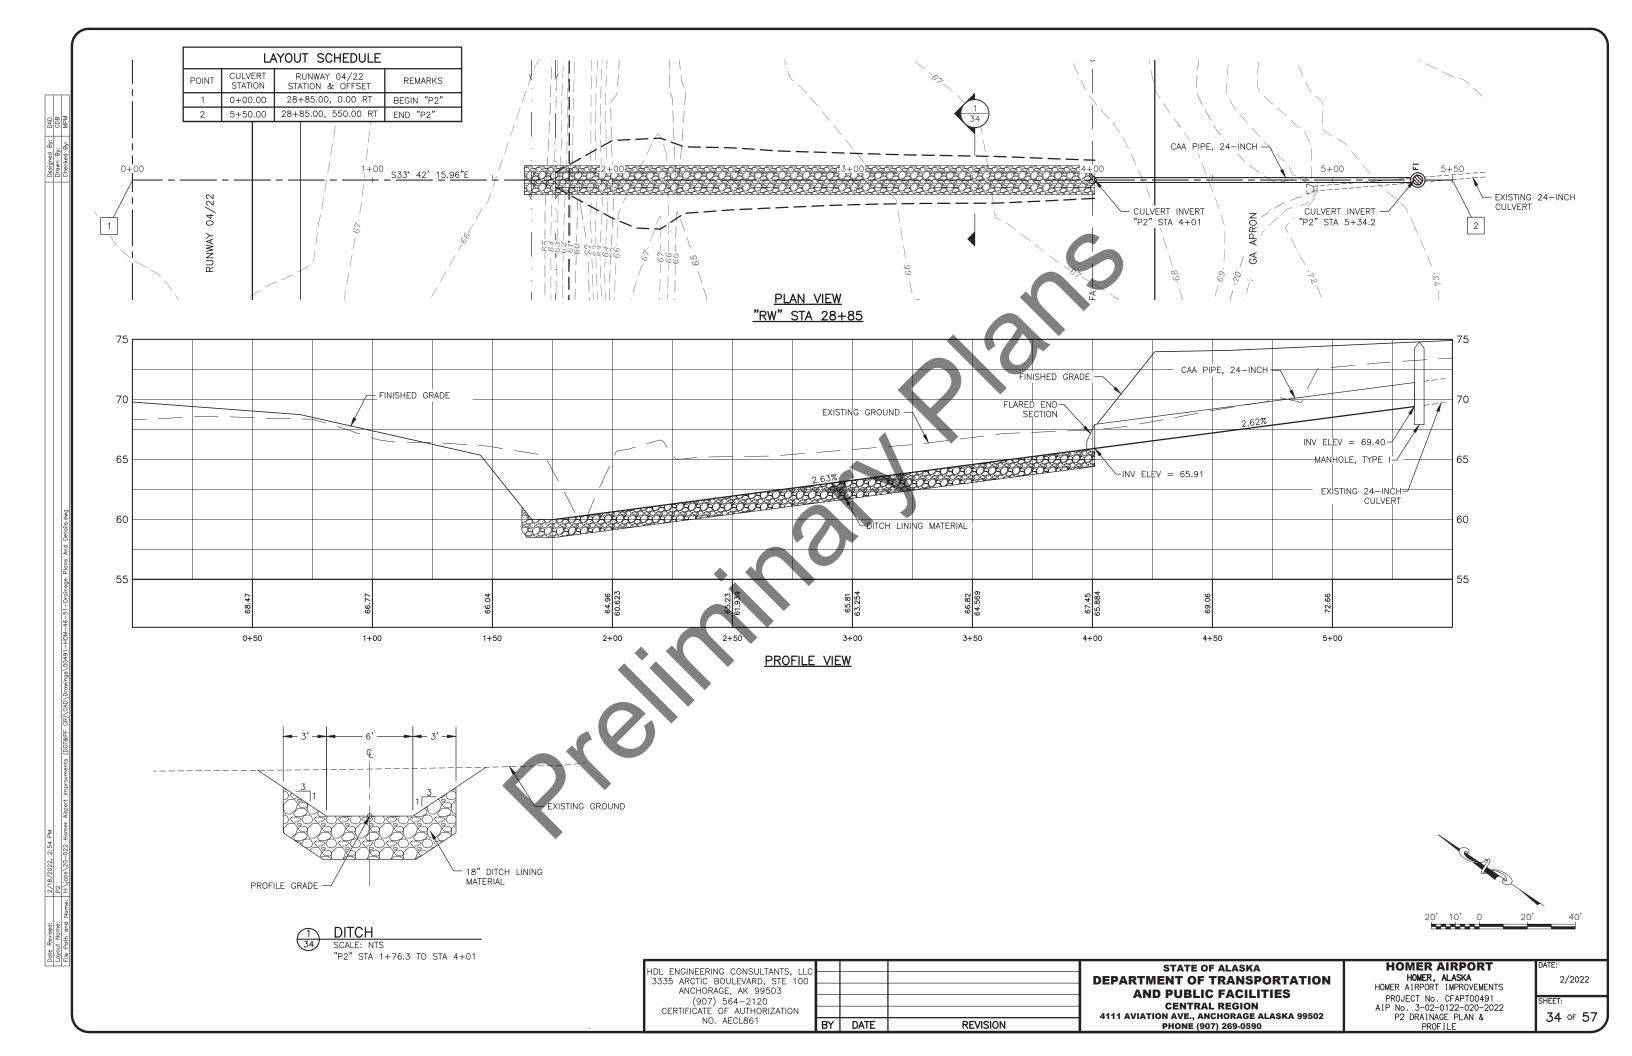

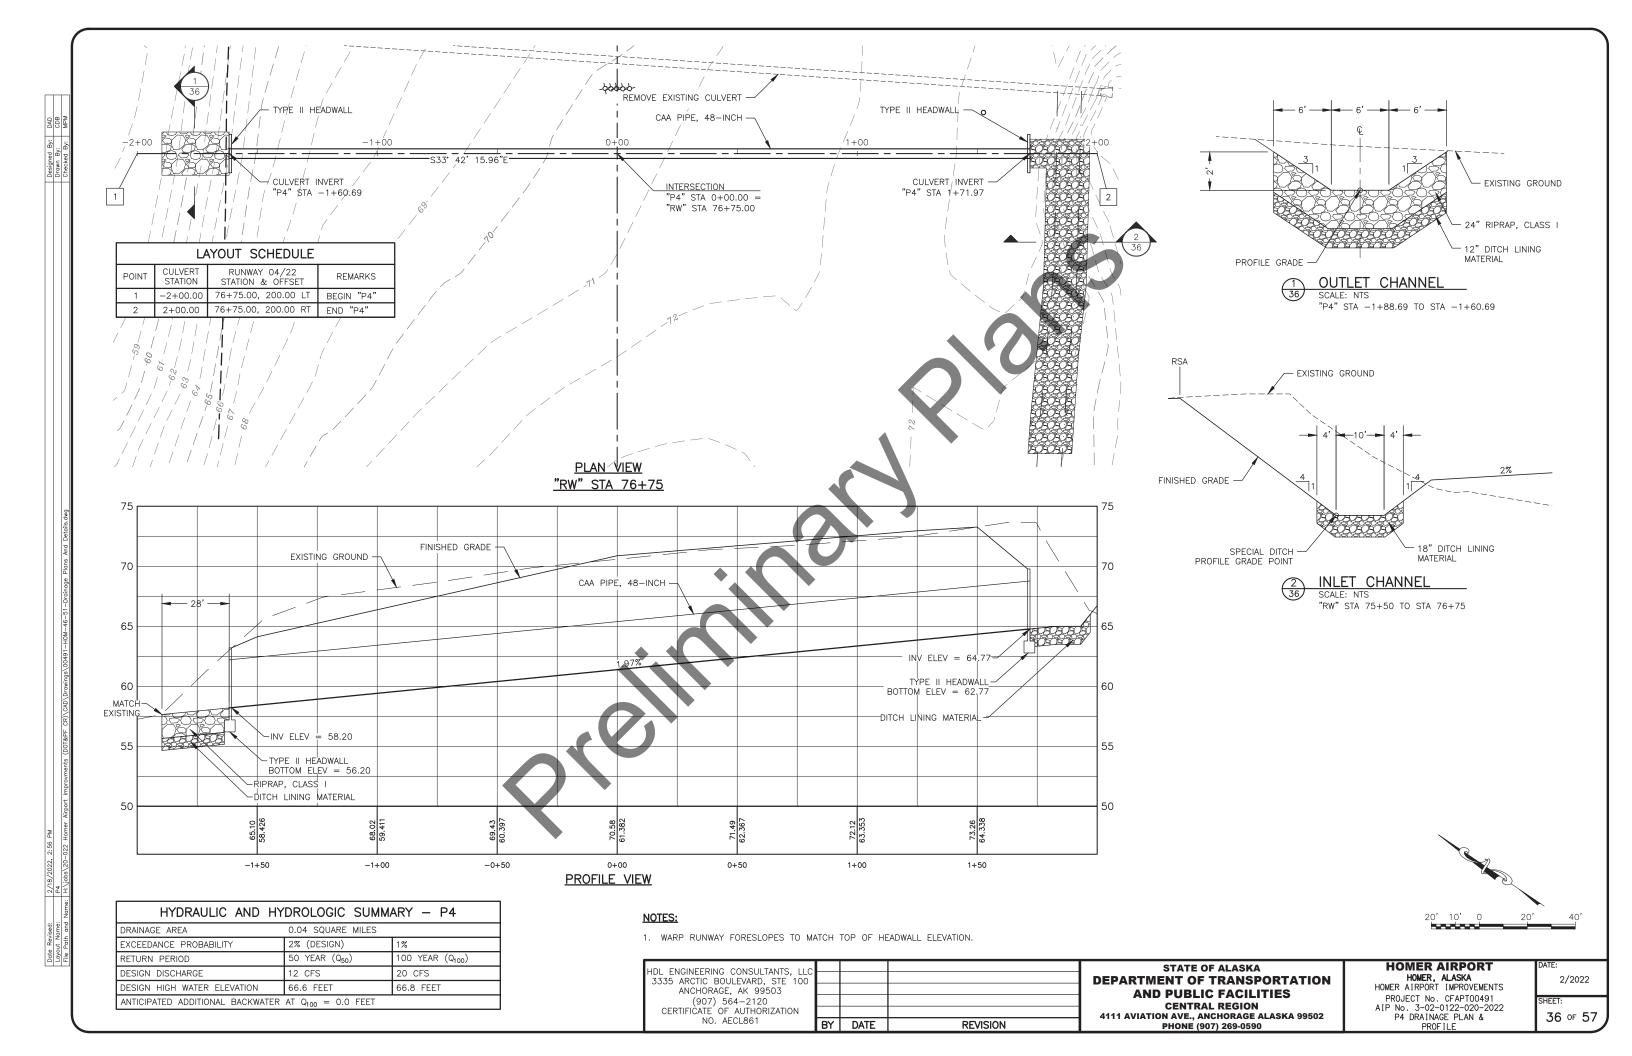

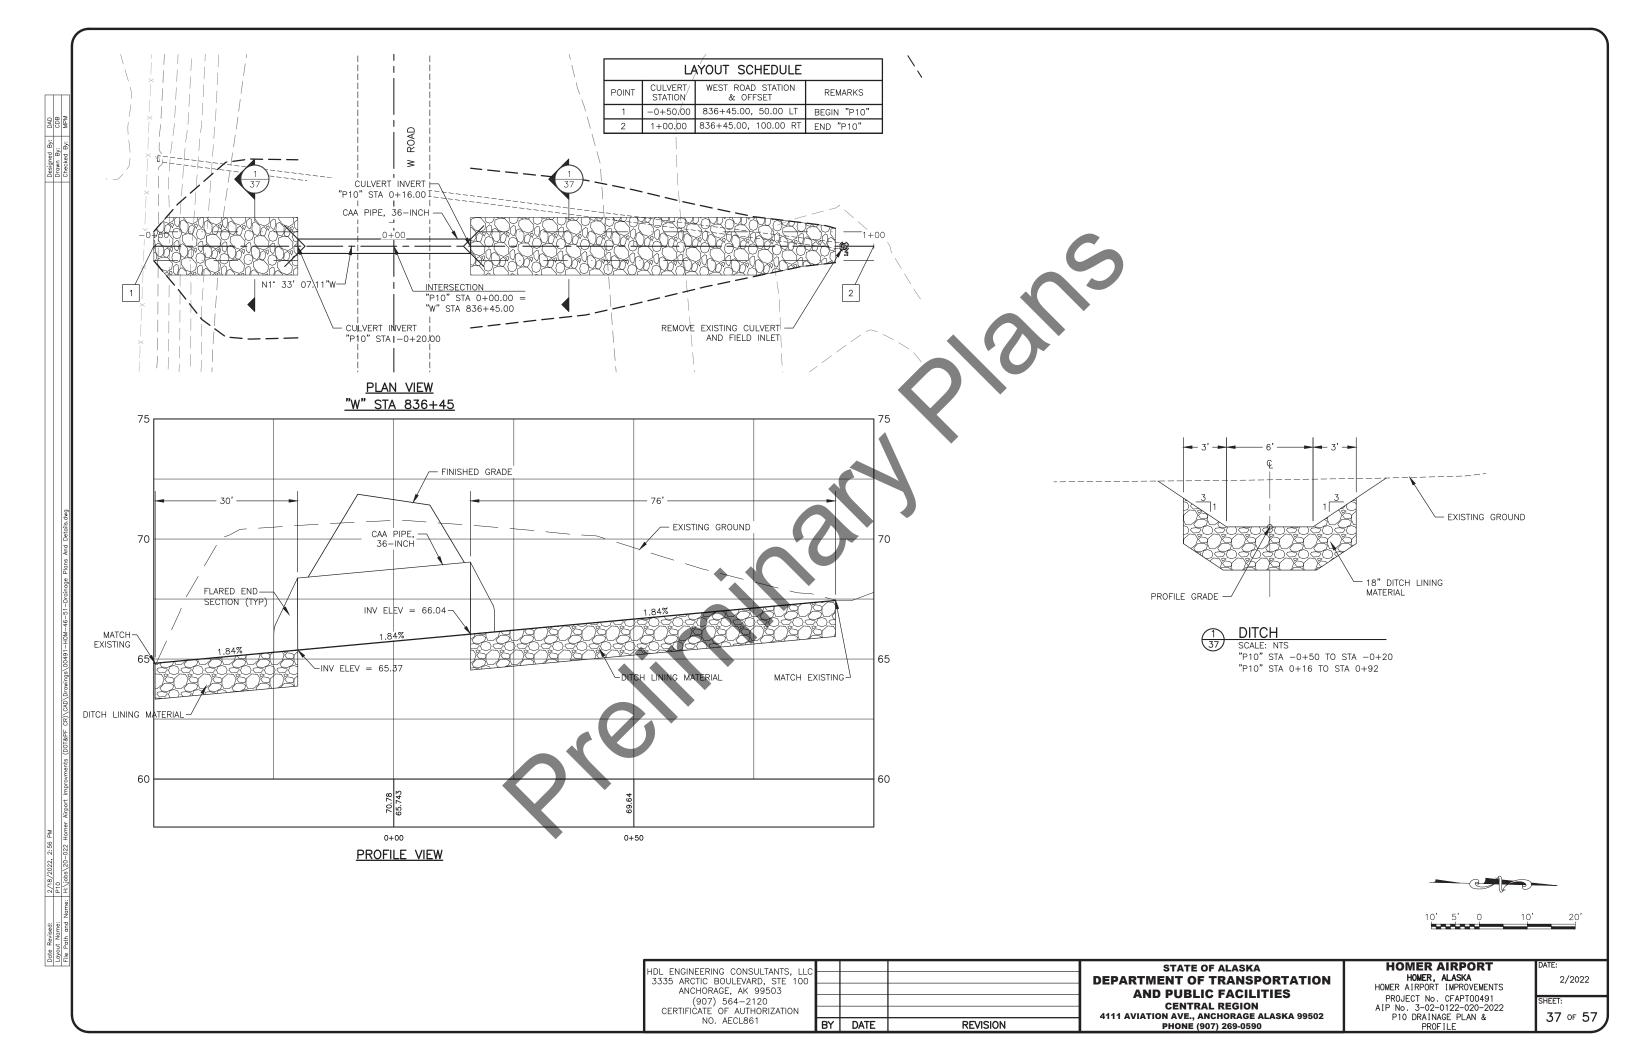


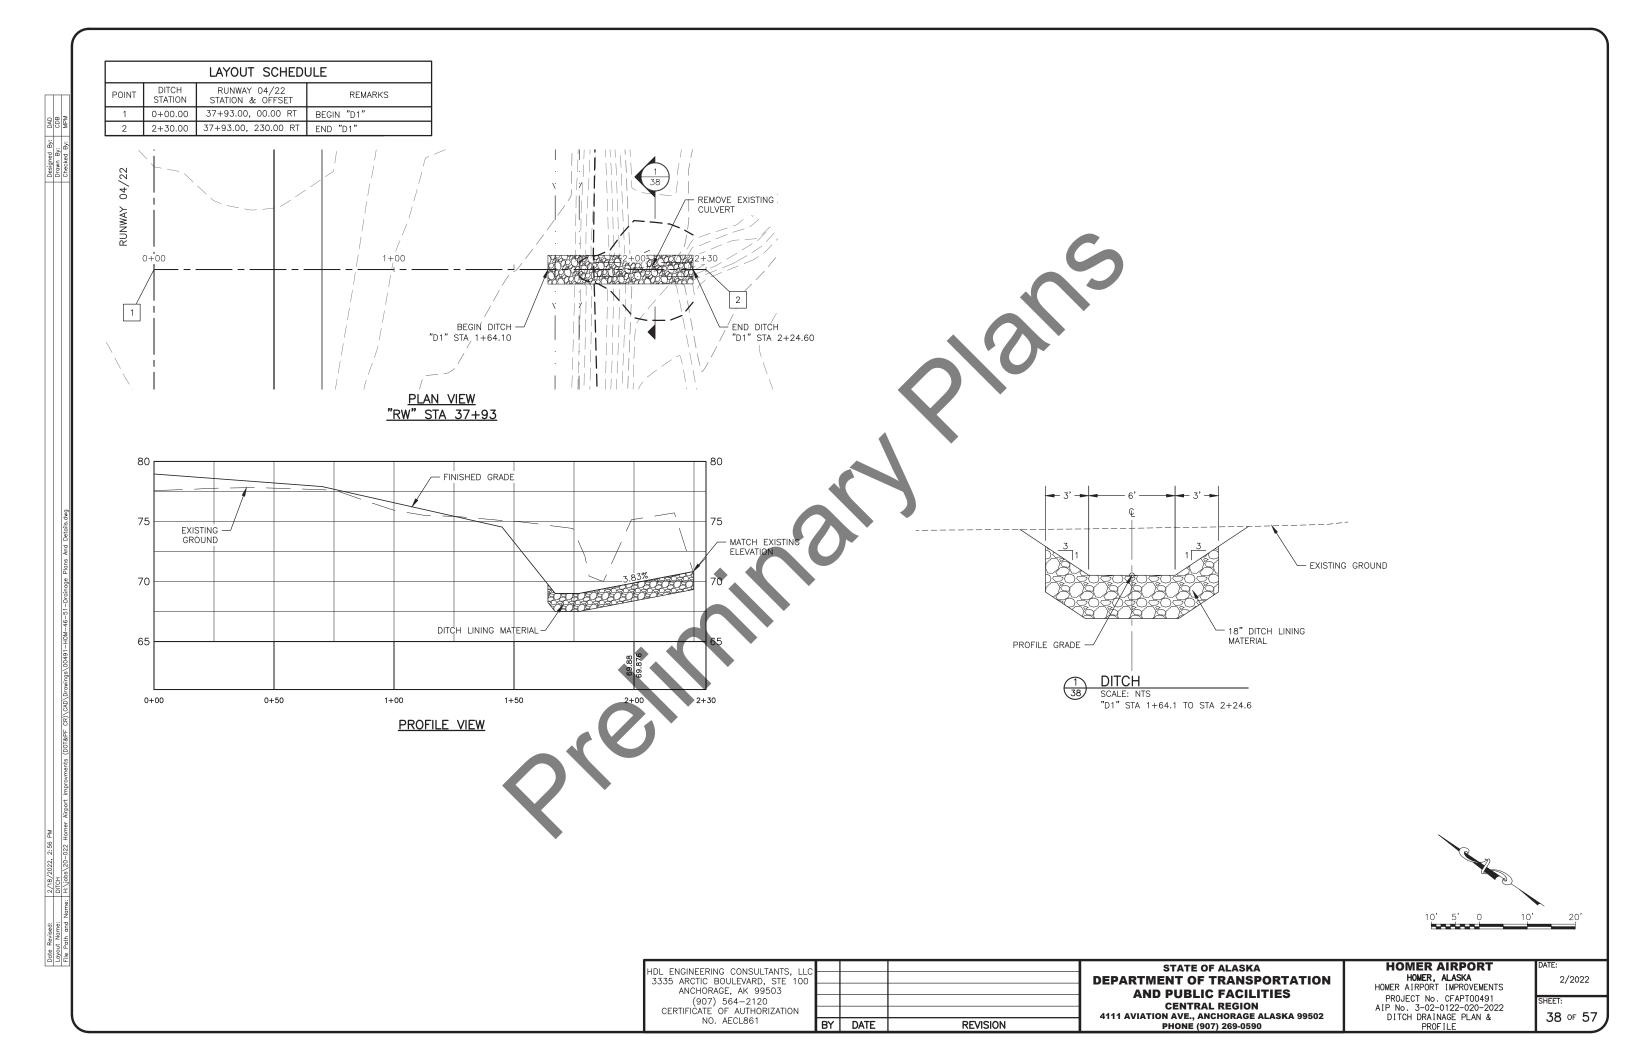

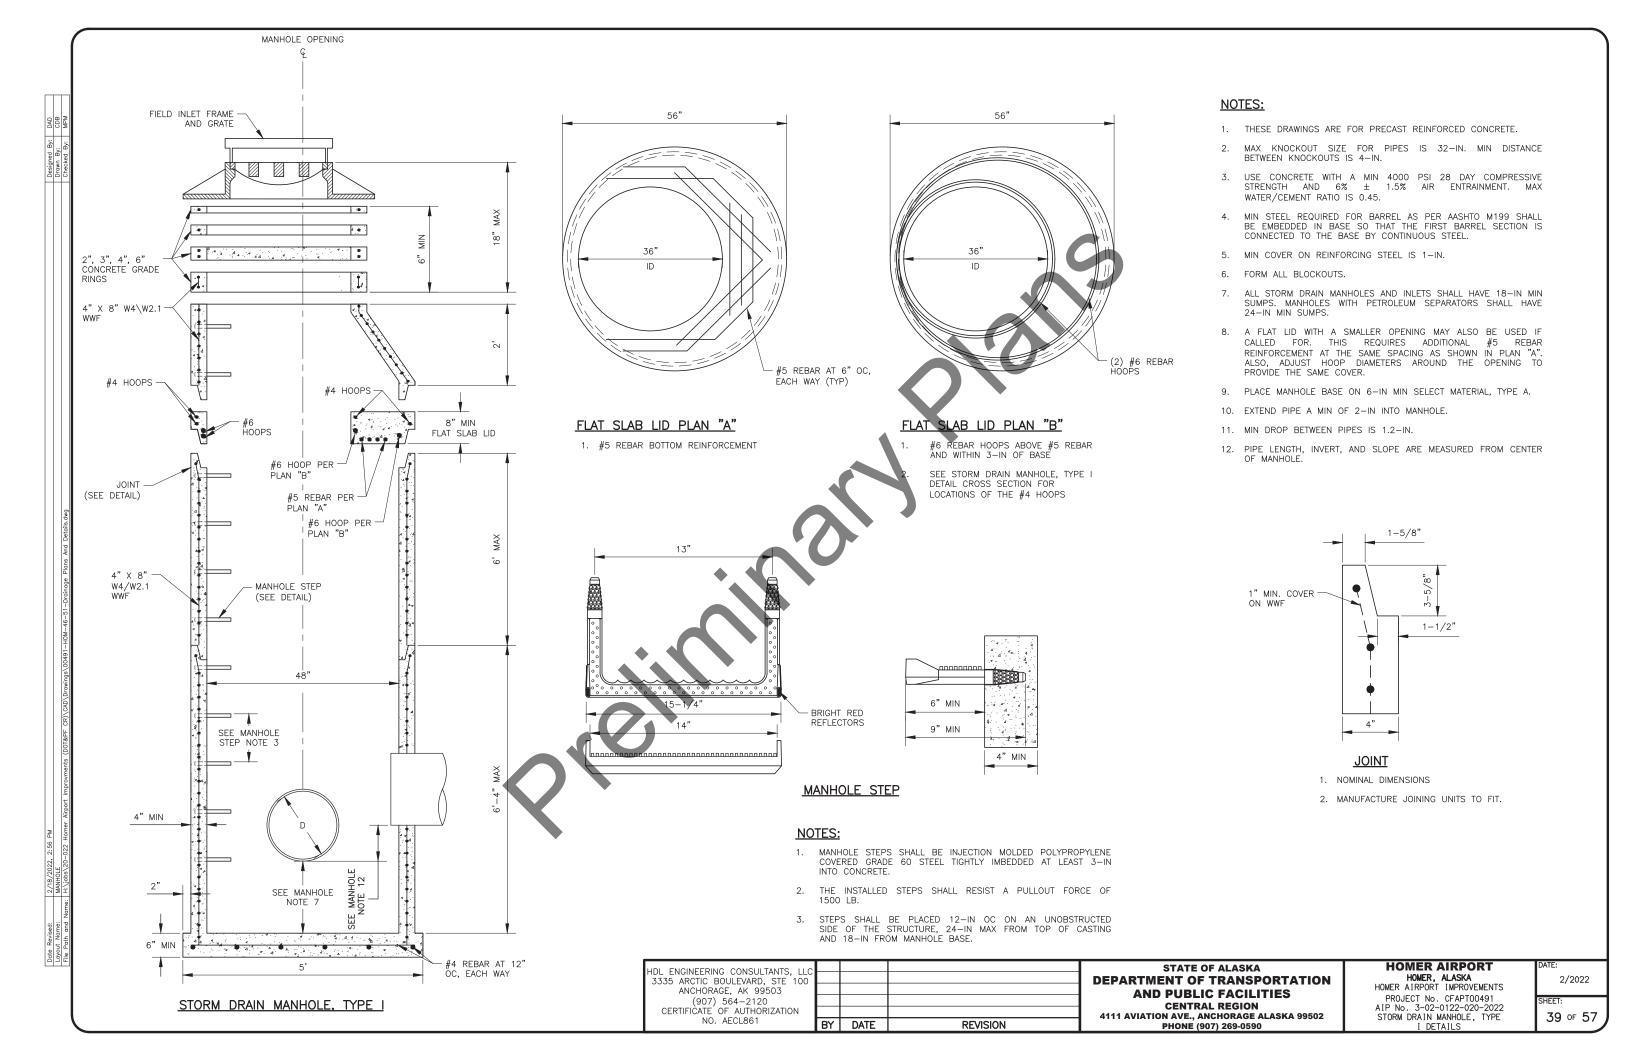

	PIPE SUMMARY TABLE									
ID	TYPE	LENGTH	START	ELEV.	END	ELEV.	DIA. (IN)	END SEC		
P1	CAA	342.1	RW STA 22+75 166R	54.00	RW STA 22+75 176L	51.50	48	0		
P2	CAA	134.6	MH1	69.40	RW STA 28+85 401R	65.91	24	1		
Р3	CAA	29.1	RW STA 41+47 678R	76.30	RW STA 41+27 657R	75.87	36	2		
P4	CAA	333.8	RW STA 76+75 172R	64.77	RW STA 76+75 162L	58.20	48	0		
P5	CAA	157.9	TWB STA 198+37 77L	61.25	TWB STA 198+35 81R	59.95	36	2		
P6	CAA	137.2	TWB STA 201+71 66L	60.22	TWB STA 201+73 71R	58.85	36	2		
P7	CAA	121.8	TWA STA 222+78 59L	55.76	TWA STA 222+74 63R	54.76	42	2		
P8	CAA	200.0	TWG STA 606+00 81R	63.61	TWG STA 606+00 118L	46.99	36	2		
P9	CAA	119.6	TWJ STA 622+78 57R	67.44	TWJ STA 622+78 62L	66.26	36	2		
P10	CAA	36.0	W STA 836+45 16R	66.04	W STA 836+45 20L	65.37	36	2		
P11	CAA	60.1	W STA 846+81 63L	64.70	W STA 846+21 64L	64.60	18	2		

	MANHOLE SUMMARY TABLE									
NAME	LOCATION	RIM ELEVATION	PIPES IN	PIPES OUT						
M1 RW STA 28+85.00 536R		74.79		P2 INV: 69.40						

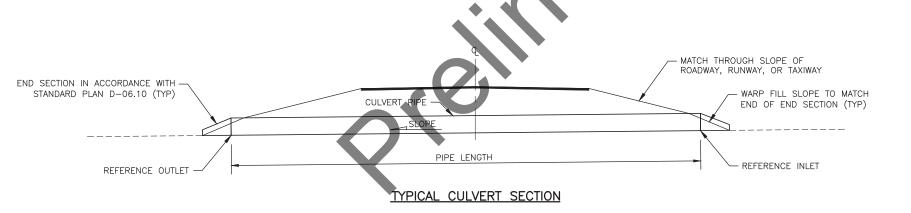



HDL ENGINEERING CONSULTANTS, LLC 3335 ARCTIC BOULEVARD, STE 100 ANCHORAGE, AK 99503 (907) 564-2120
CERTIFICATE OF AUTHORIZATION NO. AECL861 DATE REVISION


STATE OF ALASKA **DEPARTMENT OF TRANSPORTATION AND PUBLIC FACILITIES CENTRAL REGION** 4111 AVIATION AVE., ANCHORAGE ALASKA 99502 PHONE (907) 269-0590


HOMER AIRPORT HOMER, ALASKA HOMER AIRPORT IMPROVEMENTS PROJECT NO. CFAPTOO491 AIP No. 3-02-0122-020-2022 DRAINAGE PIPE SUMMARY AND DETAIL


2/2022 40 of 57

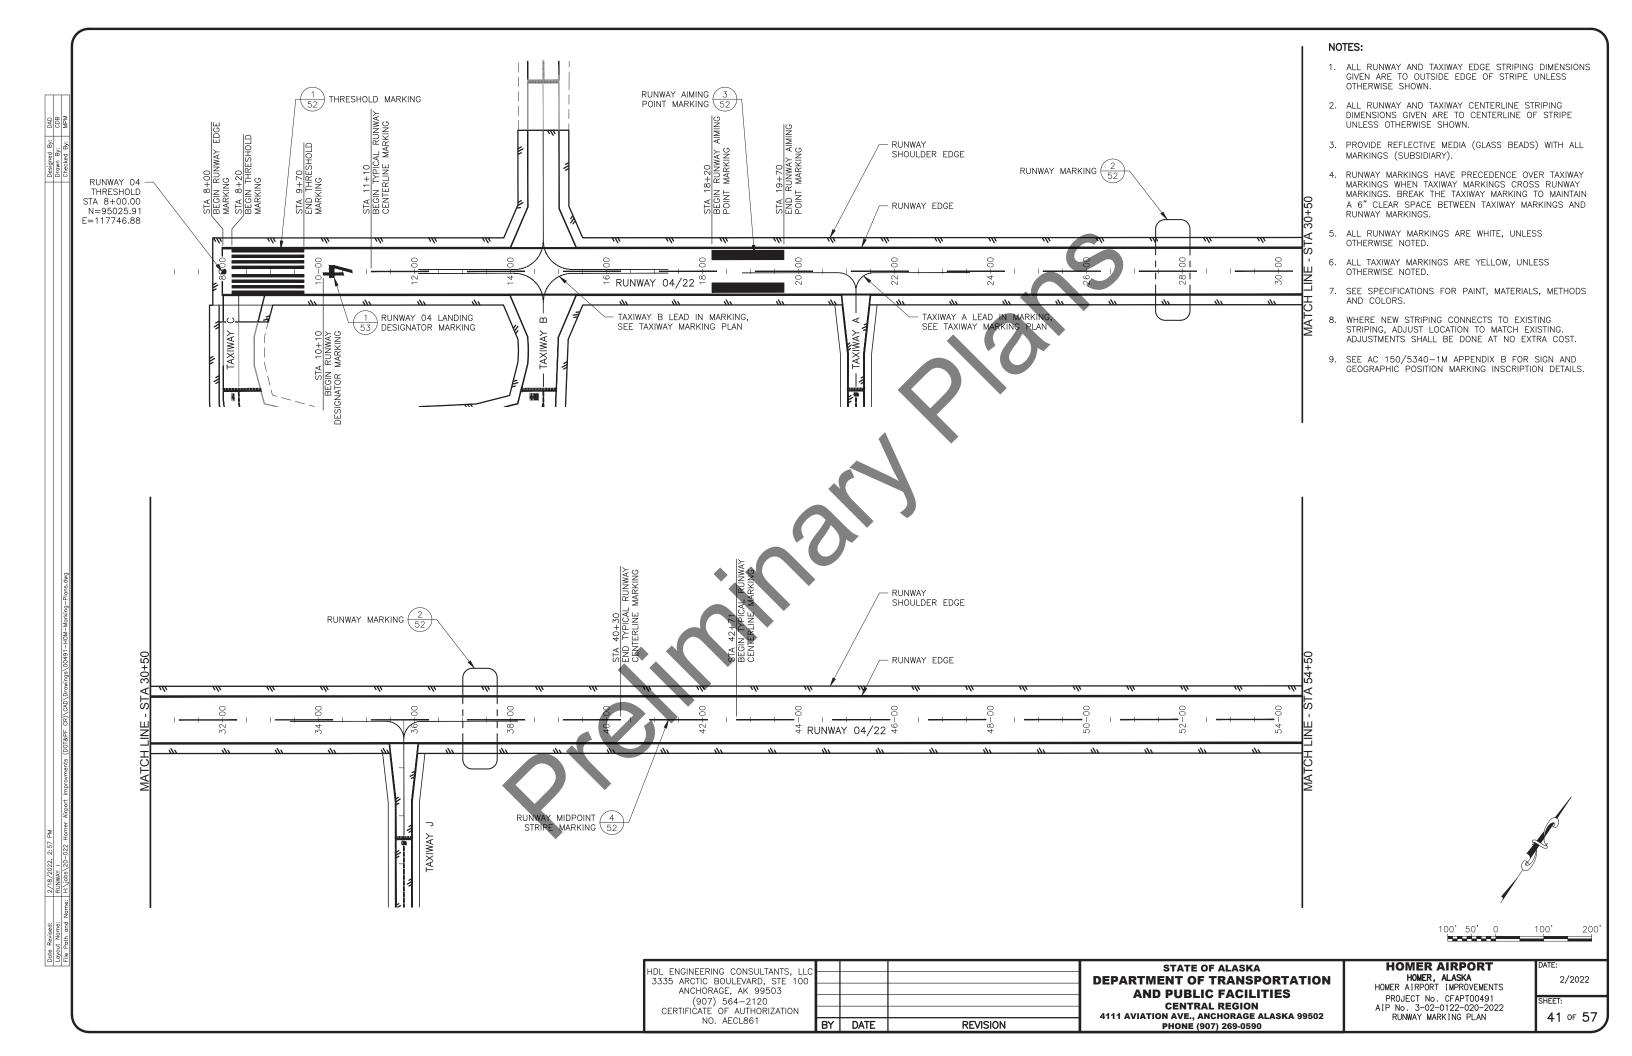


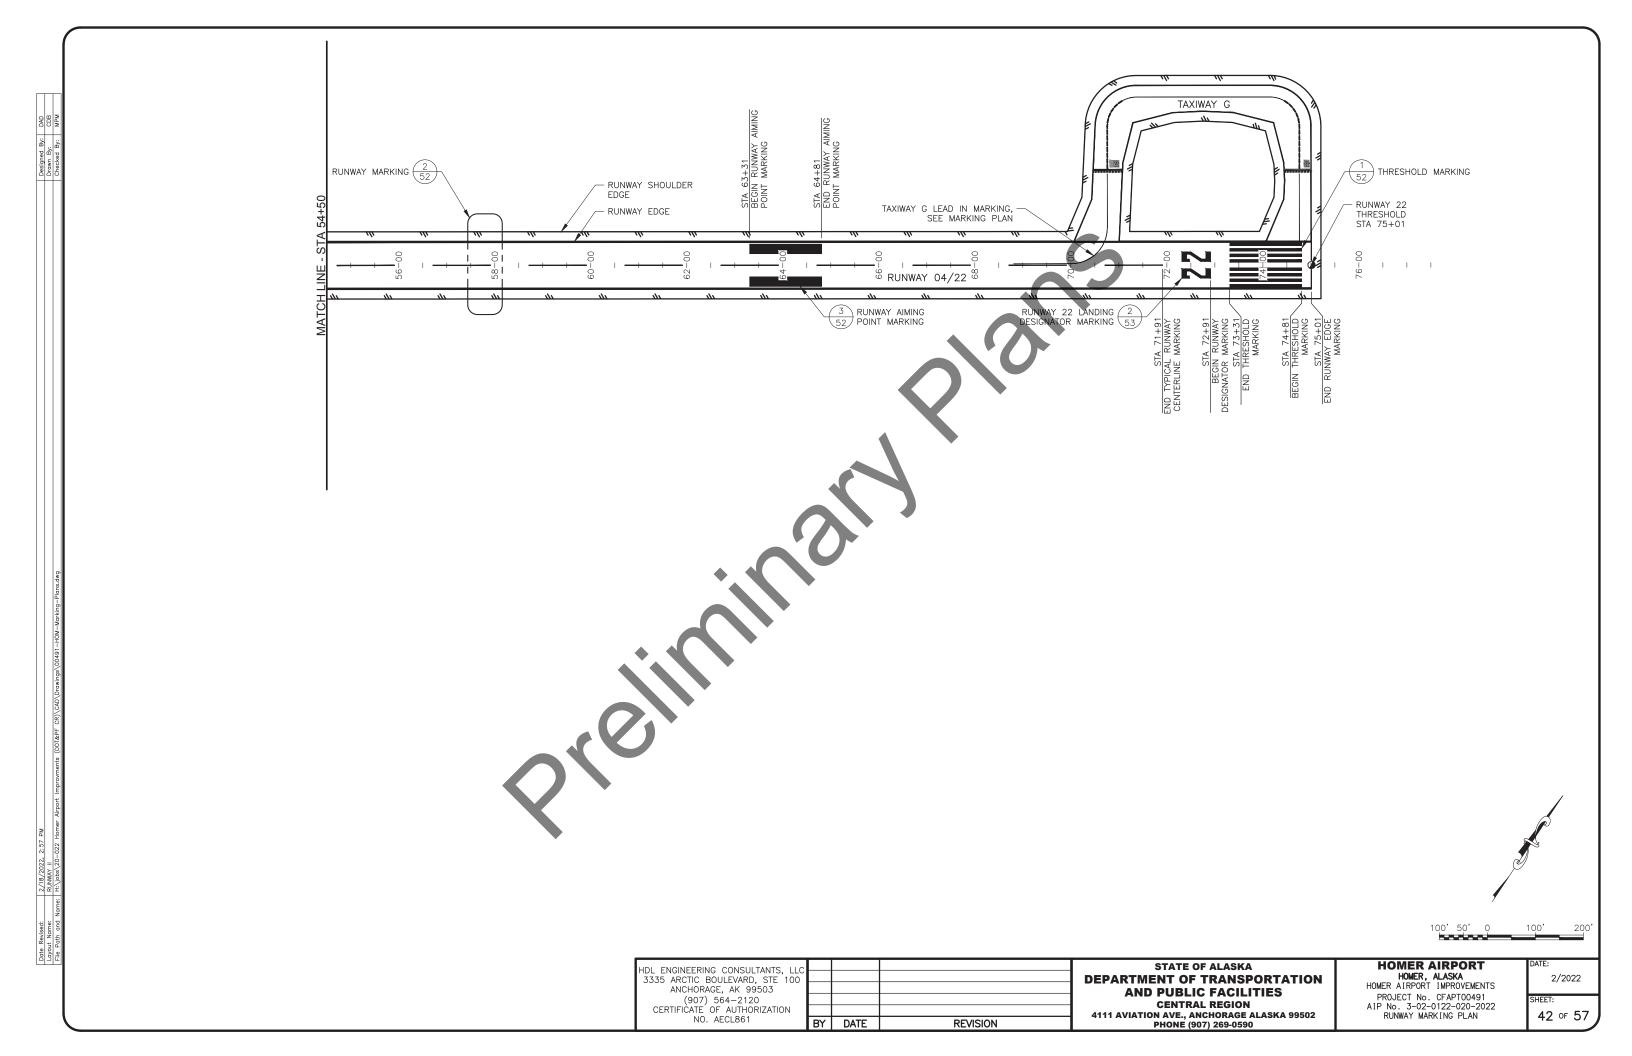


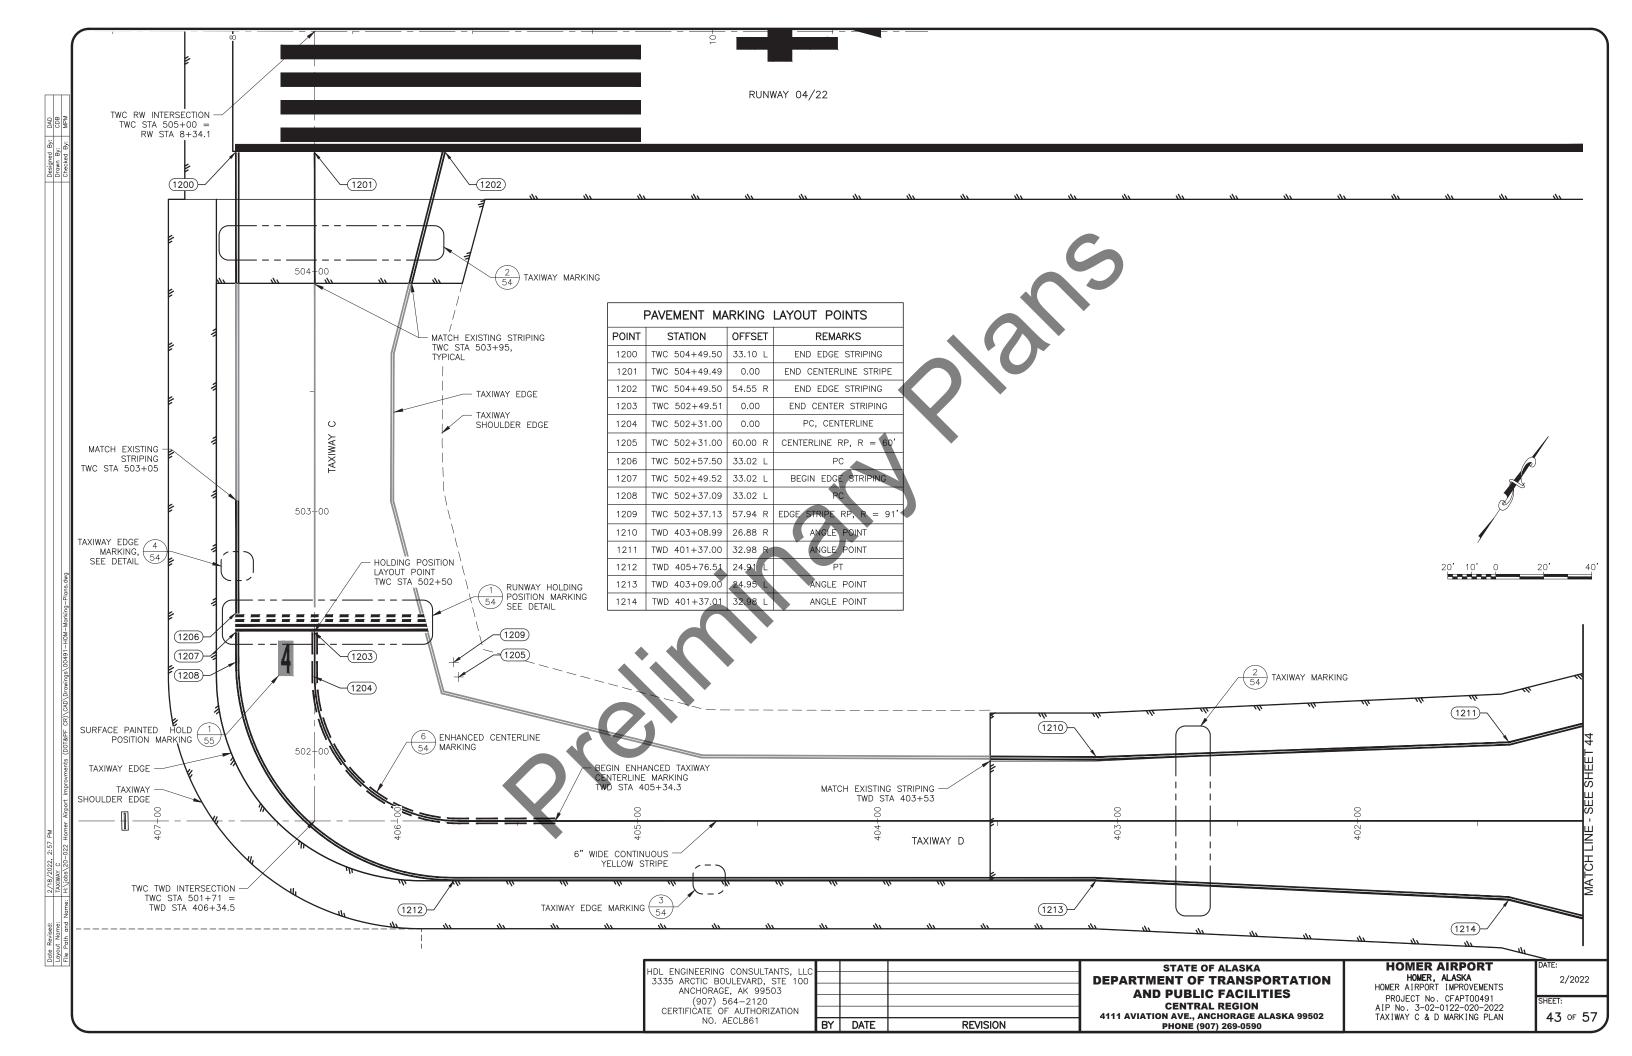


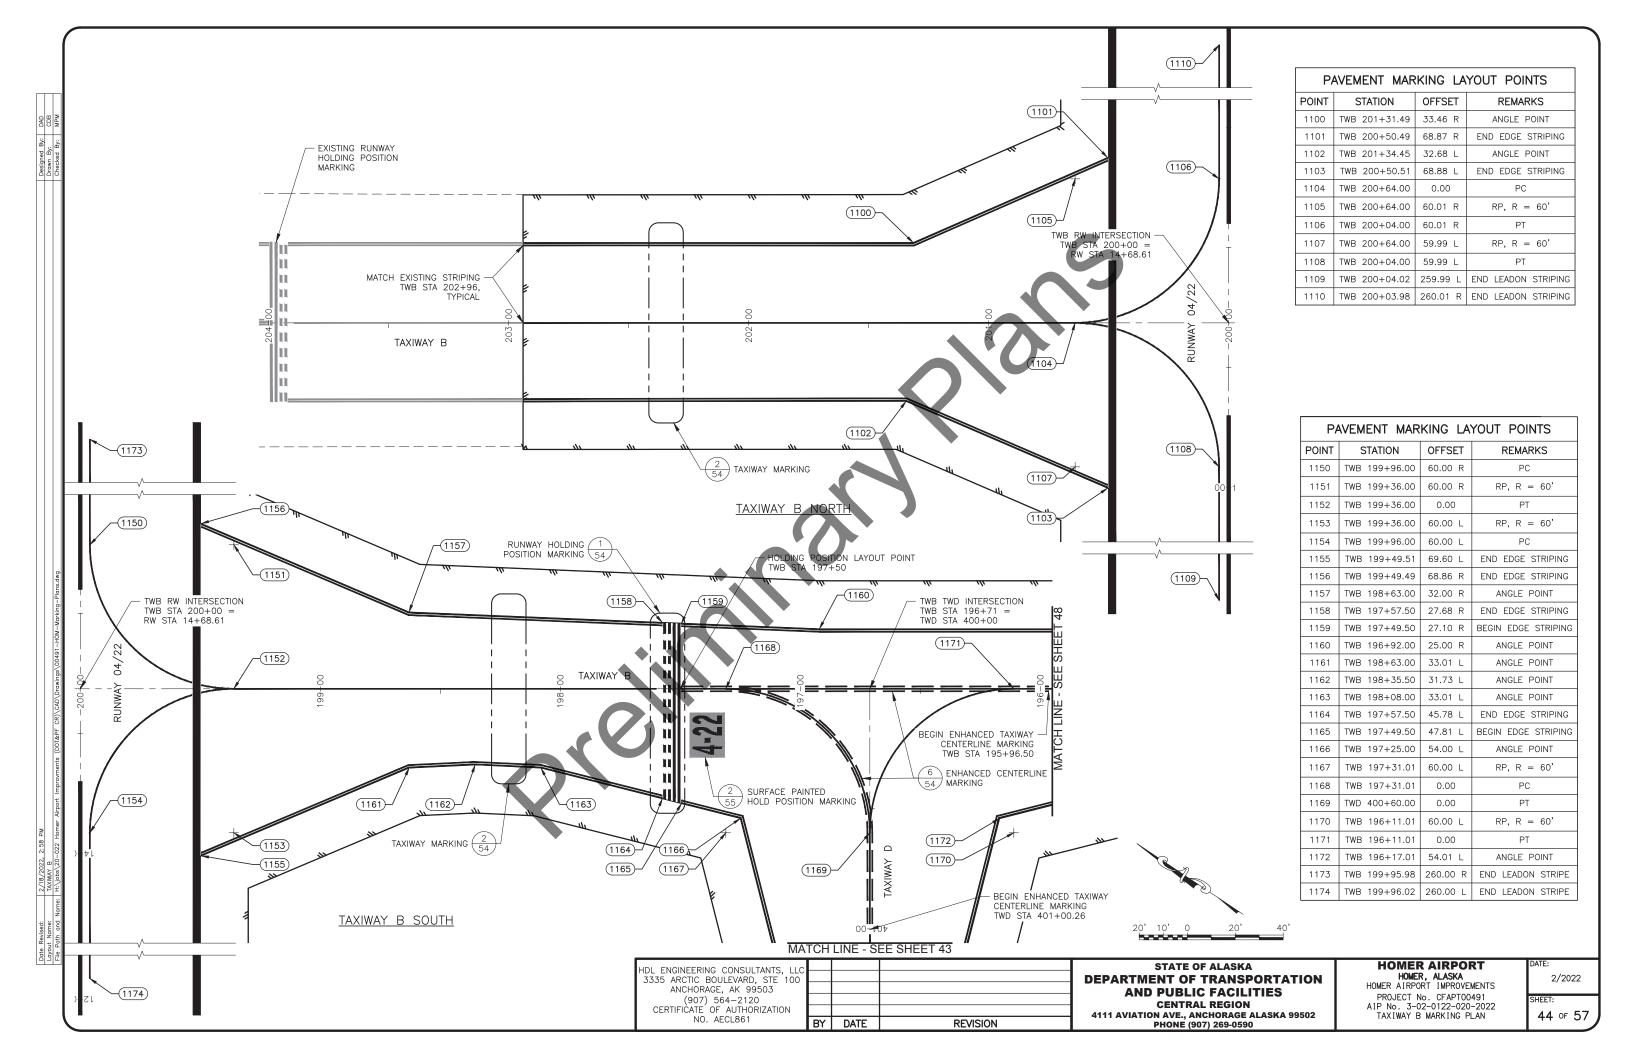


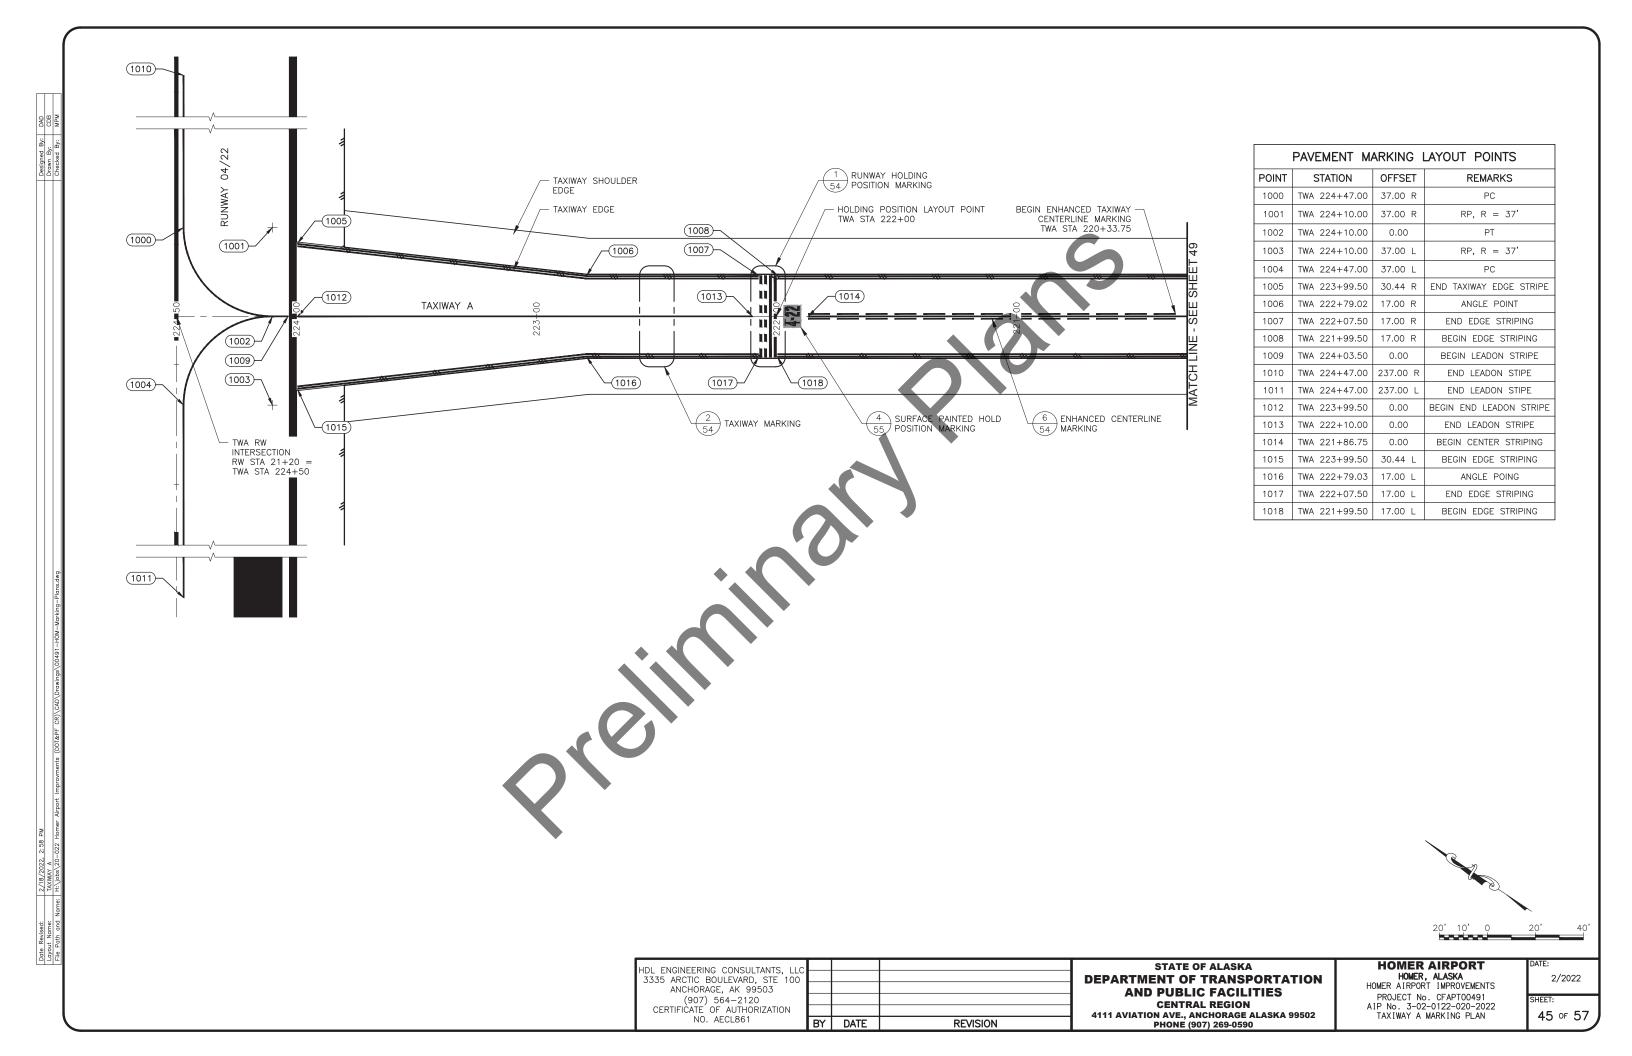


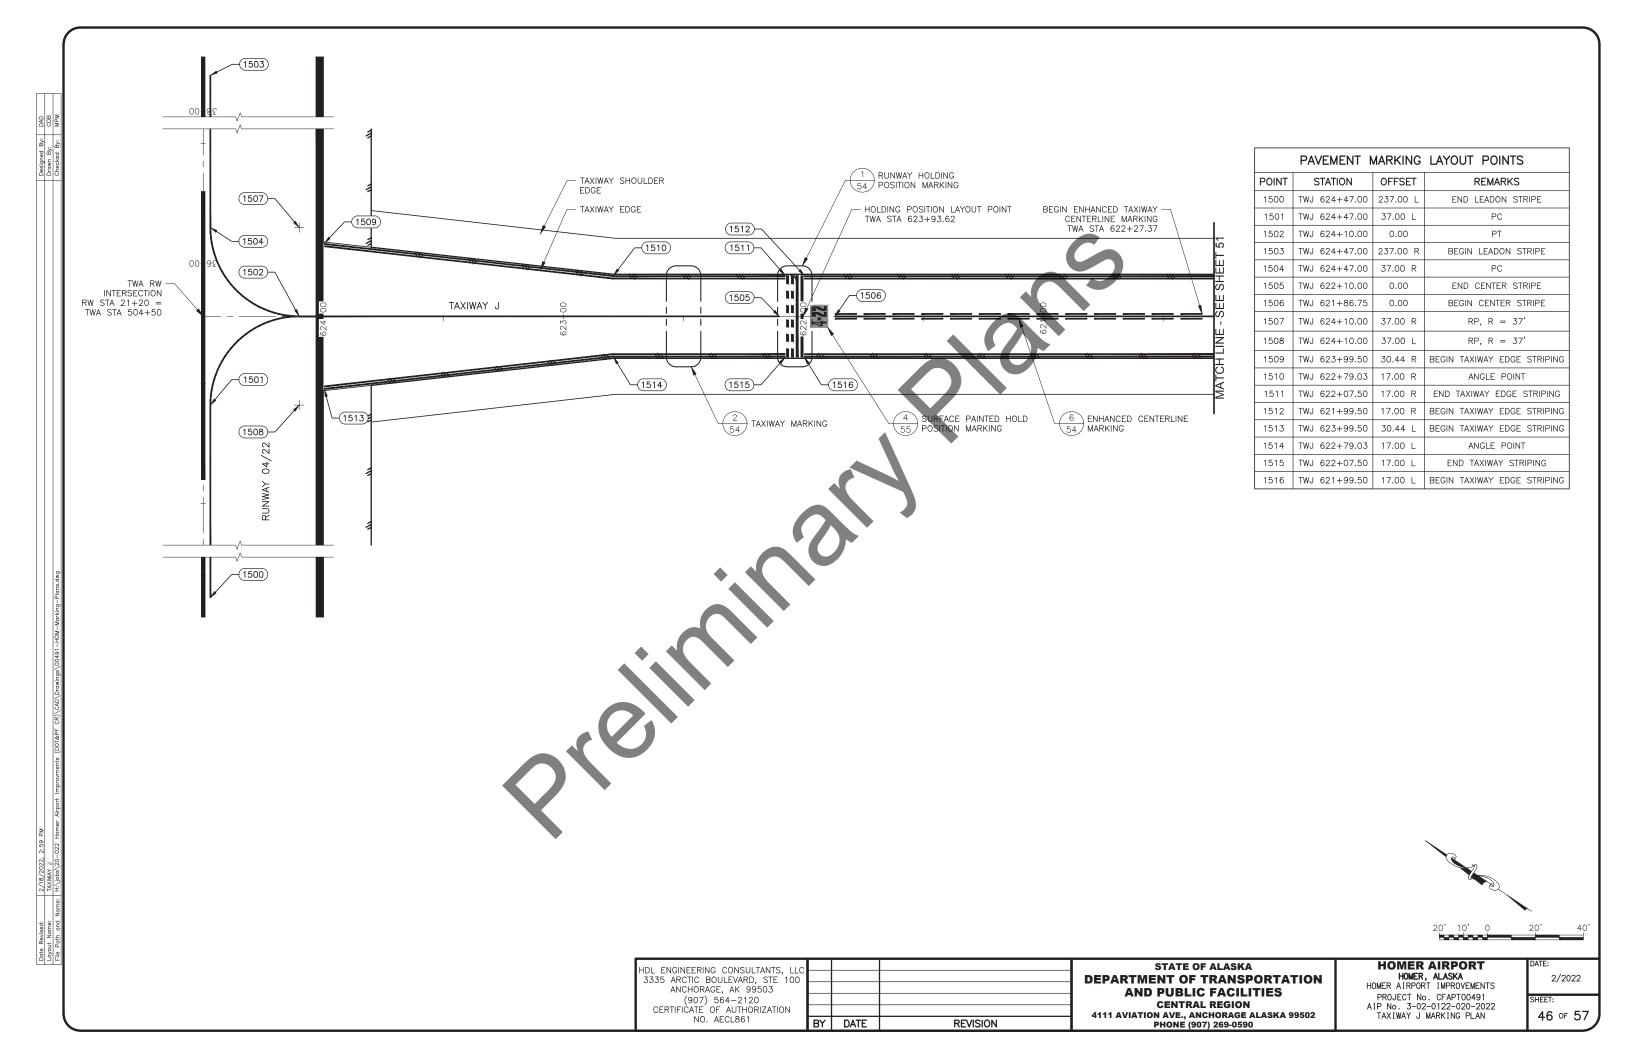


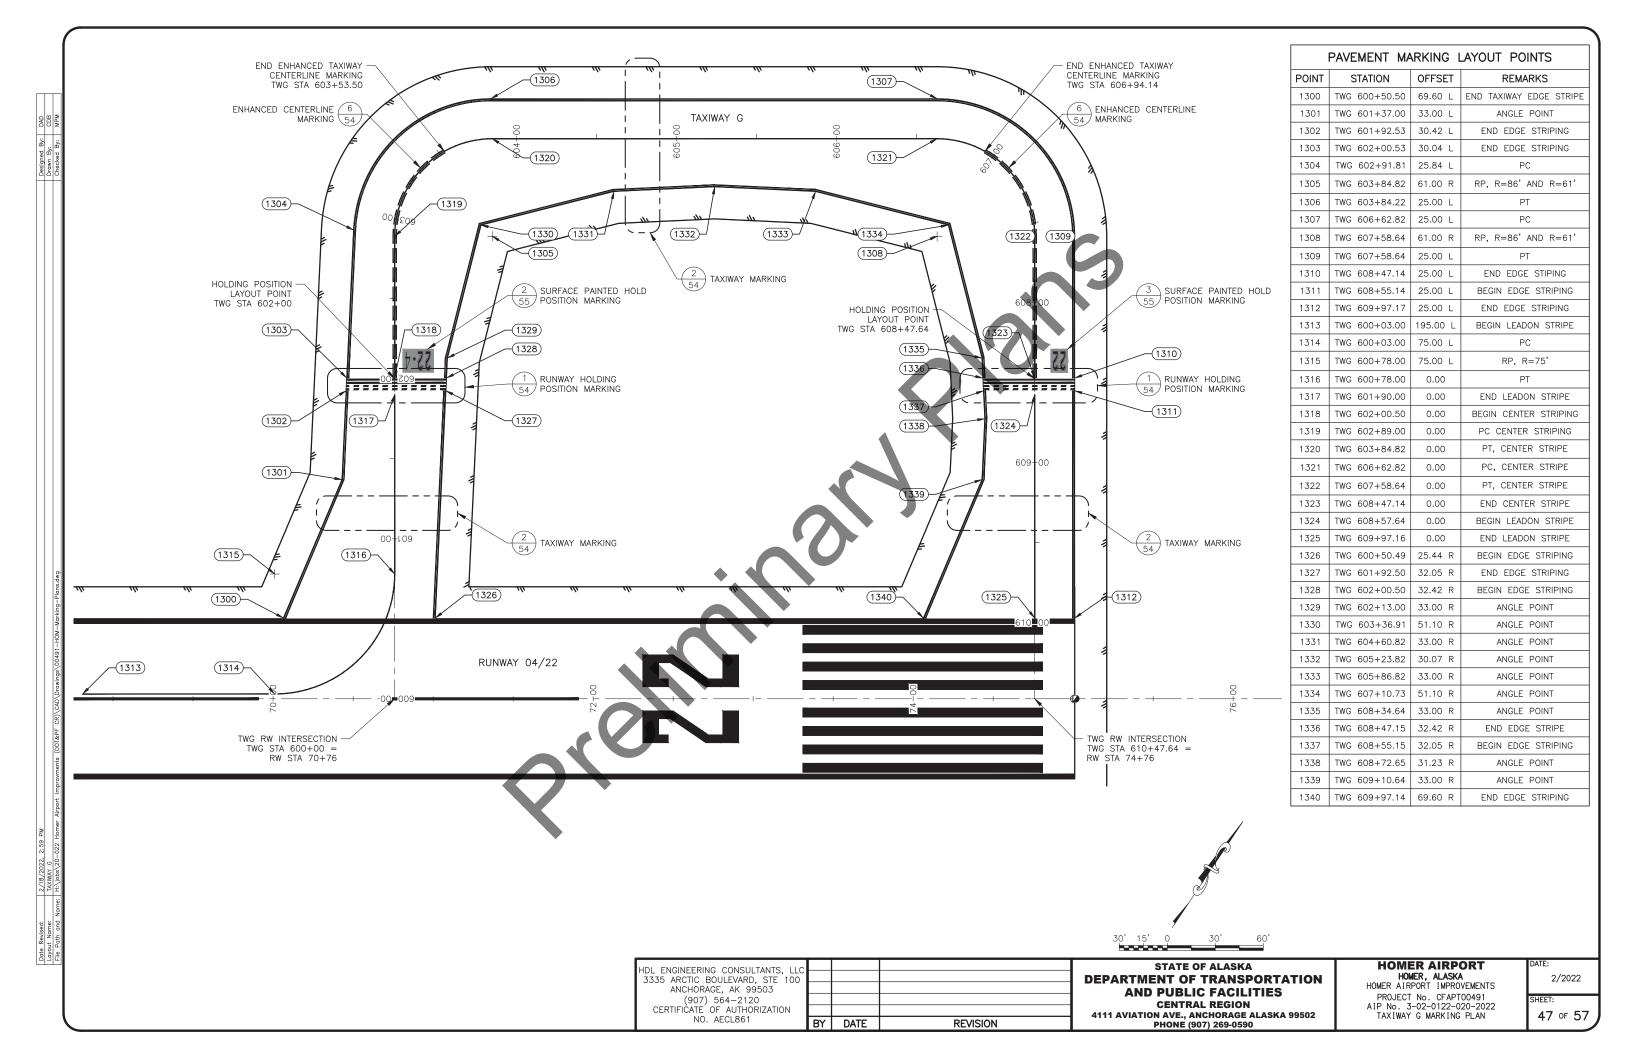

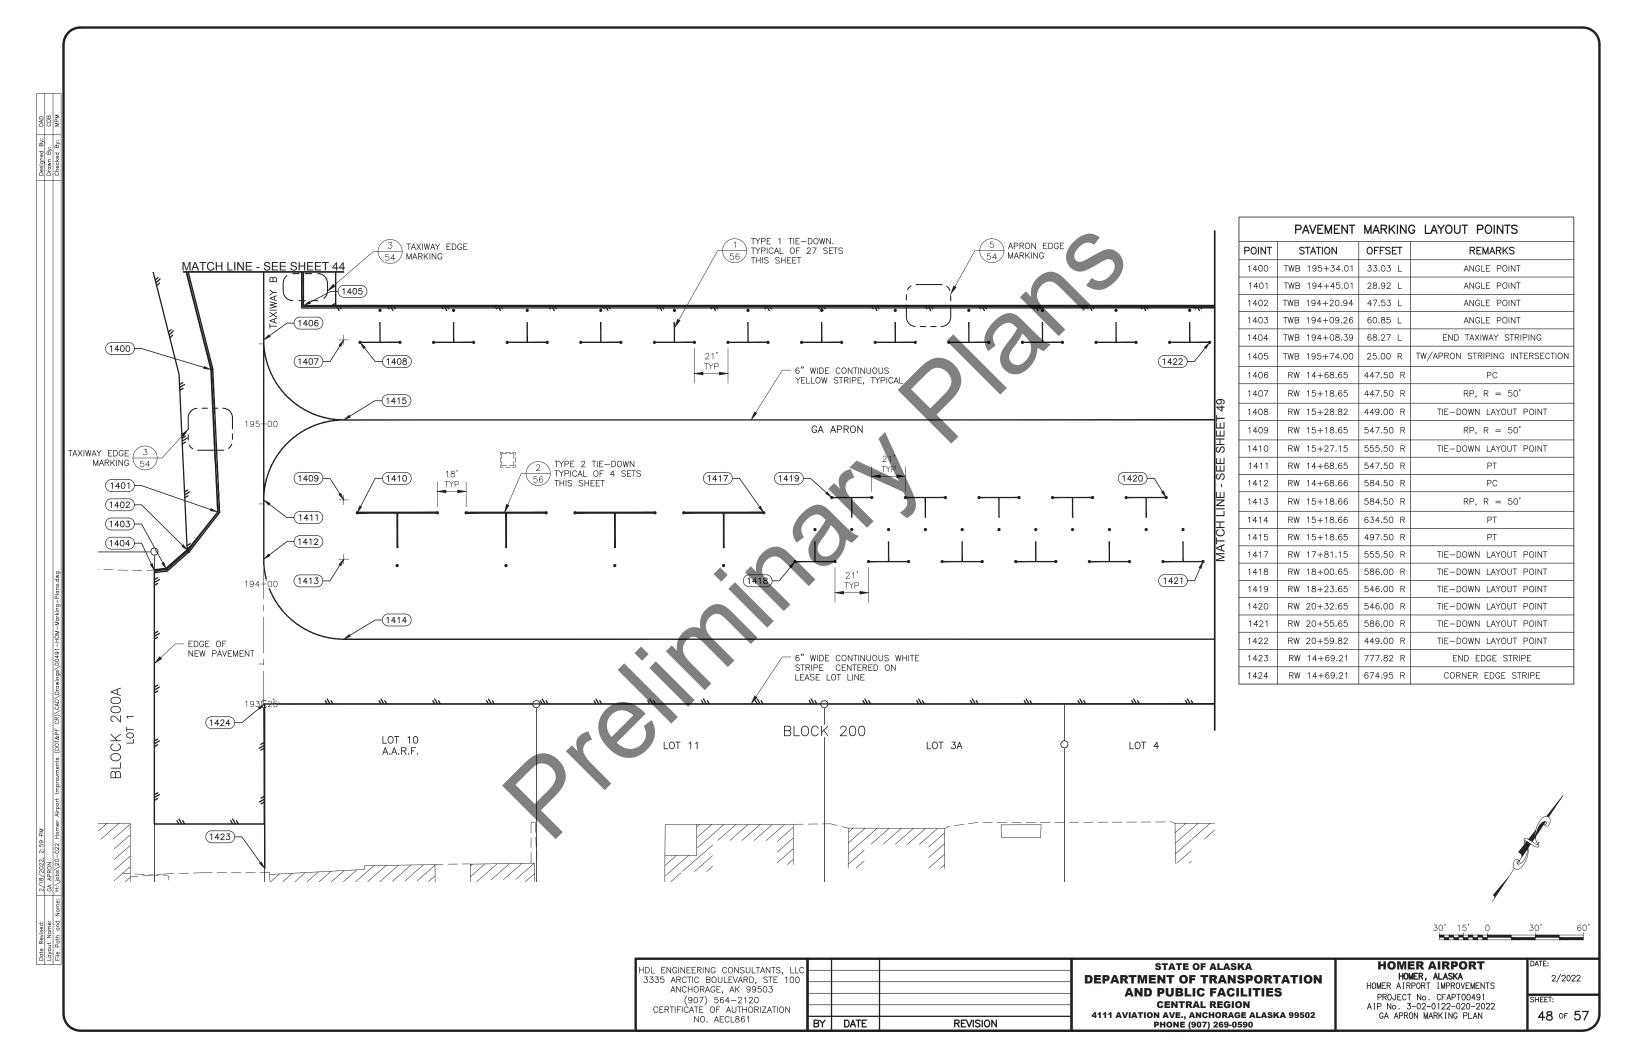

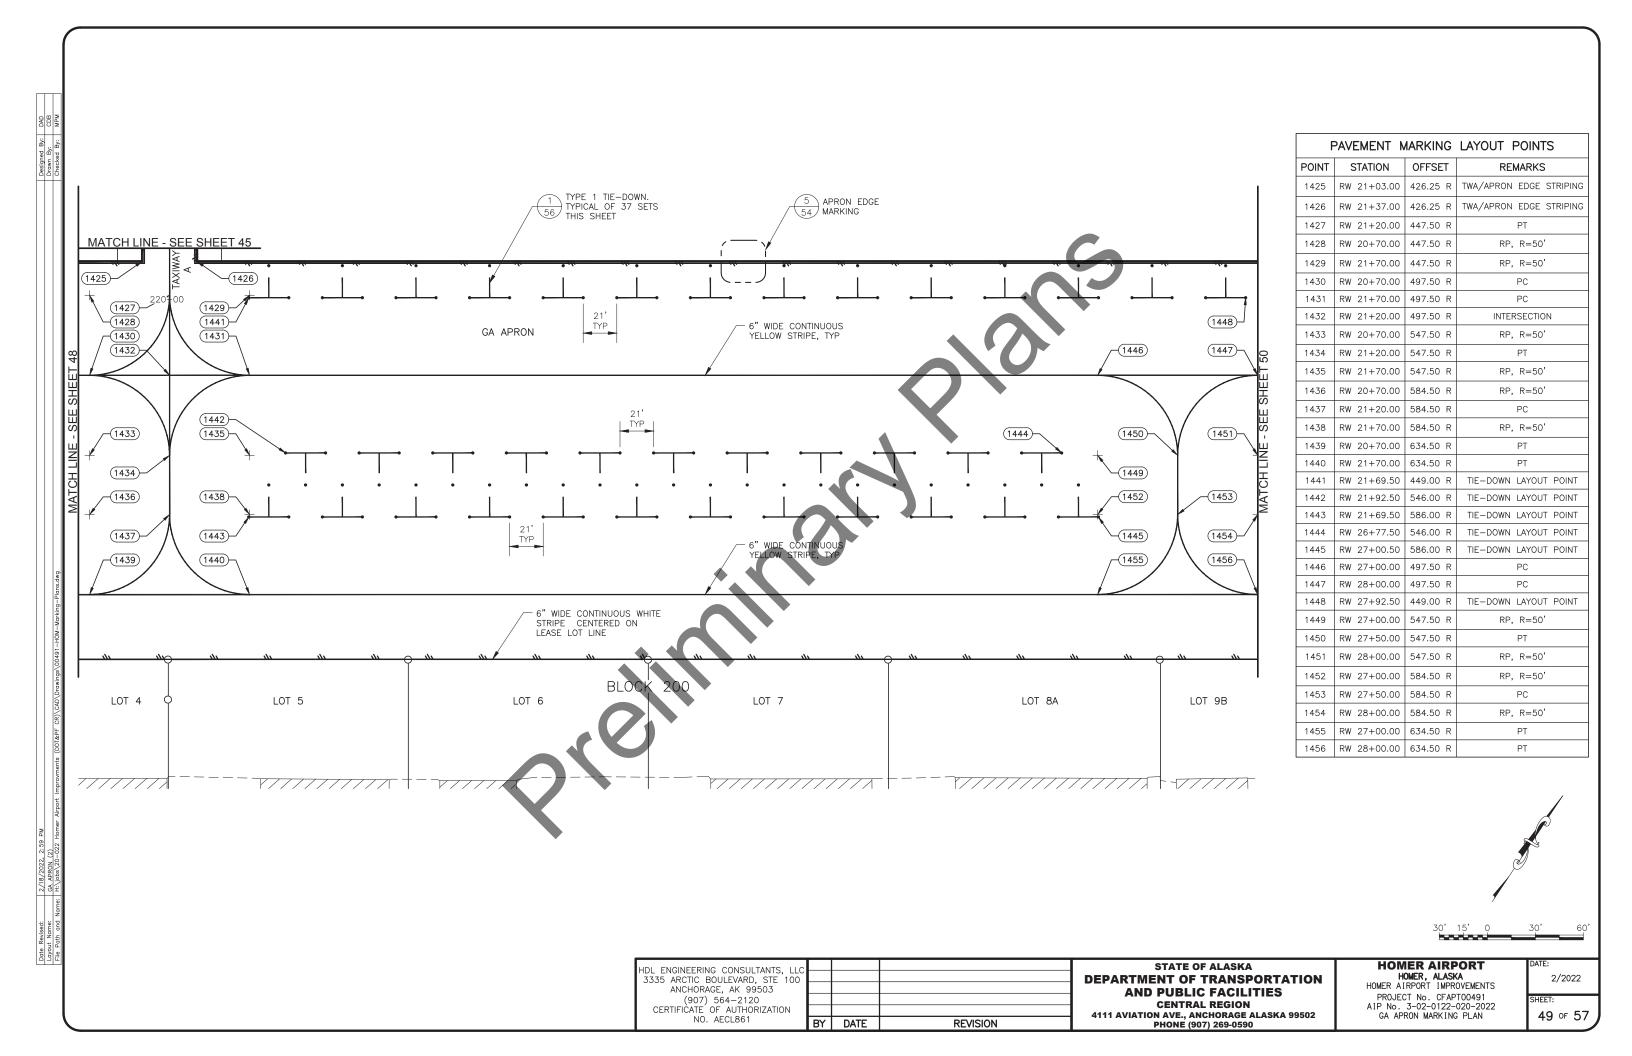

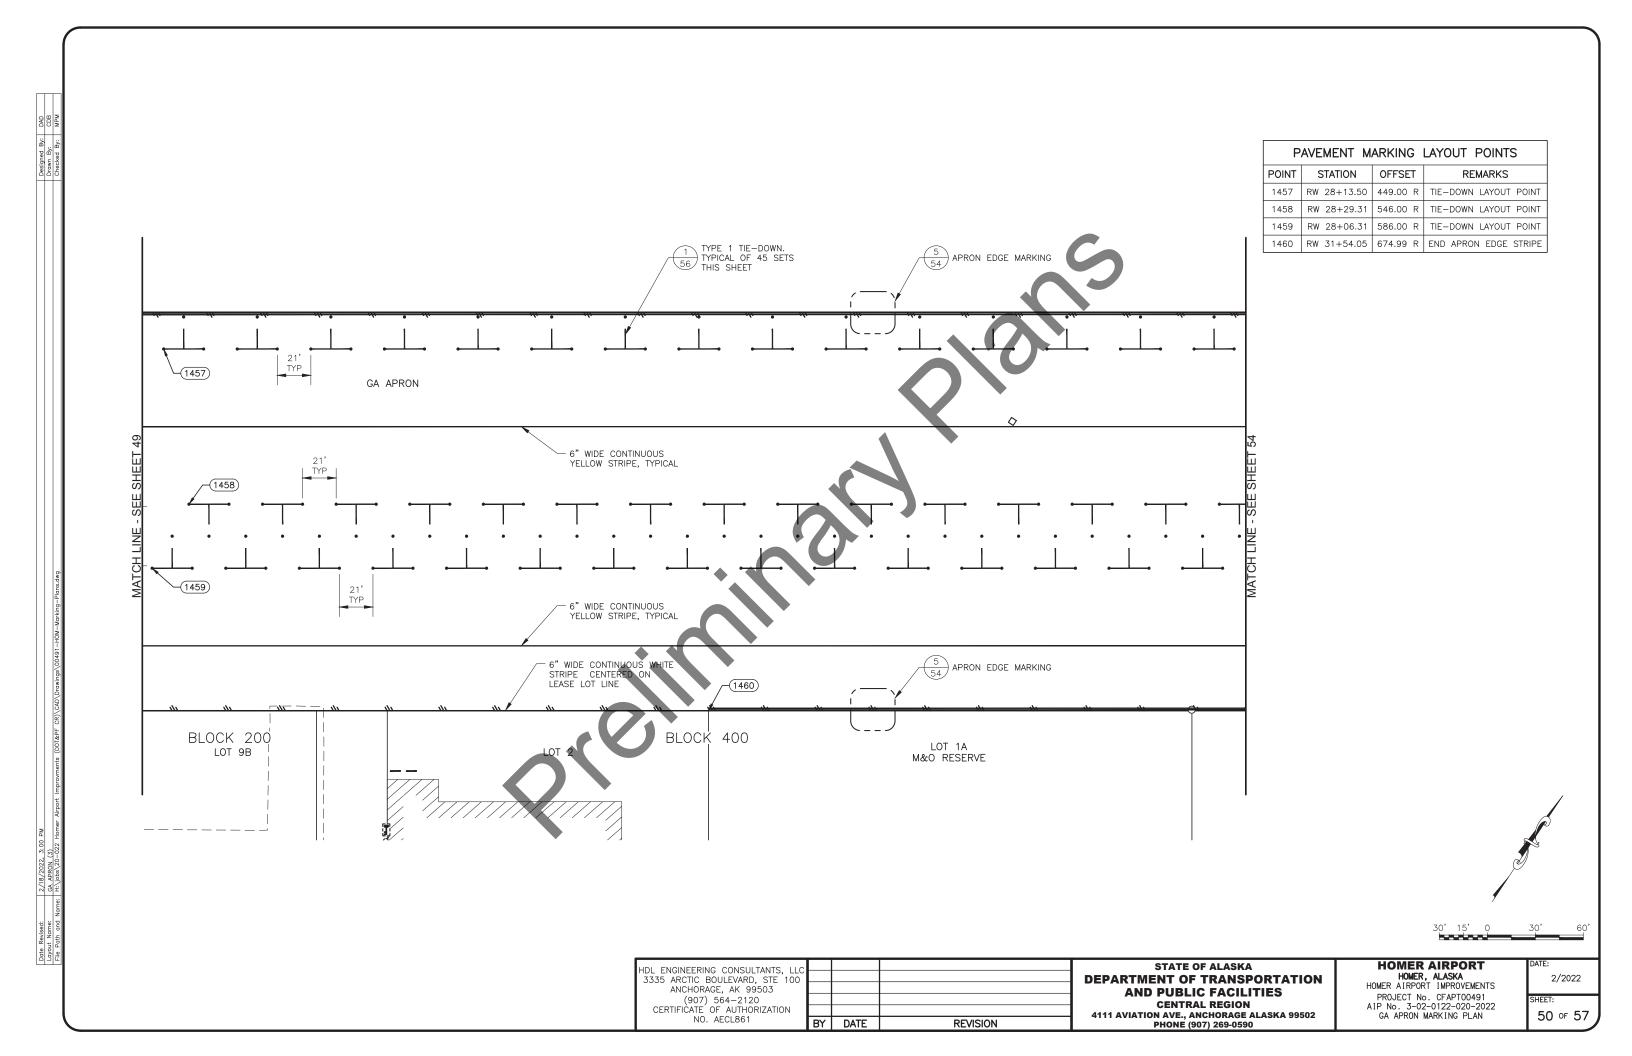

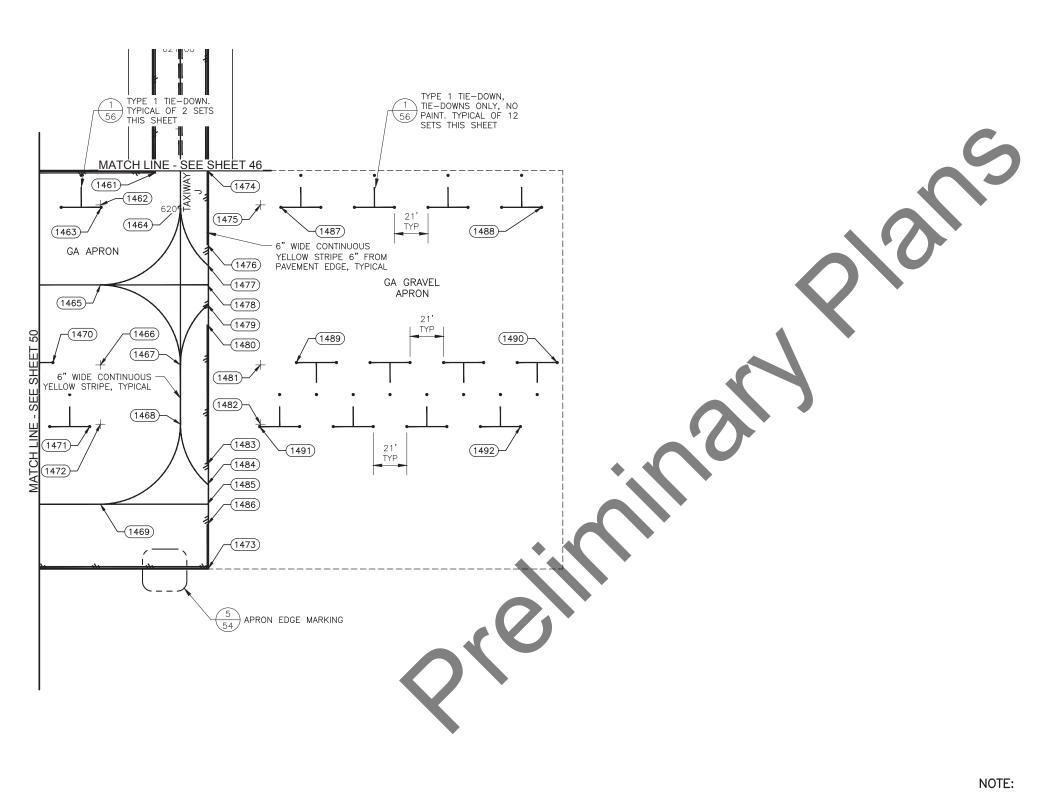

POINT 1461 F	STATION	OFFSET	
1461 F		OFFSEI	REMARKS
1	RW 35+62.25	427.50 R	END APRON EDGE STRIPING
1462 F	RW 35+28.00	447.50 R	RP, R=50'
1463 F	RW 35+28.50	449.00 R	TIE-DOWN LAYOUT POINT
1464 F	RW 35+78.00	447.50 R	PT
1465 F	RW 35+28.00	497.50 R	PC
1466 F	RW 35+28.00	547.50 R	RP, R=50'
1467 F	RW 35+78.00	547.50 R	TIE-DOWN LAYOUT POINT
1468 F	RW 35+78.00	584.50 R	PT
1469 F	RW 35+28.00	634.50 R	PC
1470 F	RW 34+98.31	546.00 R	TIE-DOWN LAYOUT POINT
1471 F	RW 35+21.31	586.00 R	TIE-DOWN LAYOUT POINT
1472 F	RW 35+28.00	584.50 R	RP, R = 50'
1473 F	RW 35+95.43	674.75 R	END APRON EDGE STRIPING
1474 F	RW 35+94.75	426.00 R	END STRIPE
1475 F	RW 36+28.00	447.50 R	RP, R = 50'
1476 F	RW 35+95.00	472.50 R	END STRIPE
1477 F	RW 35+95.00	485.00 R	END CENTERLINE STRIPE
1478 F	RW 35+94.75	497.50 R	END CENTERLINE STRIPE
1479 F	RW 35+95.00	509.94 R	END CENTERLINE STRIPE
1480 F	RW 35+95.00	522.50 R	END CENTERLINE STRIPE
1481 F	RW 36+28.00	547.50 R	RP, R = 50'
1482 F	RW 36+28.00	584.50 R	RP, R = 50'
1483 F	RW 35+94.75	609.50 R	END STRIPE
1484 F	RW 35+95.00	622.06 R	END CENTER STRIPE
1485 F	RW 35+94.75	634.50 R	END CENTER STRIPE
1486 F	RW 35+95.00	647.00 R	END STRIPE
1487 F	RW 36+40.75	449.00 R	TIE-DOWN LAYOUT POINT
1488 F	RW 38+03.75	449.00 R	TIE-DOWN LAYOUT POINT
1489 F	RW 36+50.50	546.00 R	TIE-DOWN LAYOUT POINT
1490 F	RW 38+13.50	546.00 R	TIE-DOWN LAYOUT POINT
1491 F	RW 36+27.50	586.00 R	TIE-DOWN LAYOUT POINT
1492 F	RW 37+90.50	586.00 R	TIE-DOWN LAYOUT POINT

1. TIE-DOWNS ON GRAVEL SHALL NOT BE MARKED.



HDL ENGINEERING CONSULTANTS, LLC
3335 ARCTIC BOULEVARD, STE 100
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CERTIFICATE OF AUTHORIZATION
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BY	DATE	REVISION	
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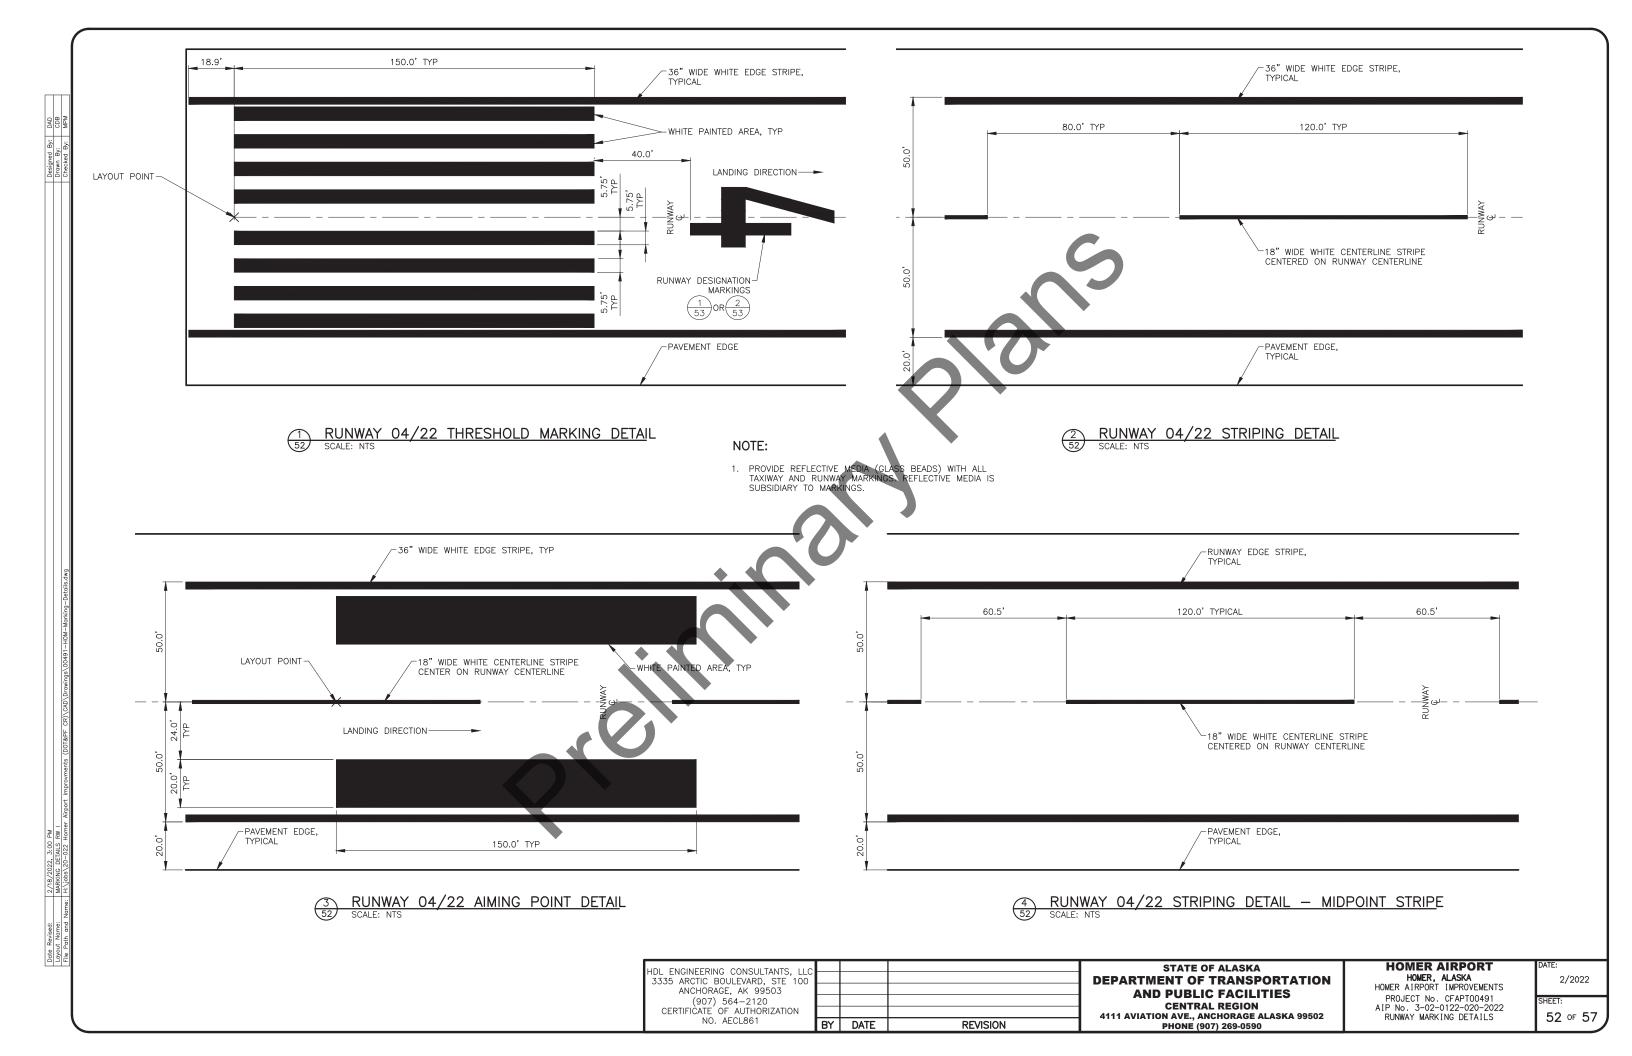
STATE OF ALASKA DEPARTMENT OF TRANSPORTATION AND PUBLIC FACILITIES


CENTRAL REGION
4111 AVIATION AVE., ANCHORAGE ALASKA 99502
PHONE (907) 269-0590

HOMER AIRPORT
HOMEK AIKFORT
HOMER. ALASKA
HOMER AIRPORT IMPROVEMENTS
DDO IDOT No ODADTOOAOA
PROJECT No. CFAPT00491
AIP No. 3-02-0122-020-2022
GA APRON AND GA GRAVEL APRON
MARKING PLAN
MAINTING FLAN

DATE: 2/2022


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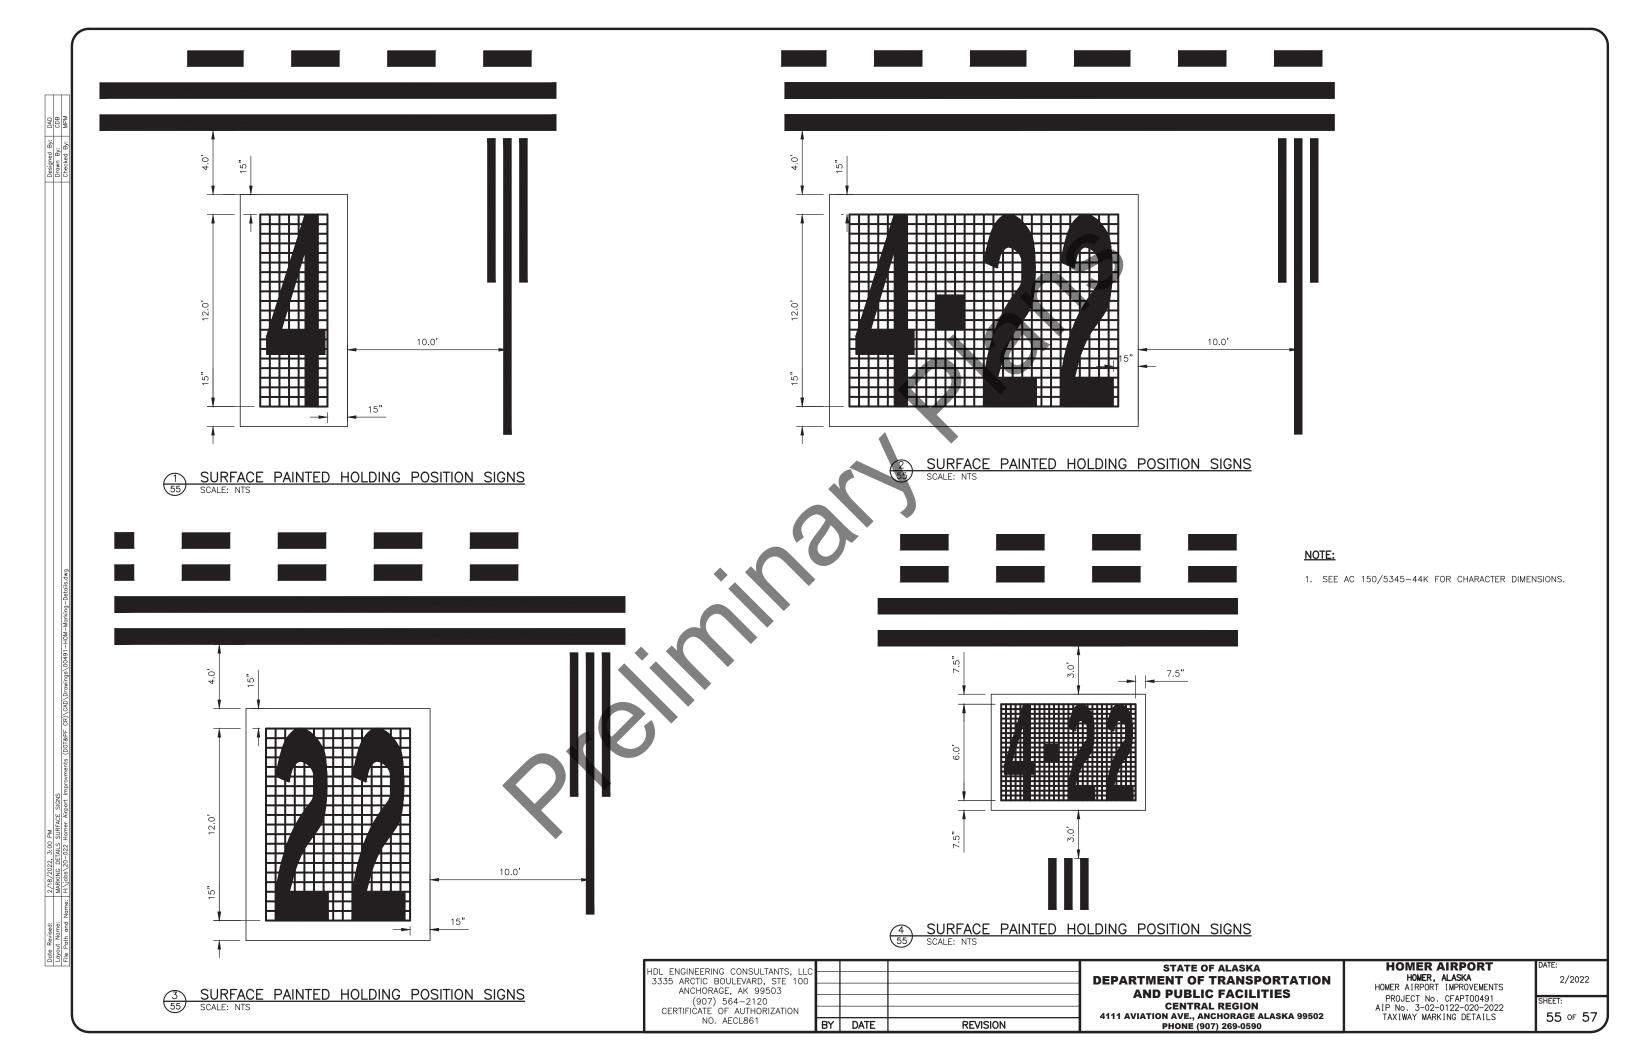


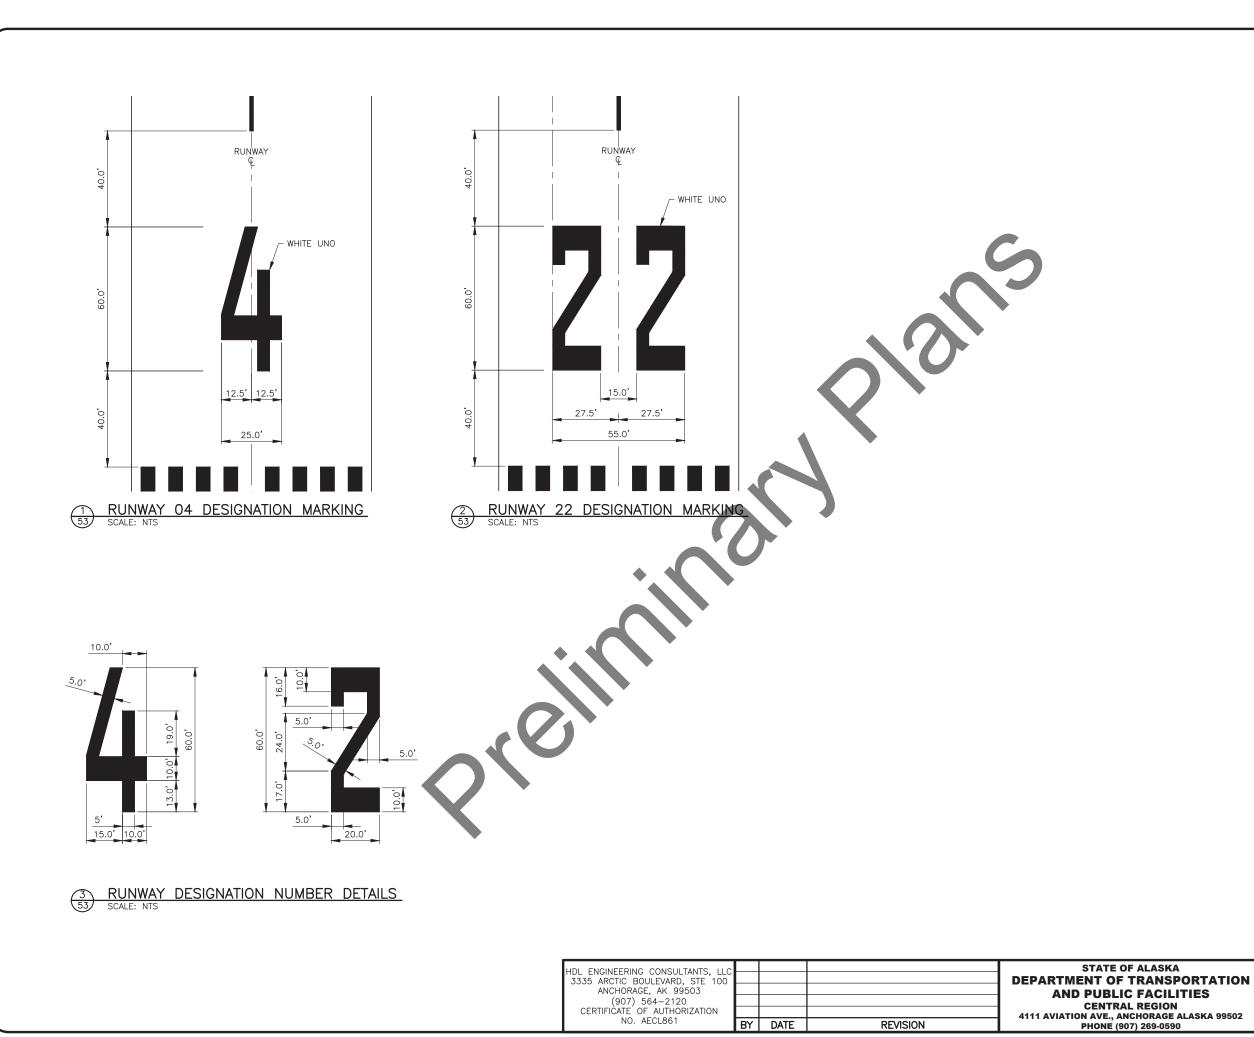


HOMER AIRPORT
HOMER, ALASKA
HOMER AIRPORT IMPROVEMENTS 2/2022 PROJECT No. CFAPT00491 AIP No. 3-02-0122-020-2022 RUNWAY MARKING DETAILS SHEET:

53 of 57



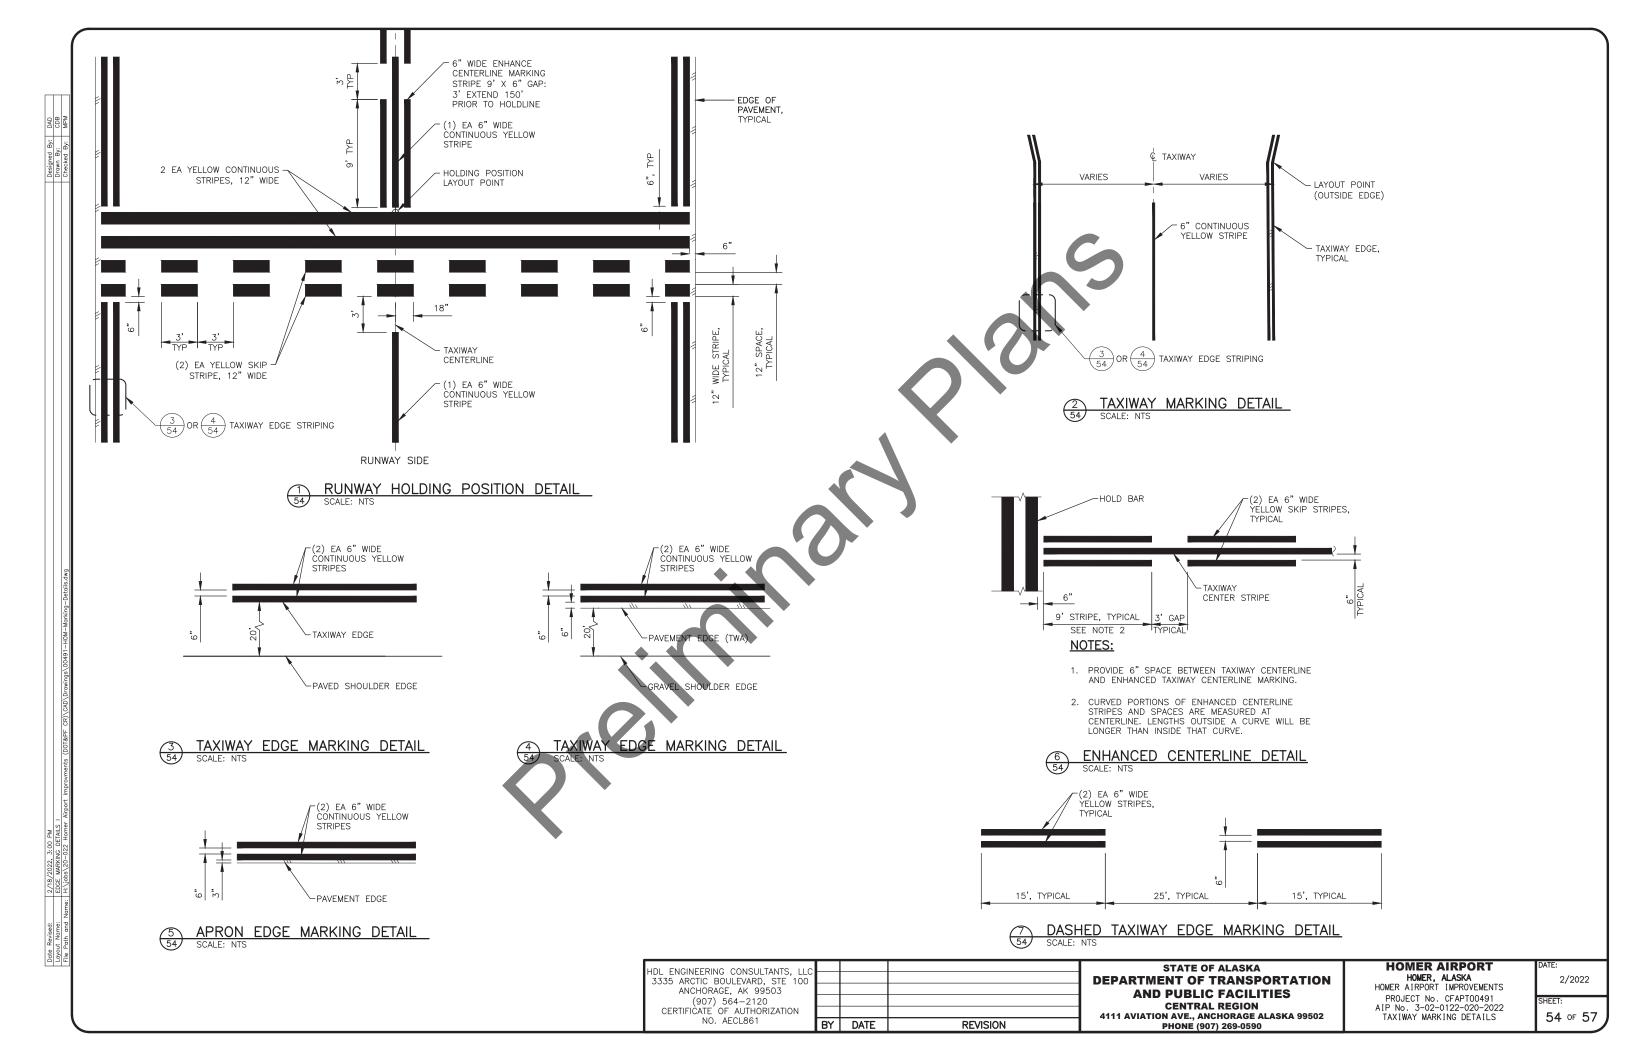

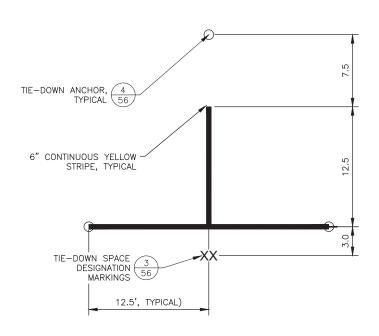


TIE-DOWN MARKING TYPE 1
SCALE: NTS



- TEMPLATES.
- 2. SEE PLAN SHEETS FOR ACTUAL CHARACTERS FOR EACH

TIE-DOWN SPACE DESIGNATION MARKINGS

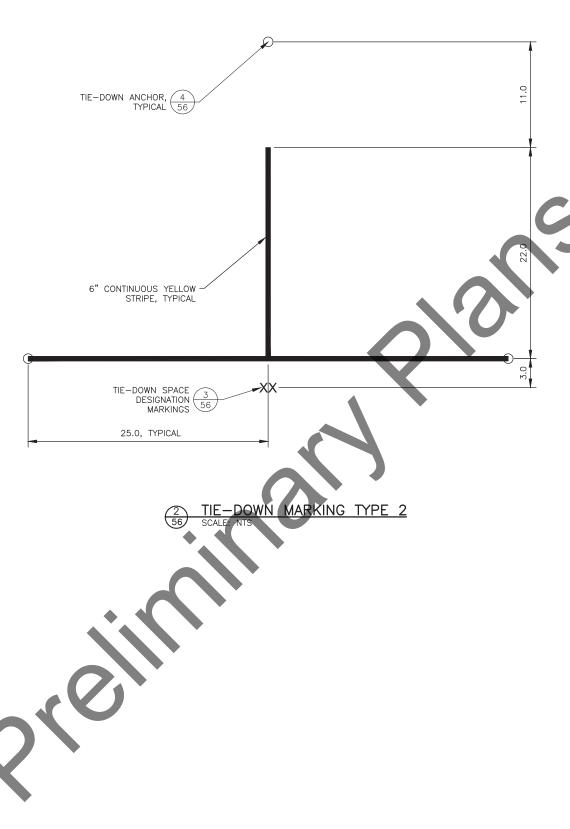

5/8" GALVANIZED STEEL NUT--5/8" GALVANIZED FLAT WASHER 3'-0" MAXIMUM

5/8" SCREW PIN SHACKLE-

NOTE:

- CONTRACTOR SHALL REMOVE THE EXISTING TIE—DOWN CABLE AND CHAINS A MINIMUM OF 18—INCHES BELOW EXISTING GRADE.
- TIE-DOWN ANCHOR DETAIL

HDL ENGINEERING CONSULTANTS, LLC 3335 ARCTIC BOULEVARD, STE 100 ANCHORAGE, AK 99503 (907) 564-2120 CERTIFICATE OF AUTHORIZATION NO. AECL861

STATE OF ALASKA **AND PUBLIC FACILITIES CENTRAL REGION**

HOMER AIRPORT

-3/8" REMOVAL COUPLING LINK

2" HMA, TYPE II, CLASS A

-3/8" GALVANIZED

-3/8" REMOVAL COUPLING LINK _5/8" GALVANIZED DROP-FORGED EYE BOLT

X 2' X 1/4" GALVANIZED STEEL PLATE

4" RAP, SEE APRON TYPICAL SECTIONS

STEEL CHAIN

-SUITABLE MATERIAL

HOMER, ALASKA HOMER AIRPORT IMPROVEMENTS **DEPARTMENT OF TRANSPORTATION** 2/2022 PROJECT No. CFAPT00491 AIP No. 3-02-0122-020-2022 HEET: 4111 AVIATION AVE., ANCHORAGE ALASKA 99502 PHONE (907) 269-0590 TIE-DOWN MARKING DETAILS 56 of 57 BY DATE **REVISION**

NOTES: 1. TOP OF CONCRETE SIGN BASE SHALL BE FLUSH WITH ADJACENT GRADE. 2. SIGN HEIGHT SHALL NOT EXCEED 30" ABOVE CONCRETE SIGN BASE. 72" 8.5" 8.5" TYP TYP LAYOUT POINT -SIGN MOUNTING HARDWARE -PROVIDE 1/2" - 13x5/8" DROP-IN-STYLE CONCRETE ANCHORS, TYP -MOUND TOP OF CONCRETE TO DRAIN EXISTING GROUND EXISTING GROUND TETHER, ONE PER LEG CONNECT TO SLAB WITH 32.0" FRANGIBLE COUPLING, TYP--8" CONCRETE SIGN BASE, CENTER SIGN ON BASE -4" CRUSHED AGGREGATE BASE COURSE 92" SIDE VIEW FRONT VIEW TAXIWAY ENDING MARKER SCALE: NTS "D" STA 5+13.5, 52.5 RT "D" STA 18+24, 15.5 RT **HOMER AIRPORT** HDL ENGINEERING CONSULTANTS, LLC 3335 ARCTIC BOULEVARD, STE 100 ANCHORAGE, AK 99503 (907) 564-2120 CERTIFICATE OF AUTHORIZATION STATE OF ALASKA HOMER, ALASKA HOMER AIRPORT IMPROVEMENTS **DEPARTMENT OF TRANSPORTATION** 2/2022 AND PUBLIC FACILITIES PROJECT No. CFAPT00491 AIP No. 3-02-0122-020-2022 CLOSURE MARKER DETAILS **CENTRAL REGION** 4111 AVIATION AVE., ANCHORAGE ALASKA 99502 PHONE (907) 269-0590 57 of 57 NO. AECL861 BY DATE REVISION

	LEGEND:		
EXISTING	DEMOLITION	<u>NEW</u>	
			2" HDPE CONDUIT. HASH MARKS INDICATE NUMBER OF NEW #8 AWG. 5KV AIRPORT CABLES, TYPE "C", PLUS ONE #6 BARE COPPER GROUND CONDUCTOR.
			2" HDPE CONDUIT, IN 4" RSC SLEEVE. HASH MARKS INDICATE NUMBER OF NEW #8 AWG. 5KV AIRPORT CABLES, TYPE "C", PLUS ONE #6 BARE COPPER GROUND CONDUCTOR.
\circ	×	RG	THRESHOLD LIGHT, GREEN/RED
\circ	×	\mathbf{w}_{A}	RUNWAY EDGE LIGHT, WHITE/YELLOW
\circ	× ×	Φ	RUNWAY EDGE LIGHT, WHITE/WHITE
\circ	×	W	RUNWAY EDGE LIGHT, WHITE/YELLOW, FLUSH
\circ	×	♦	RUNWAY EDGE LIGHT, WHITE/WHITE, FLUSH
lack	×	8	TAXIWAY EDGE LIGHT
$^{\otimes}$	× ×		TAXIWAY EDGE LIGHT, FLUSH
\bigcirc	×		HANDHOLE, L-867
只	\bowtie	=	ELEVATED RUNWAY GUARD LIGHT, L-804
	X		LIGHTED AIRPORT SIGN
	R		WIND CONE, L-806 OR L-807
		•	CONCRETE HANDHOLE
	M	3	CONCRETE MANHOLE
>0€	> o€	>0<	ROTATING BEACON
人	人	人	RADIO CONTROLLER ANTENNA
Œ	選	€	FAA THRESHOLD LIGHT
0	*	0	FAA VASI
		∞	DRYWELL
		∇	3/4" X 10' COPPER COATED GROUND ROD
		RXXX	LIGHT OR HANDHOLE NUMBER "X" — SEE SCHEDULE
		×	SIGN NUMBER "X" — SEE SCHEDULE
		00	TEMPORARY RUNWAY EDGE LIGHT, SEE CSPP
		B	TEMPORARY TAXIWAY EDGE LIGHT, SEE CSPP
		•	TEMPORARY THRESHOLD LIGHT, SEE CSPP
—— UE——		——UE——	UNDERGROUND ELECTRIC
UGT			UNDERGROUND COMM

ABBREVIATIONS:

AMERICAN WIRE GAUGE BARE COPPER GROUND BCU CONDUIT CRUSHED BASE AGGREGATE COURSE CONSTANT CURRENT REGULATOR
CONSTRUCTION SAFETY AND PHASING PLAN CCR CSPP CABC CRUSHED AGGREGATE BASE COURSE DEB DEG DIRECT EARTH BURY DEGREES EXISTING TO REMAIN FAA FT FEDERAL AVIATION ADMINISTRATION HDPE HIGH DENSITY POLYETHYLENE HIRL HIGH INTENSITY RUNWAY LIGHTING IN KV INCH KII OVOI T KILOWATT KW LED LIGHT EMITTING DIODE

LIQUIDTIGHT FLEXIBLE METAL CONDUIT
NATIONALLY RECOGNIZED TESTING LABORAT LEMC NRTL MAXIMUM MIN MINIMUM MEDIUM INTENSITY RUNWAY LIGHTING

ON CENTER UNLESS OTHERWISE NOTED PCT PERCENT

PRIMARY PRI RSC RIGID STEEL CONDUIT RW RUNWAY

RW(X)RW CIRCUIT OF CONDUCTORS SERIES CUI

SCÓ STA STATION TH THRESHOL TOC TOP OF CON

TW(X)TW CIRCUIT, NU IN () INDICATES # OF CONDUCTORS TW TAXIWAY

TYP **TYPICAI**

MIRL

VASI APPROACH SLOPE INDICATOR

XFMR TRANSFORMER

ELECTRICAL SHEET INDEX:

IGHTING DEMOLITION PLANS IGHTING NOTES

RUNWAY AND TAXIWAY LIGHTING PLANS

LARGE SCALE PLANS 22-F26 DETAILS -E30 SCHEDULES

DEMOLITION GENERAL NOTES:

- 1. DECOMMISSIONED CONDUIT, CONDUCTORS, AND GROUND WIRES IN RACEWAY SHALL BE REMOVED. ABANDONED WIRING AND CONDUIT RUNS EXPOSED DURING EXCAVATION SHALL BE REMOVED. THIS WORK SHALL BE SUBSIDIARY TO EXCAVATION AND NO SEPARATE PAYMENT WILL BE MADE.
- 2. THE CONTRACTOR SHALL RESTORE GRADE AND FINISH SURFACES DISTURBED BY THE REMOVAL OF STRUCTURES. THIS WORK SHALL BE SUBSIDIARY TO THE CONTRACT AND NO SEPARATE PAYMENT WILL BE MADE.
- 3. DEMOLISHED SIGNS, FIXTURES, AND TRANSFORMERS SHALL BE SALVAGED AND OFFERED TO DOT MAINTENANCE. EQUIPMENT DEEMED OF NO SALVAGE VALUE BY DOT MAINTENANCE PERSONNEL, AND ALL OTHER EQUIPMENT AND MATERIALS NOT LISTED ABOVE, INCLUDING LIGHT BASES, HANDHOLES, SIGN BASES, WIRE, AND RACEWAYS, SHALL BECOME THE PROPERTY OF THE CONTRACTOR AND SHALL BE DISPOSED OF IN ACCORDANCE WITH FEDERAL, STATE, AND LOCAL STATUTES.
- 4. REMOVAL OF EXISTING CONDUCTORS AND GROUND WIRE SHALL BE SUBSIDIARY TO THE REMOVAL OF THE ASSOCIATED EQUIPMENT AND NO SEPARATE PAYMENT WILL BE
- 5. LOCATE EXISTING UNDERGROUND UTILITIES PRIOR TO COMMENCING WORK.

DEMOLITION SHEET NOTES:

- REMOVE RUNWAY EDGE LIGHTS, THRESHOLD LIGHTS, TAXIWAY LIGHTS, BASES, TRANSFORMERS, CONDUIT, AND WIRING.
- $\langle 2 \rangle$ REMOVE EXISTING SIGN, CONCRETE BASE, CONDUIT, AND CONDUCTORS.
- 3 SALVAGE FOR RE-INSTALLATION.

PLANS DEVELOPED BY: MBA CONSULTING ENGINEERS, INC. 3812 SPENARD RD. ANCHORAGE, AK 99517 (907) 274-2622 REVISION CERT. OF AUTH. NO. AECC578 BY DATE

STATE OF ALASKA **DEPARTMENT OF TRANSPORTATION AND PUBLIC FACILITIES CENTRAL REGION** 4111 AVIATION AVE., ANCHORAGE ALASKA 99502


PHONE (907) 269-0590


HOMER AIRPORT HOMER, ALASKA AIRPORT IMPROVEMENTS PROJECT No. CFAPTOO491


AIP No. 3-02-0122-020-2022 LEGEND AND NOTES


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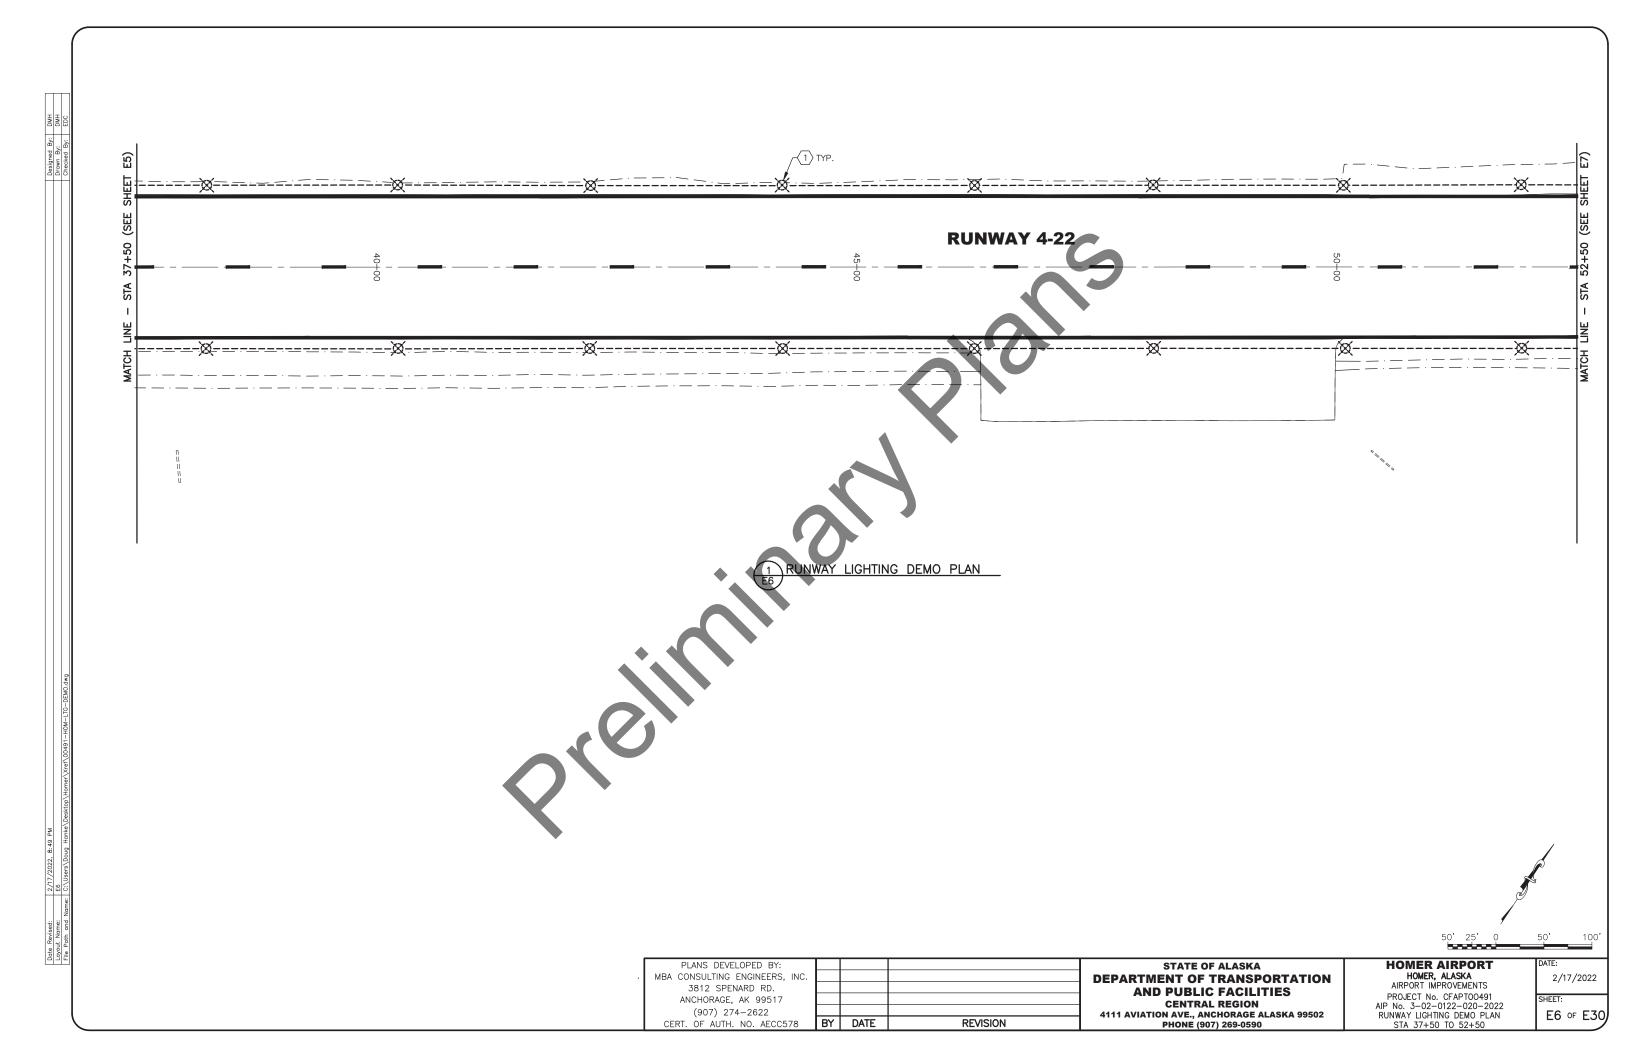
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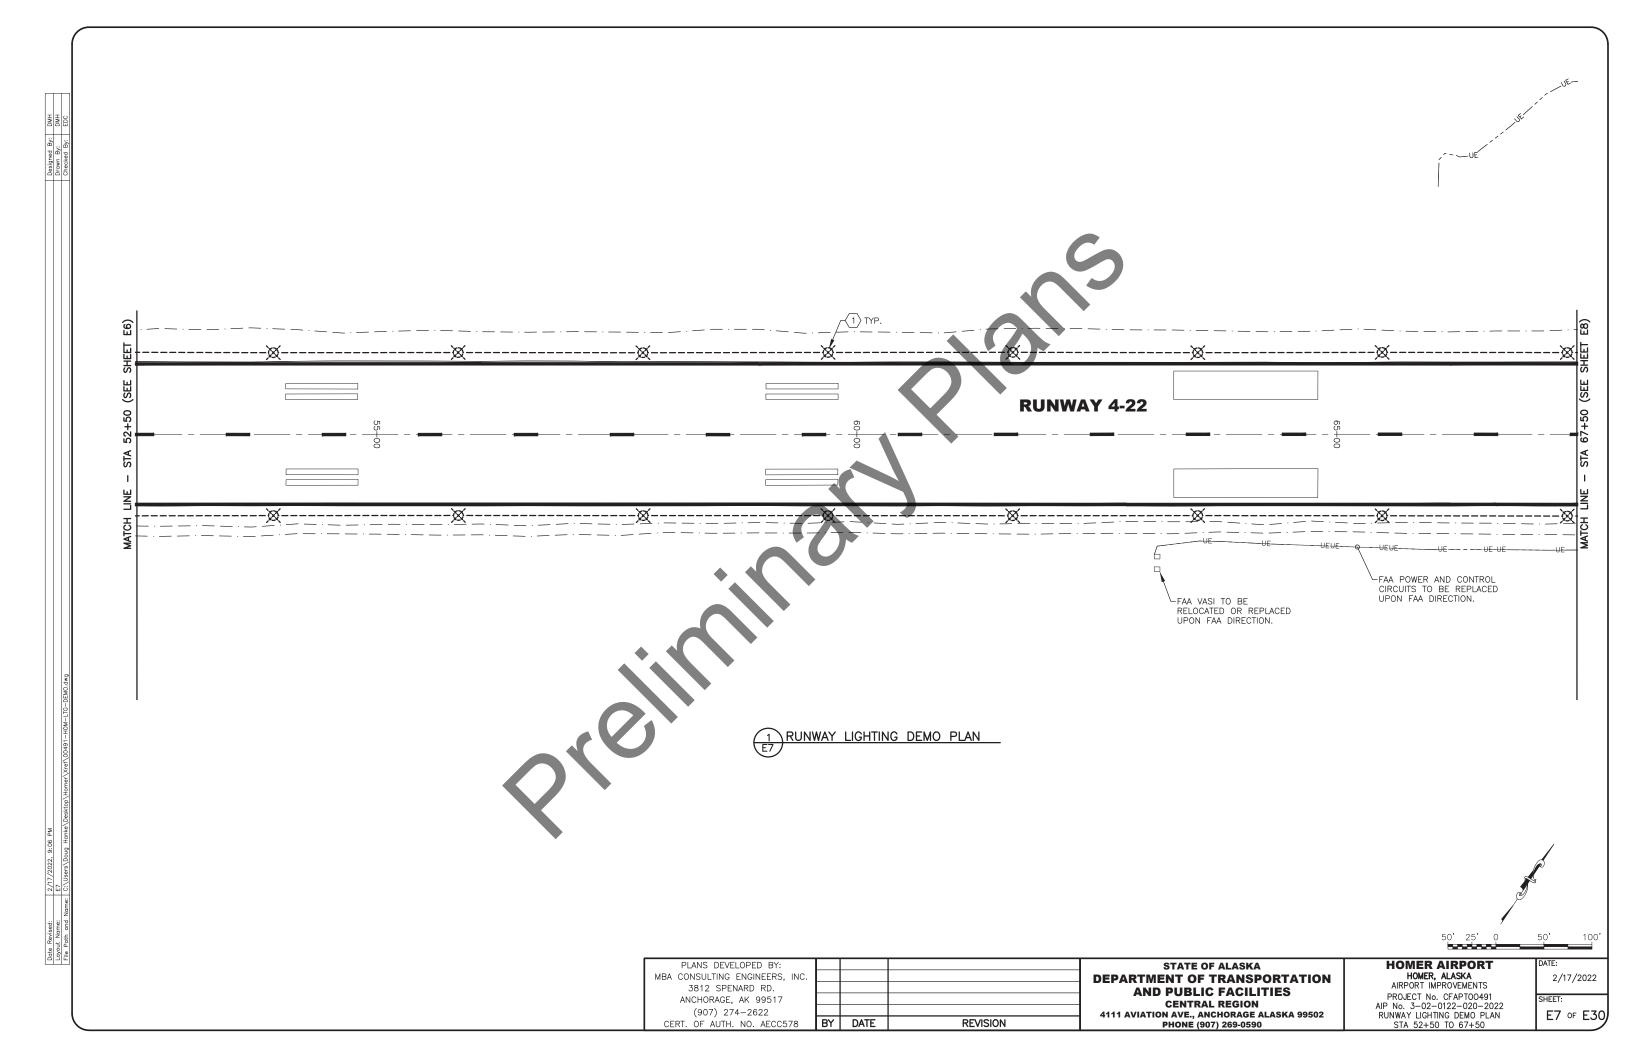





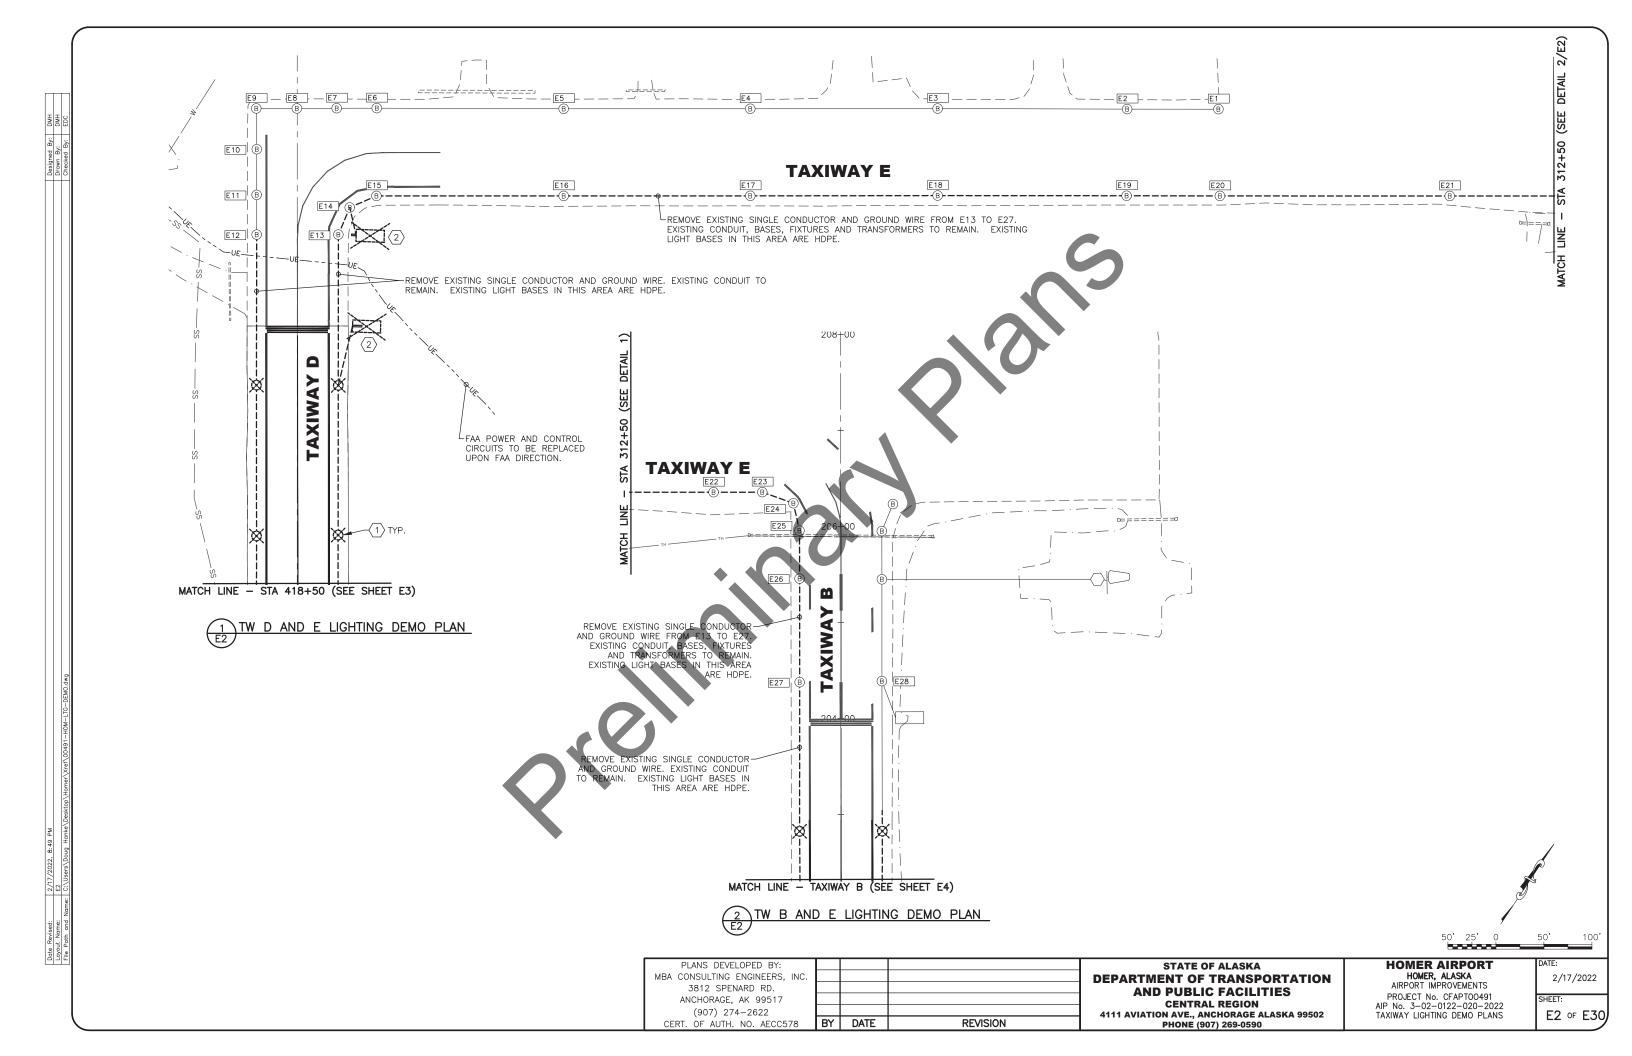

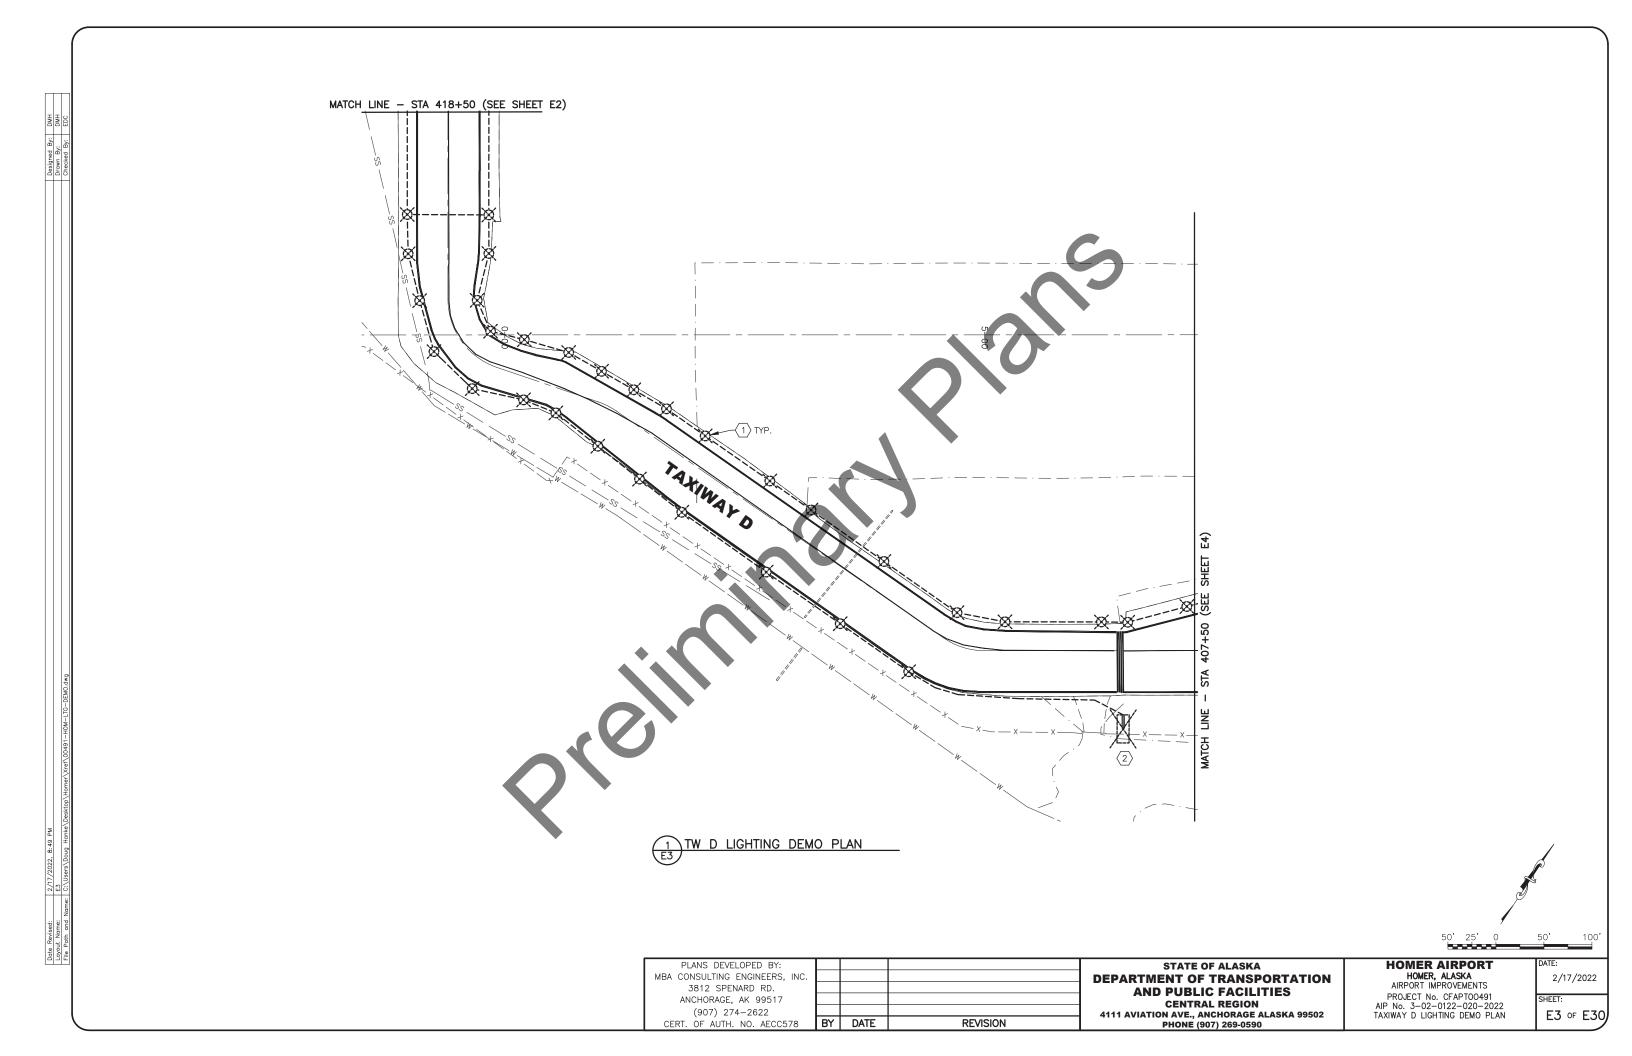

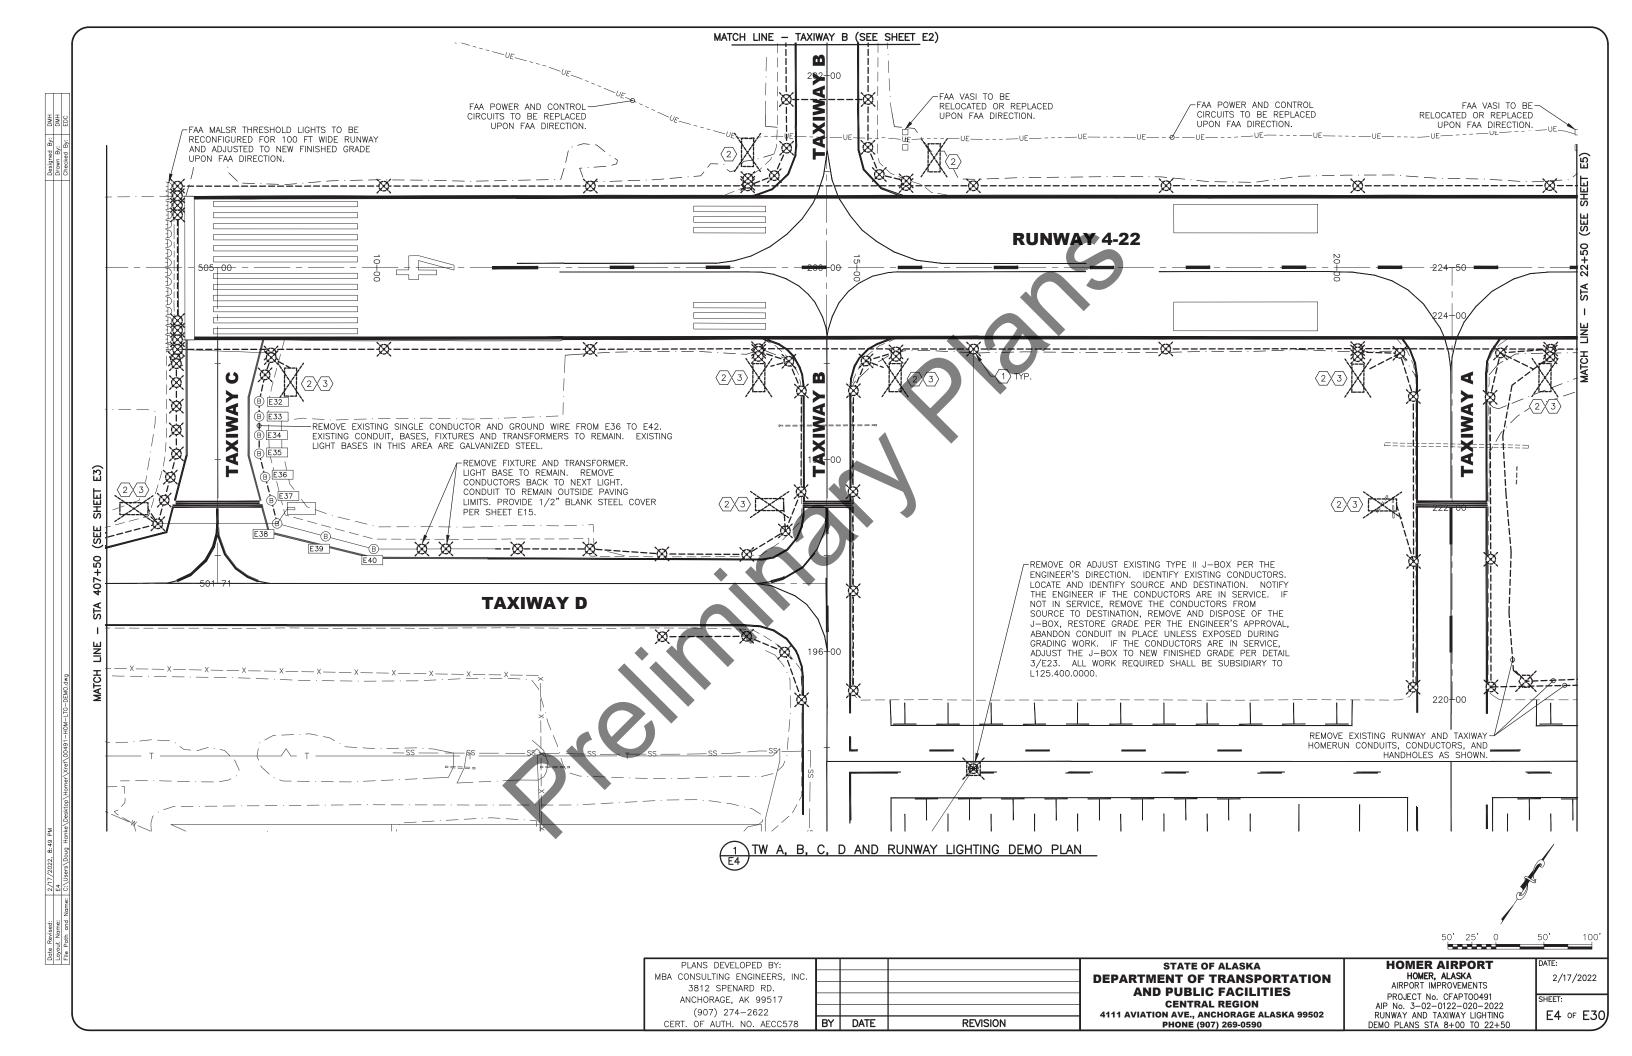

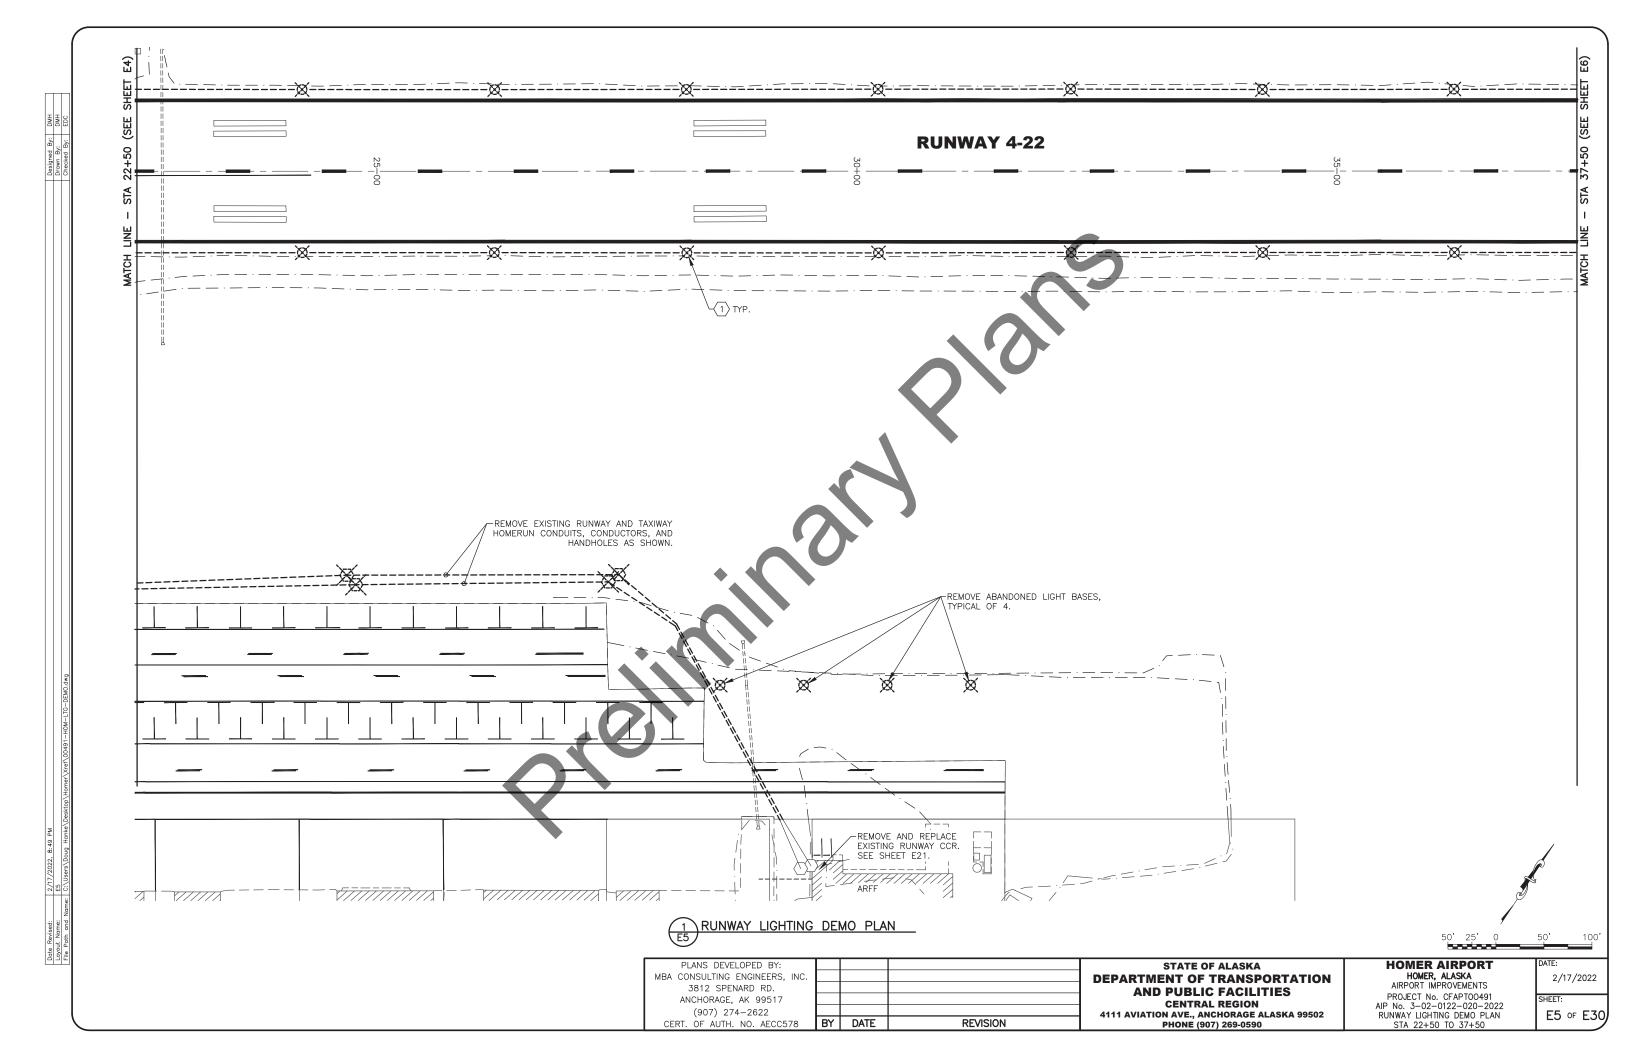

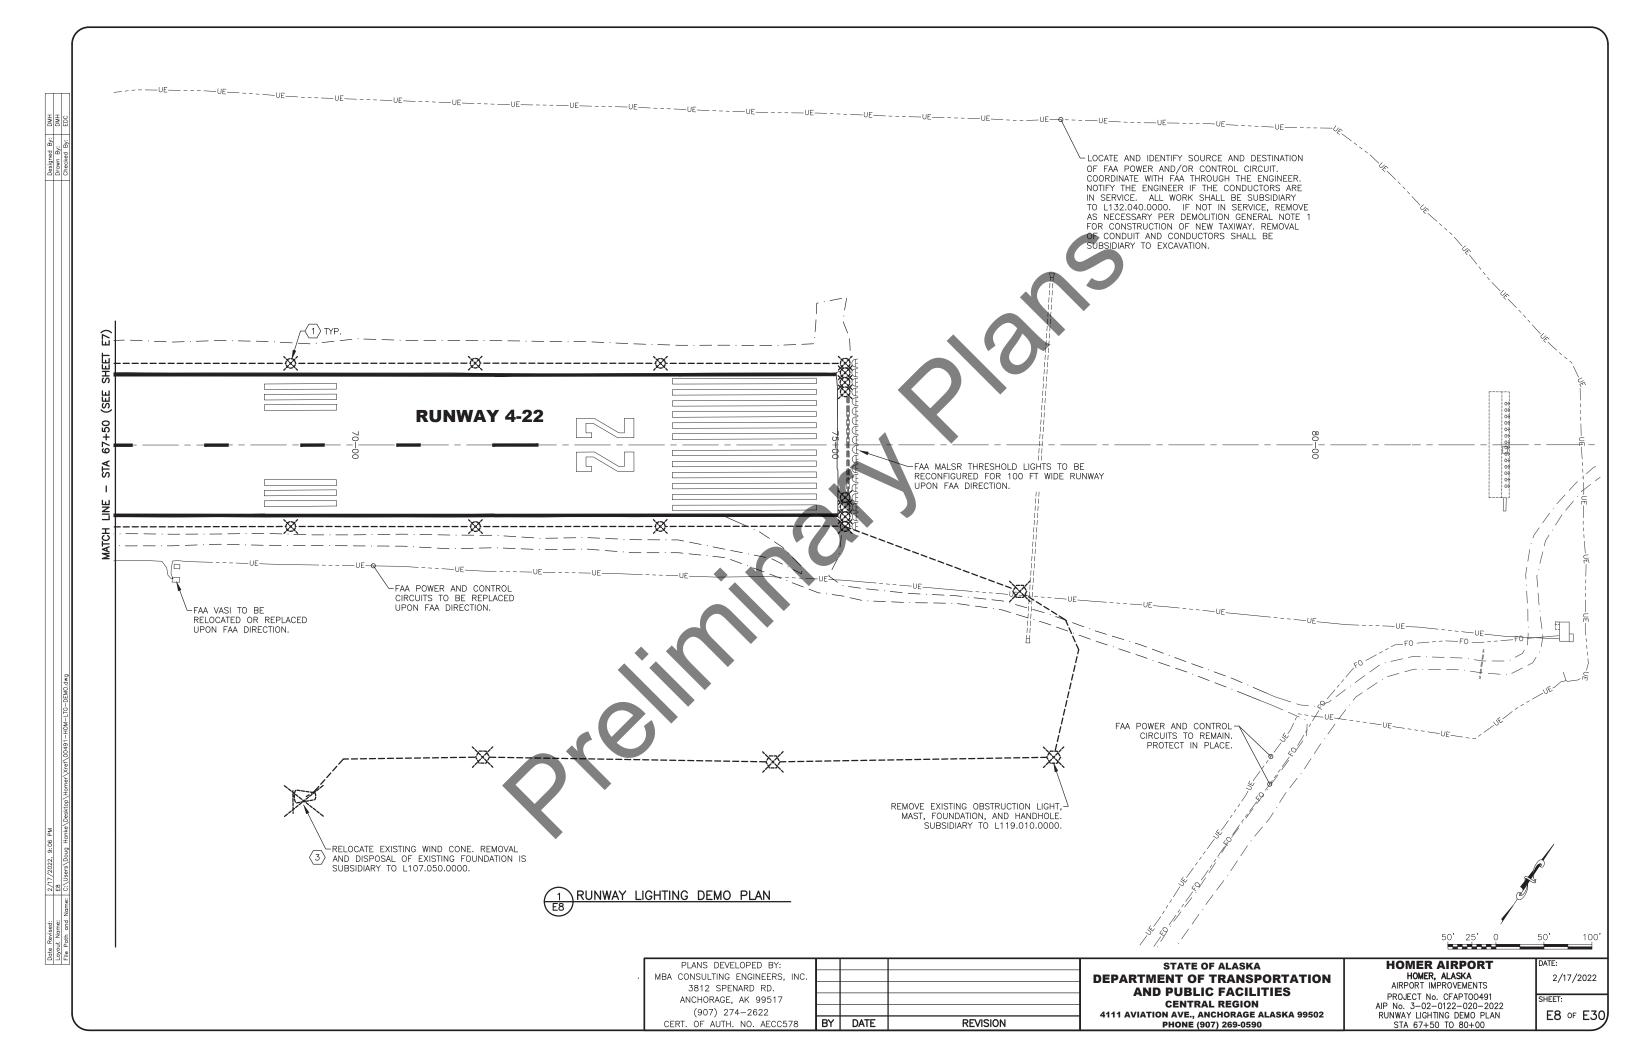

PANEL: A2A (EXISTING)									
PROJECT: HOMER AIRPORT			iccei	2 100	п	SUBFEED BKR			
LOCATION: ARFF ELEC ROOM LUGS E	SLIDE	SHM.	T TRP	П	ISO GRND BAR				
CB C	,]	FLSH	ā		LGS		SOLID NEUTRAL [
208/120 VOLTS	, 3 PH		WIRE			AMP	10000 AIC		
2007 120 40210	0 111		THILL		100	7 (1911	10000 7110		
CIRCUIT DESCRIPTION	KVA	AMP	CKT	CKT	AMP	KVA	CIRCUIT DESCRIPTION		
AIRFIELD LIGHTING CONTROL PANEL	0.1	20/1	1	2	200/				
AIRFIELD RADIO	0.1	20/1		4	/	37.08	PANEL A2B, BOILER 203		
RW 22 OBSTRUCTION LIGHT (1)	0.1	20/1	5	6	/3		·		
SPACE			7	8	200/				
		30/	9	10		28.13	PANEL A2C, ELECTRICAL 109C		
DRYER, VEHICLE STORAGE 109	6.4		11	12	/3				
		/3	13	14	60/				
RECEPTACLE, 109A	0.36	20/1	15	16		4.16	GENERATOR PANEL A2G		
SPACE			17	18	/3				
GATE MOTOR	6.34	20/	19	20	50/		50 AMP ELECTRICAL WELDER		
		/2	21	22		14.4	NEMA 14-30R, WELD/WORK BENCH		
SECURITY GATE CONTROL	0.2	20/1	23	24	/3		109A		
WATER RESCUE TRAILER, VEHICLE		50/	25	26	30/		30 AMP ELECTRICAL WELDER NEMA		
STORAGE 109	14.4		27	28		9.0	18-30R, WELD/WORK BENCH 109A		
		/3	29	30	/3				
GAS FUEL TANK PUMP		20/1	31		20/1		WELDER NEMA 5-20R, 109A		
DIESEL FUEL TANK PUMP		20/1			20/1	0.3	FUME HOOD LIGHTING, 109A		
TP-1, TOILET 105		15/1		36			SPACE		
TP-2A, FIRE PUMP 107	0.028	20/1	37	38			SPACE		
SPACE			39	40			SPACE		
SPACE			41	42			SPACE		
SPACE			43	44			SPACE		
SPACE			45	46			SPACE		
SPACE		L	47	48			SPACE		
CONNECTED LOAD: XX	KVA	XX	A		ARKS:				
DEMAND LOAD: XX	KVA	XX	A	(1)	NEW C	B, NEW	LOAD		
DEMAND + CONT. XX	KVA	XX	Α	-					
DATE:									

PANEL: A4C								
PROJECT: HOMER AIRPORT	THRUFEED LGS O						SUBFEED BKR	
LOCATION: ARFF ELEC ROOM LUGS [SHNT TRP		ISO GRND BAR
100 (077) (0170	CB □		FLSH		SBFD LGS			SOLID NEUTRAL
480/277 VOLTS		3 PH	4	WIRE	100 AMP			14000 AIC
CIRCUIT DESCRIPTION		KVA	AMP	CKT	CKT	AMP	KVA	CIRCUIT DESCRIPTION
TAXIWAY CONSTANT CURRENT		10.56	1.43	1	2	20/1	1.19	LIGHTING, 203, 204, 201, 202
REGULATOR, ELECTRICAL 108			/2	3	4	20/1	0.588	SECOND FLOOR EXTERIOR LIGHTING
RUNWAY CONSTANT CURRENT		10.56	30/	5	6	20/1	0.174	FIRST FLOOR EXTERIOR LIGHTING
REGULATOR, ELECTRICAL 108	(1)		/2	7	8			SPACE
ZONE ONE LIGHTING, 109		1.43	20/1	9	10	20/1	1.76	LIGHTING
ZONE TWO LIGHTING, 109		1.42	20/1	11	12			SPACE
ZONE THREE LIGHTING, 109		1.43	20/1	13	14			SPACE
SPACE				15	16			SPACE
SPACE				17	18			SPACE
SPACE				19	20			SPACE
SPACE				21	22			SPACE
SPACE				23	24			SPACE
CONNECTED LOAD:	XX	KVA	XX	Α	REM	ARKS:		
DEMAND LOAD: XX			XX	Α	(1)	REPLA	CE EXIST	TING 60/2 CB WITH NEW 30/2 CB
DEMAND + CONT.	XX	KVA	XX	Α				
DATE:								
REV:								

SHEET NOTES:

- CONNECT NEW CONDUIT TO EXISTING JUNCTION BOX, LIGHT BASE, OR HANDHOLE USING LISTED DEVICES. CONNECTION TO EXISTING CONDUIT SHALL
- CONNECT NEW #8 5KV AIRPORT CABLES AND #6 BCU TO EXISTING CONDUCTORS FOR CONTINUATION OF THE CIRCUIT. PROVIDE NEW NEOPRENE GASKET AND SEAL WASHERS.
- , DRYWELL, SEE DETAIL 1/E23. LOCATE OUTSIDE OF PAVED SHOULDER. DRYWELL PAID UNDER ITEM L110.240.0000 AND CONDUIT TO DRYWELL PAID UNDER ITEM L110.080.1002.
- 4 RE-INSTALL EXISTING SIGN ON NEW CONCRETE BASE.
- (5) NEW SIGN ON NEW CONCRETE BASE.
- (6) RE-INSTALL EXISTING SUPPLEMENTAL WIND CONE ON NEW BASE.

GENERAL NOTES:

- 1. CONDUITS AND LIGHT BASES SHALL BE INSTALLED PRIOR TO PLACEMENT OF FINISH COURSE.
- 2. AIRFIELD LIGHTING CABLE SHALL BE #8 AWG, 5kV, FAA TYPE "C" AIRPORT CABLE.
- 3. CONNECT HDPE CONDUIT TO DISSIMILAR CONDUIT USING A LISTED TRANSITION FITTING.
- 4. PROVIDE LIGHT BASES WITH HUB CONFIGURATIONS TO ACCOMMODATE THE LAYOUT AS SHOWN IN THE PLANS. ROUTE CONDUIT FROM POINT TO POINT, IN A STRAIGHT LINE, EXCEPT AS REQUIRED TO AVOID AN OBSTRUCTION.
- 5. ALL BOLTS, NUTS, AND THREADED SURFACES SHALL BE COATED WITH ANTI-SEIZE LUBRICANT PER SPECIFICATIONS.
- 6. ARRANGE THE LIGHTING CIRCUIT TO FLOW CLOCKWISE AROUND THE RUNWAY AND TAXIWAY WITH THE FEMALE CONNECTOR ON THE REGULATOR SIDE OF THE TRANSFORMER. SEE SHEET
 - ALL TRANSFORMER CONNECTIONS SHALL BE MADE ON THE FEED SIDE OF THE SERIES LOOP. RETURN AND LOOP CONDUCTORS SHALL BE CONTINUOUS AND UNSPLICED.
- PROVIDE LIGHTNING PROTECTION COUNTERPOISE FOR ALL RUNWAY AND TAXIWAY LIGHTING CIRCUITS PER DETAIL 6/E24. #6 AWG BARE COPPER WIRE IS PAID UNDER ITEM L108.030.0006, GROUND RODS ARE PAID UNDER ITEM L108.070.0000.
- 9. HAND HOLE LOCATIONS MAY BE FIELD ADJUSTED AS APPROVED BY THE ENGINEER.
- 10. CONDUIT ROUTING SHOWN FOR CLARITY. ROUTE CONDUITS ON SHOULDER. CONDUITS THAT RUN IN CLOSE PROXIMITY MAY BE INSTALLED IN SAME TRENCH.
- 11. CONTRACTOR SHALL PROVIDE A LIST OF PROPOSED SPARE PARTS AND THE COST FOR EACH CATEGORY TO THE ENGINEER FOR REVIEW PRIOR TO PLACING THE ORDER FOR THE PARTS. QUANTITIES SHALL BE REDUCED IF NECESSARY UNTIL THE COSTS ARE WITHIN THE LIMITS OF THE FAA REQUIREMENTS. SEE SECTION L-125 FOR ADDITIONAL INFORMATION.
- 12. EDGE LIGHTS TO REMAIN IN SERVICE OUTSIDE CONSTRUCTION LIMITS, SEE CONSTRUCTION SAFETY AND PHASING PLANS. PROVIDE AND MAINTAIN TEMPORARY JUMPERS AS REQUIRED: #8, 5KV AIRPORT CABLE IN HDPE CONDUIT. SAND BAG 10 FEET ON CENTER WITH 50 LB
- 13. SLOPE CONDUITS TO DRAIN TO LOW SPOT. WHERE SHOWN, INSTALL 2" CONDUIT DRAIN FROM LIGHT BASE OR HANDHOLE TO LOCATION APPROVED BY THE ENGINEER.
- 14. INSTALL 2" CONDUIT DRAINS TO DRYWELL WHERE INDICATED ON THE PLANS OR AS DIRECTED BY THE ENGINEER. CONDUIT SHALL BE PAID UNDER ITEM L110.080.1002, DRYWELL SHALL BE PAID UNDER ITEM L110.240.0000. SEE DETAIL 1/E23 AND SECTION L-110.
- 15. CONDUCTORS OF SEPARATE CIRCUITS SHALL BE IDENTIFIED BY COLORABLE INSULATION. THE COLORS GREEN AND WHITE SHALL NOT BE USED TO IDENTIFY SERIES CIRCUITS. COLOR SHALL RUN COMPLETELY THROUGH INSULATION. RUNWAY = BLACK, TAXIWAY = BLUE.

PLANS DEVELOPED BY: MBA CONSULTING ENGINEERS, INC. 3812 SPENARD RD. ANCHORAGE, AK 99517 (907) 274-2622 CERT. OF AUTH. NO. AECC578 BY DATE

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STATE OF ALASKA **DEPARTMENT OF TRANSPORTATION** AND PUBLIC FACILITIES **CENTRAL REGION** 4111 AVIATION AVE., ANCHORAGE ALASKA 99502


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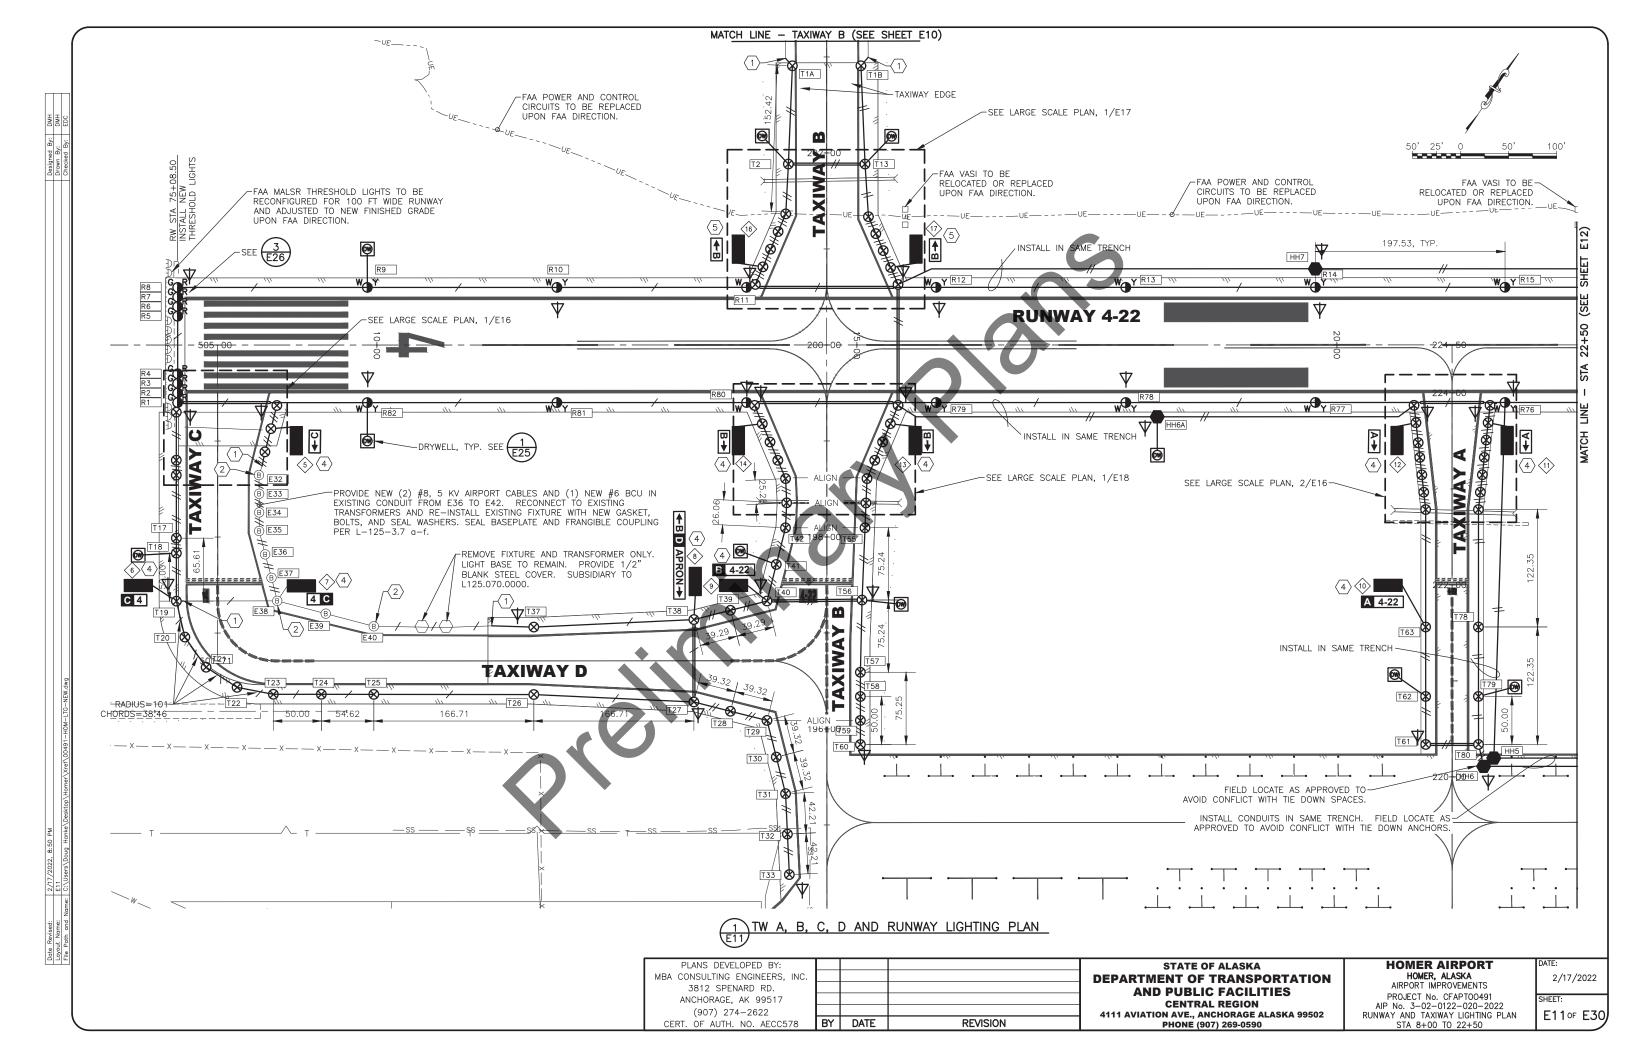
HOMER, ALASKA AIRPORT IMPROVEMENTS PROJECT No. CFAPTOO491 AIP No. 3-02-0122-020-2022 LIGHTING NOTES


HOMER AIRPORT


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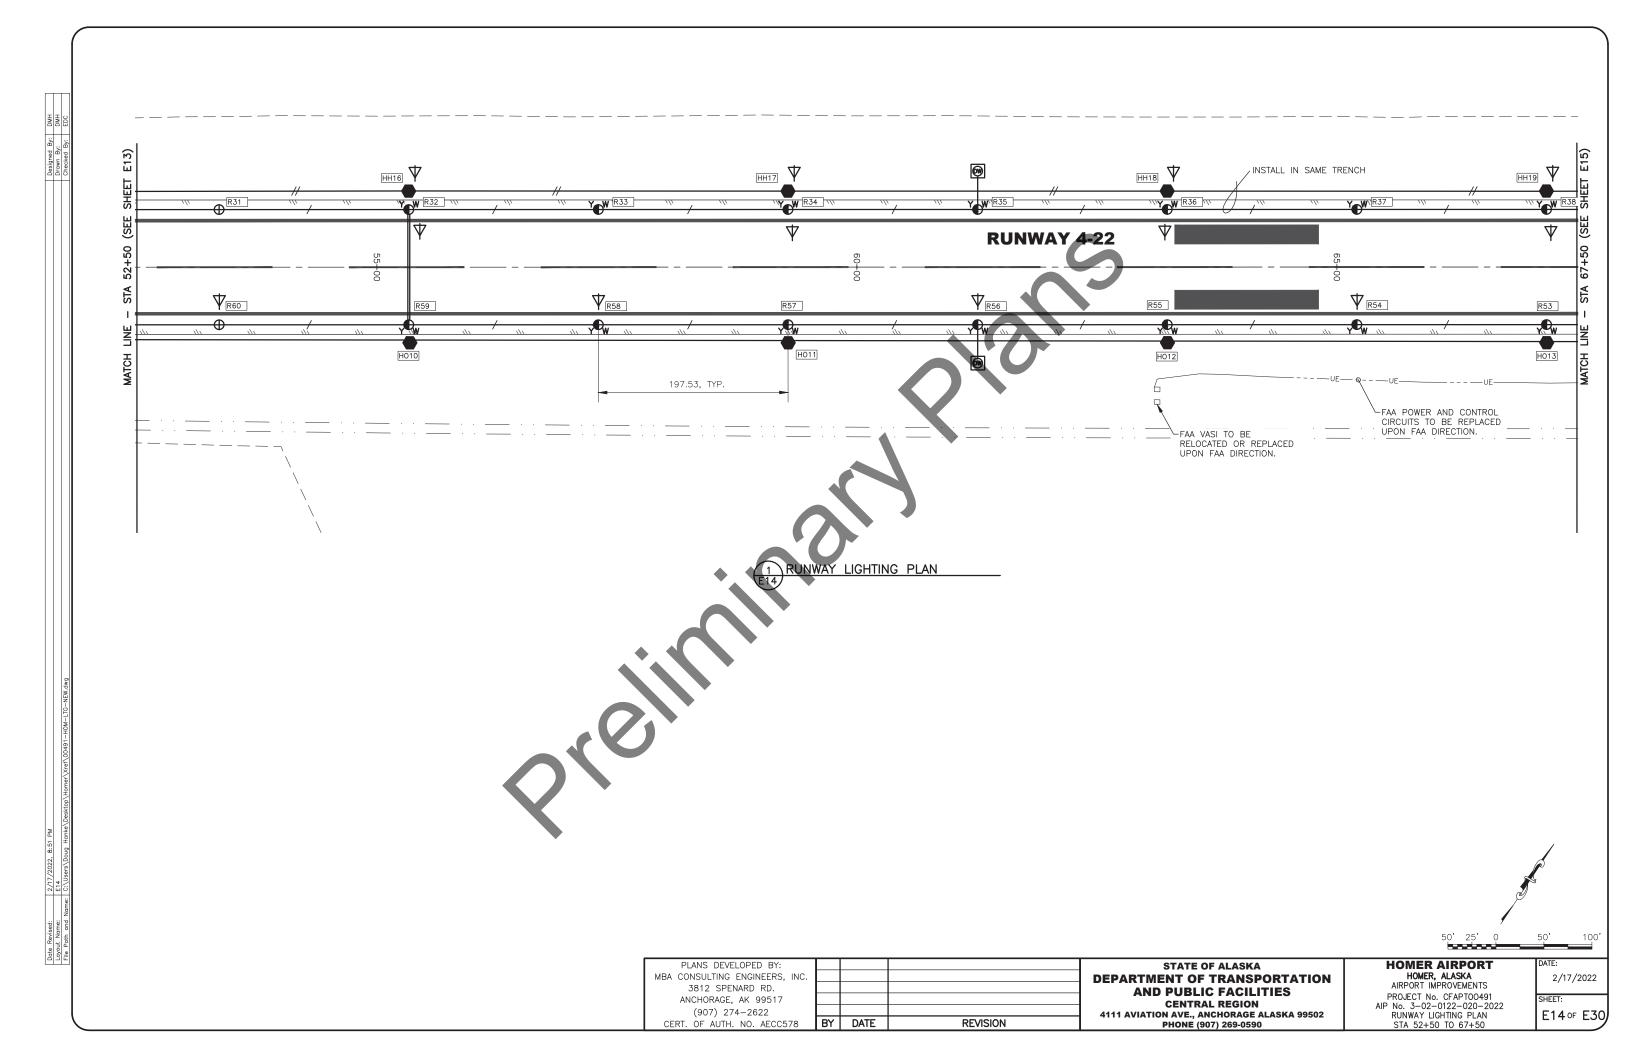
E9 of E30







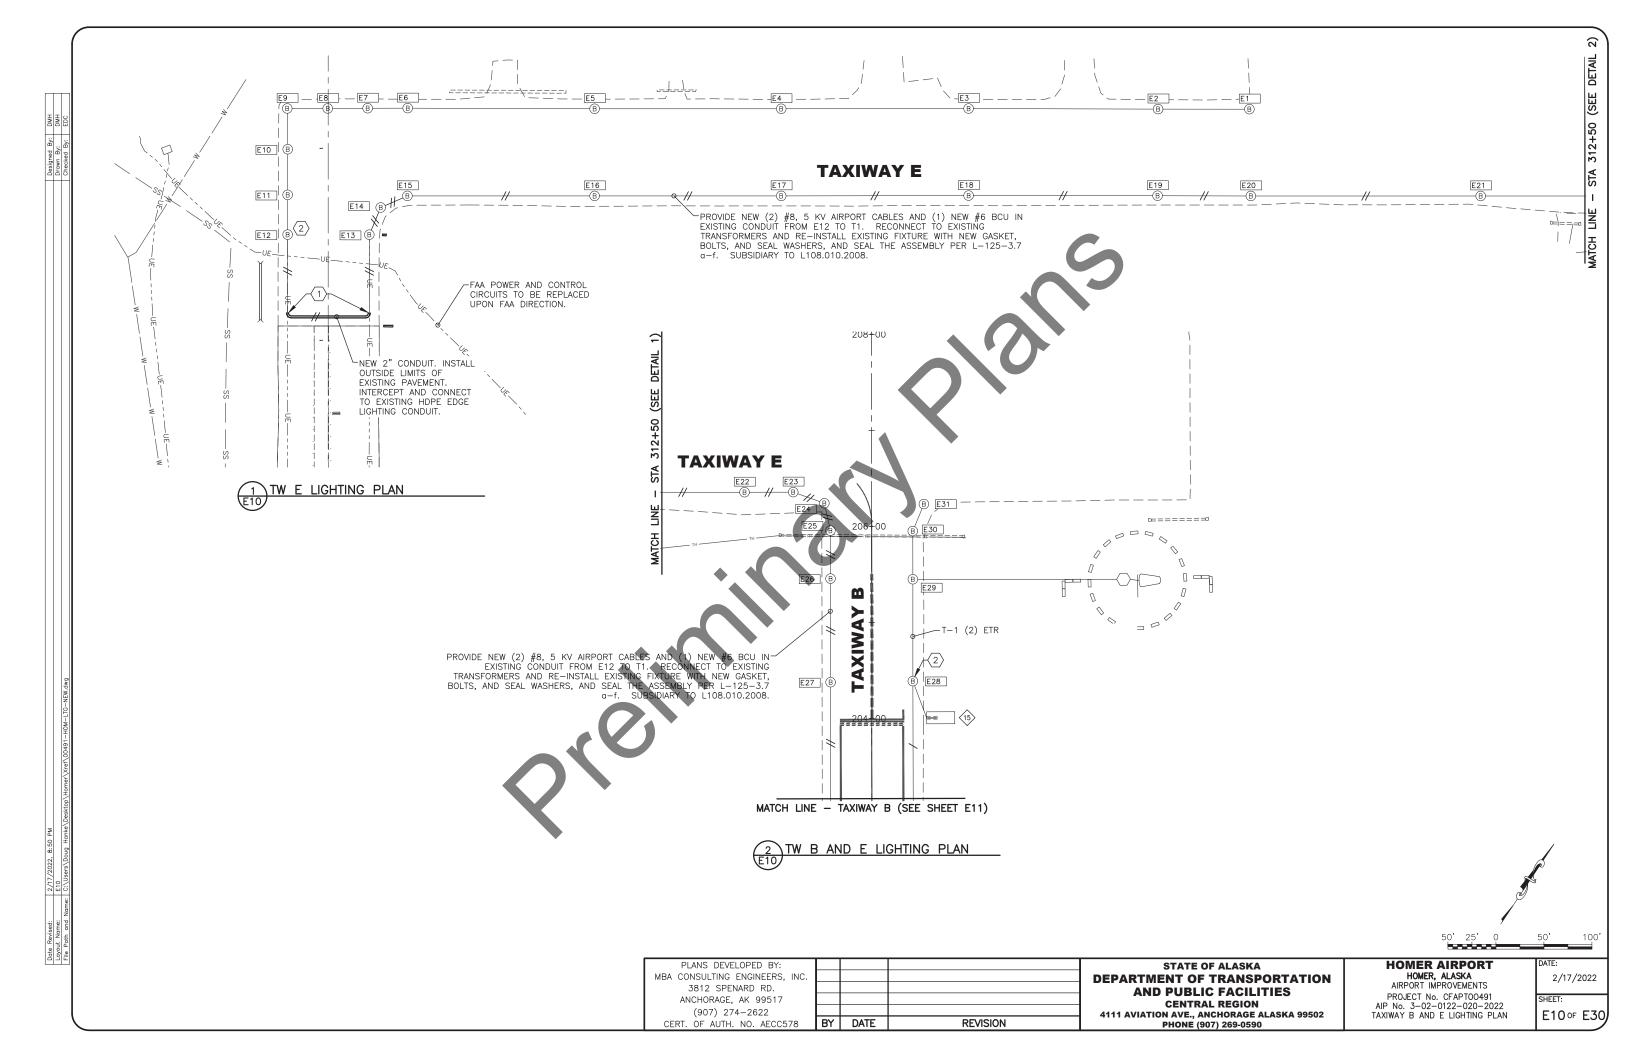


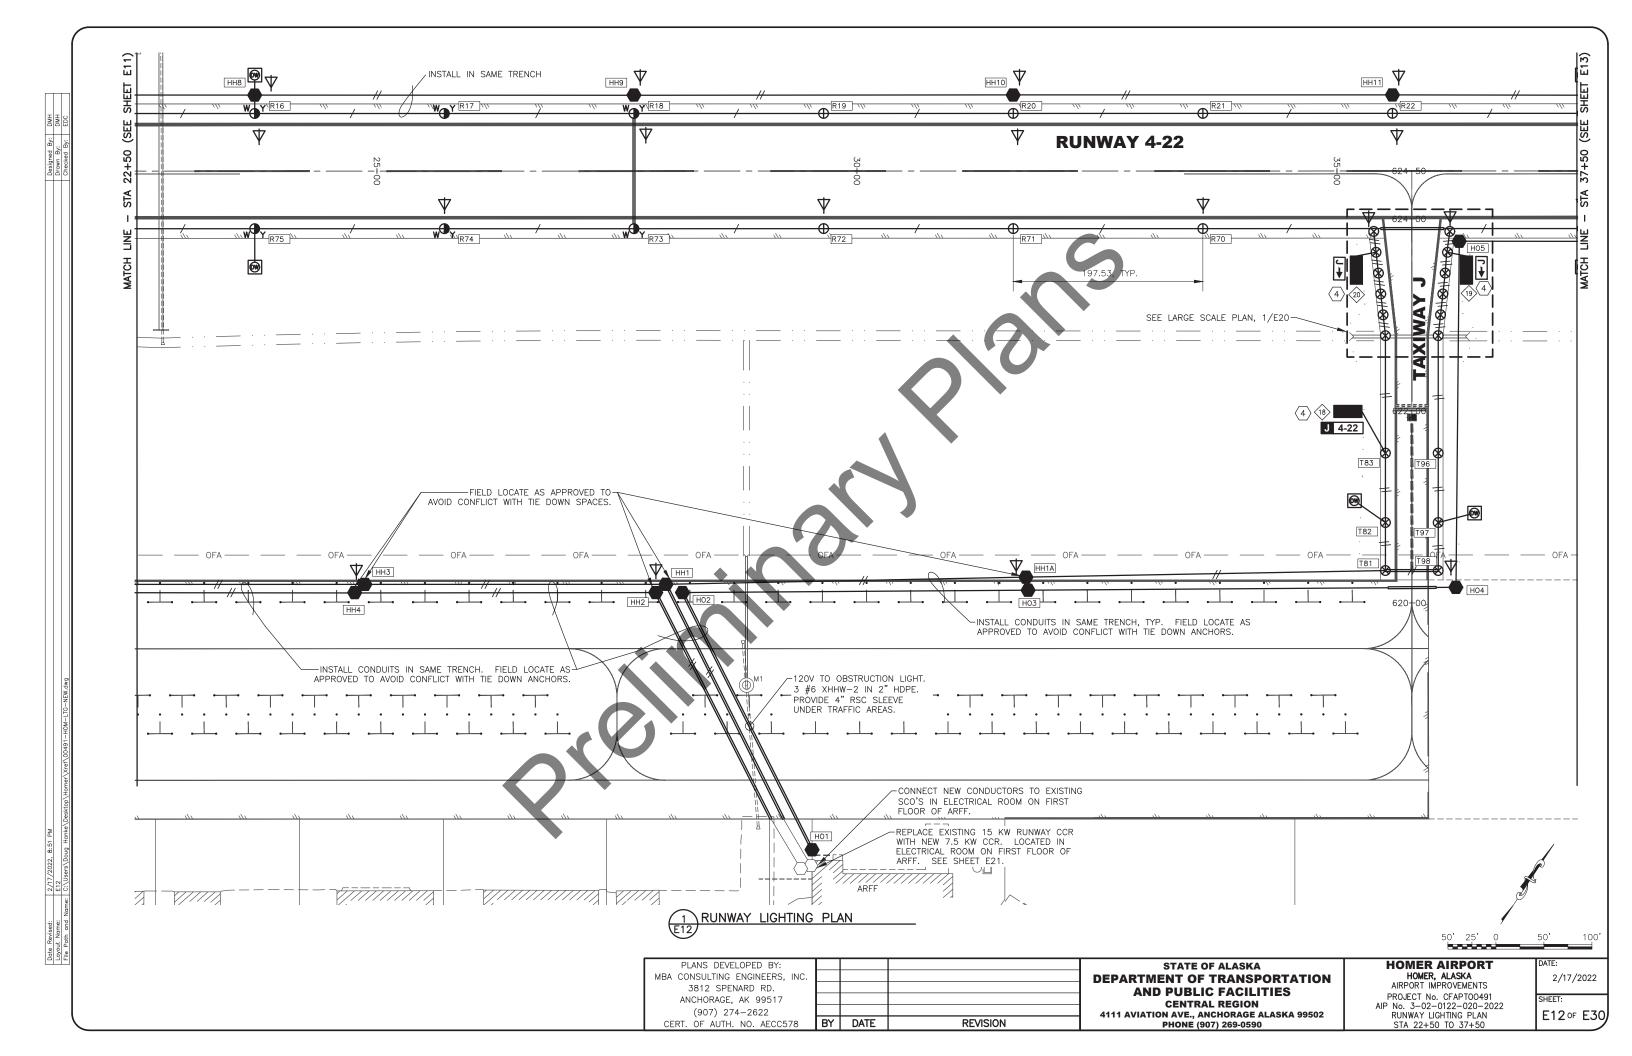


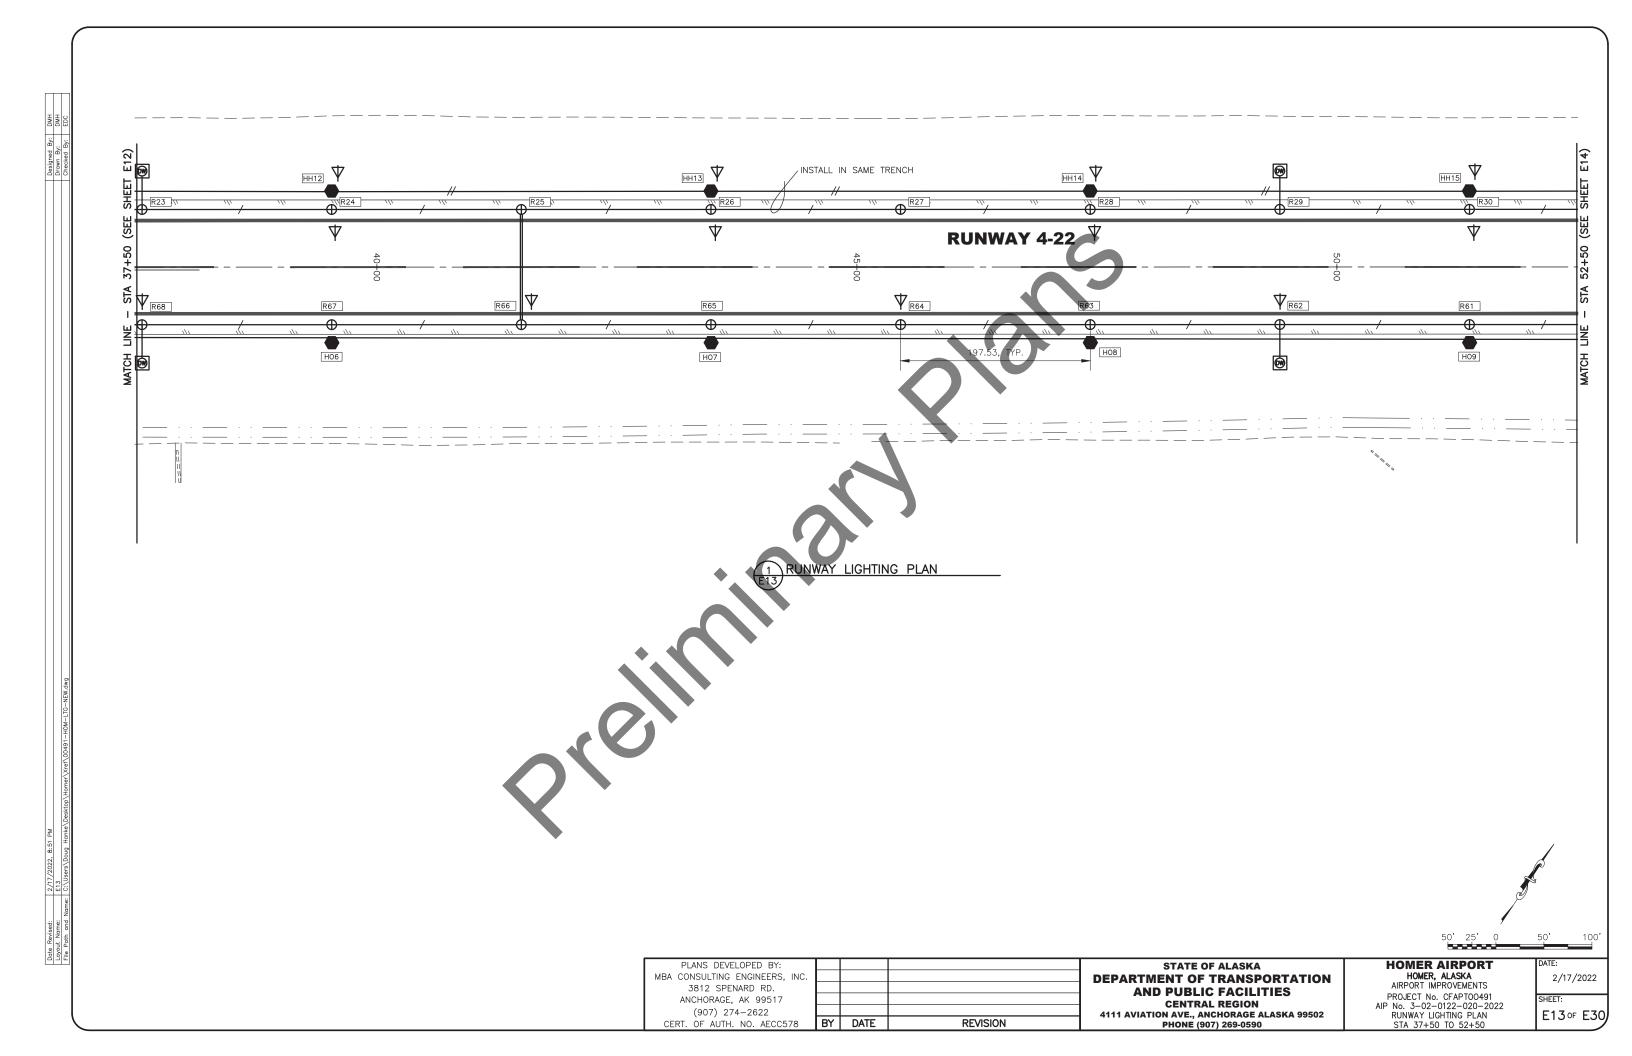


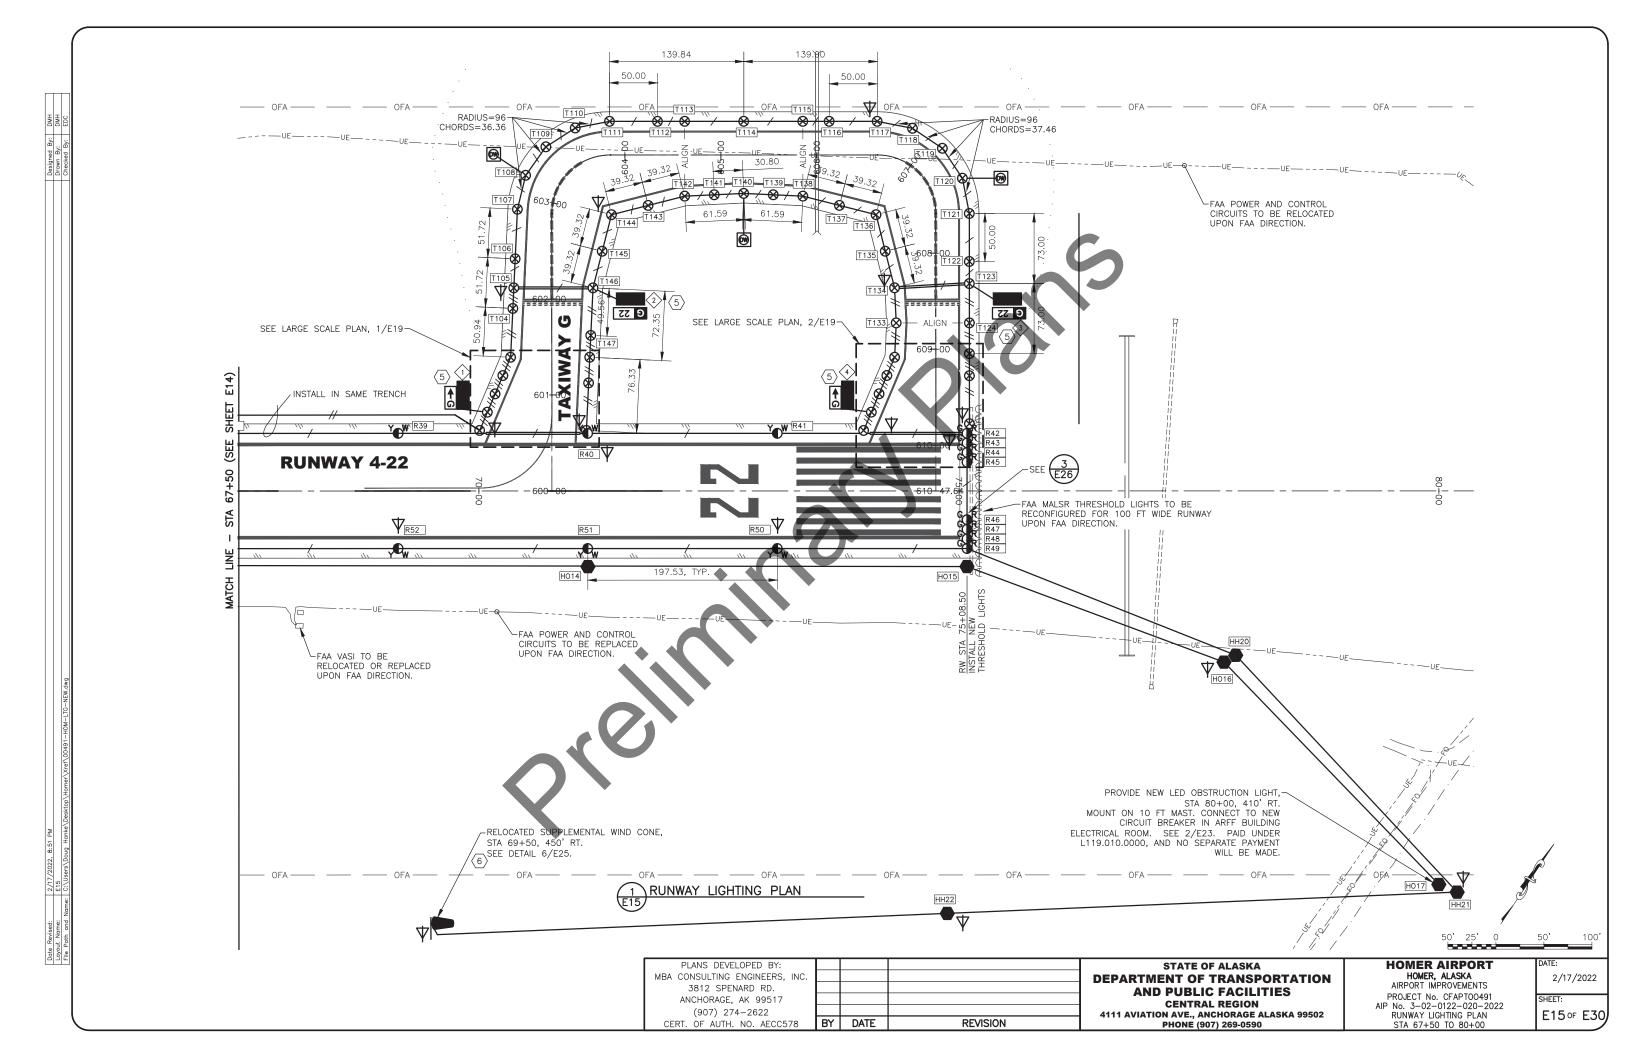


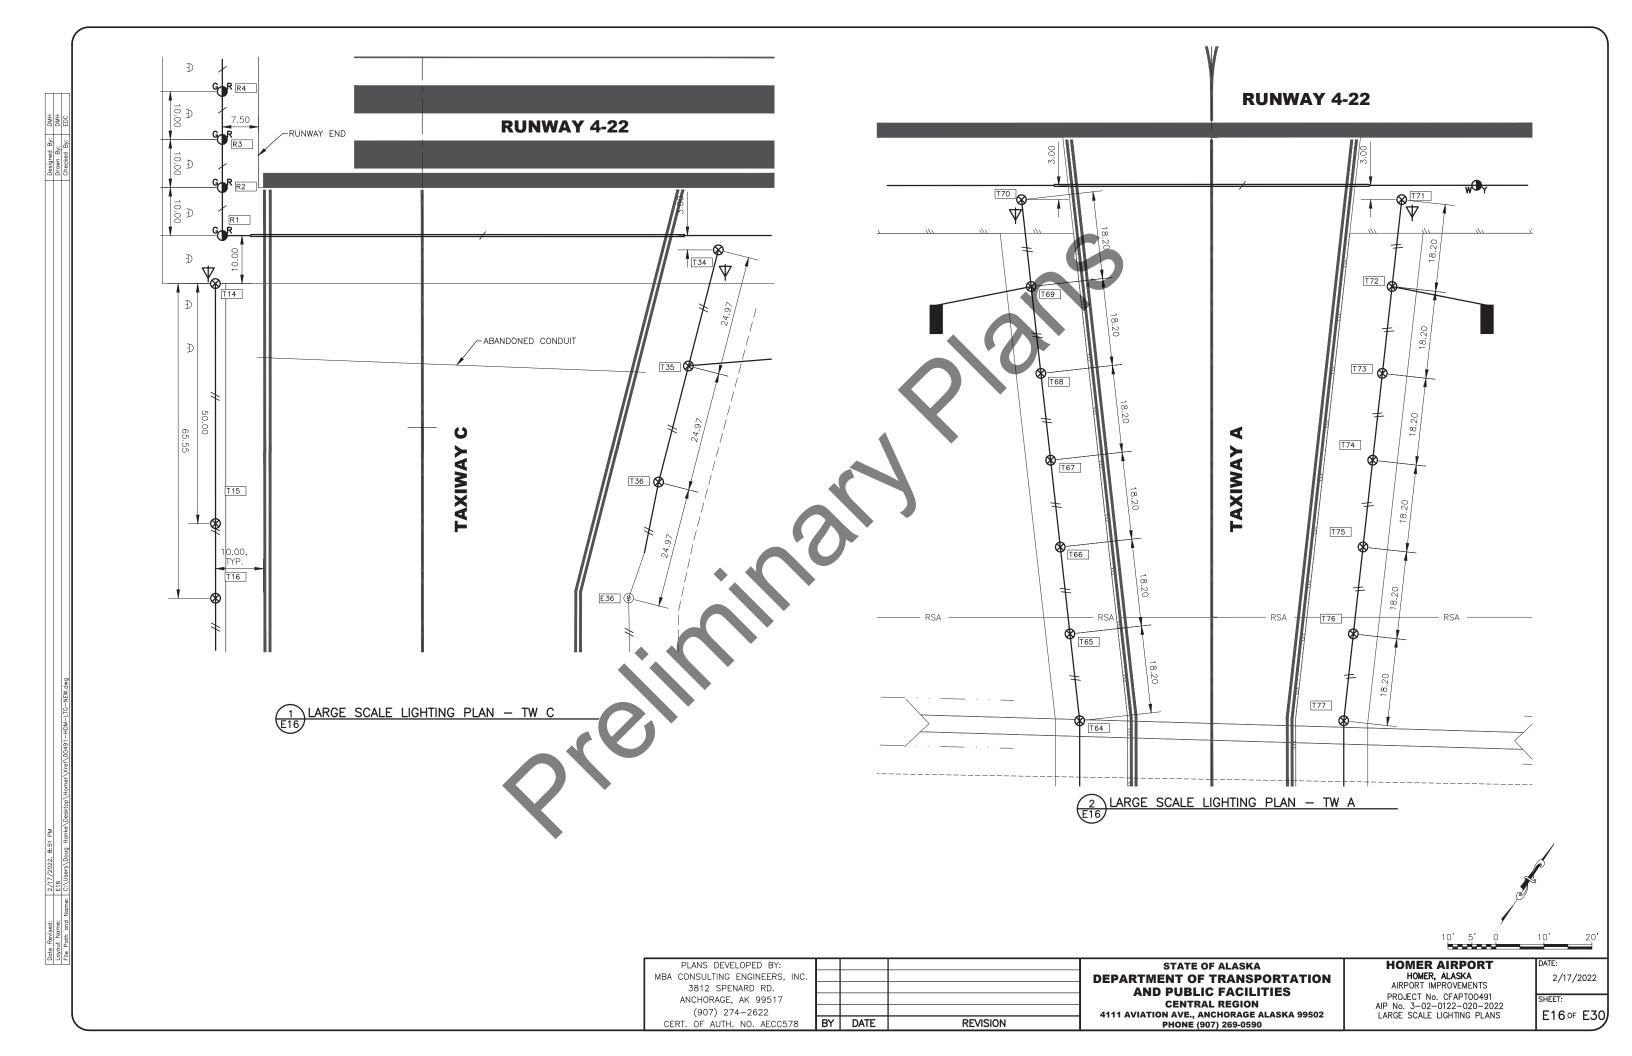


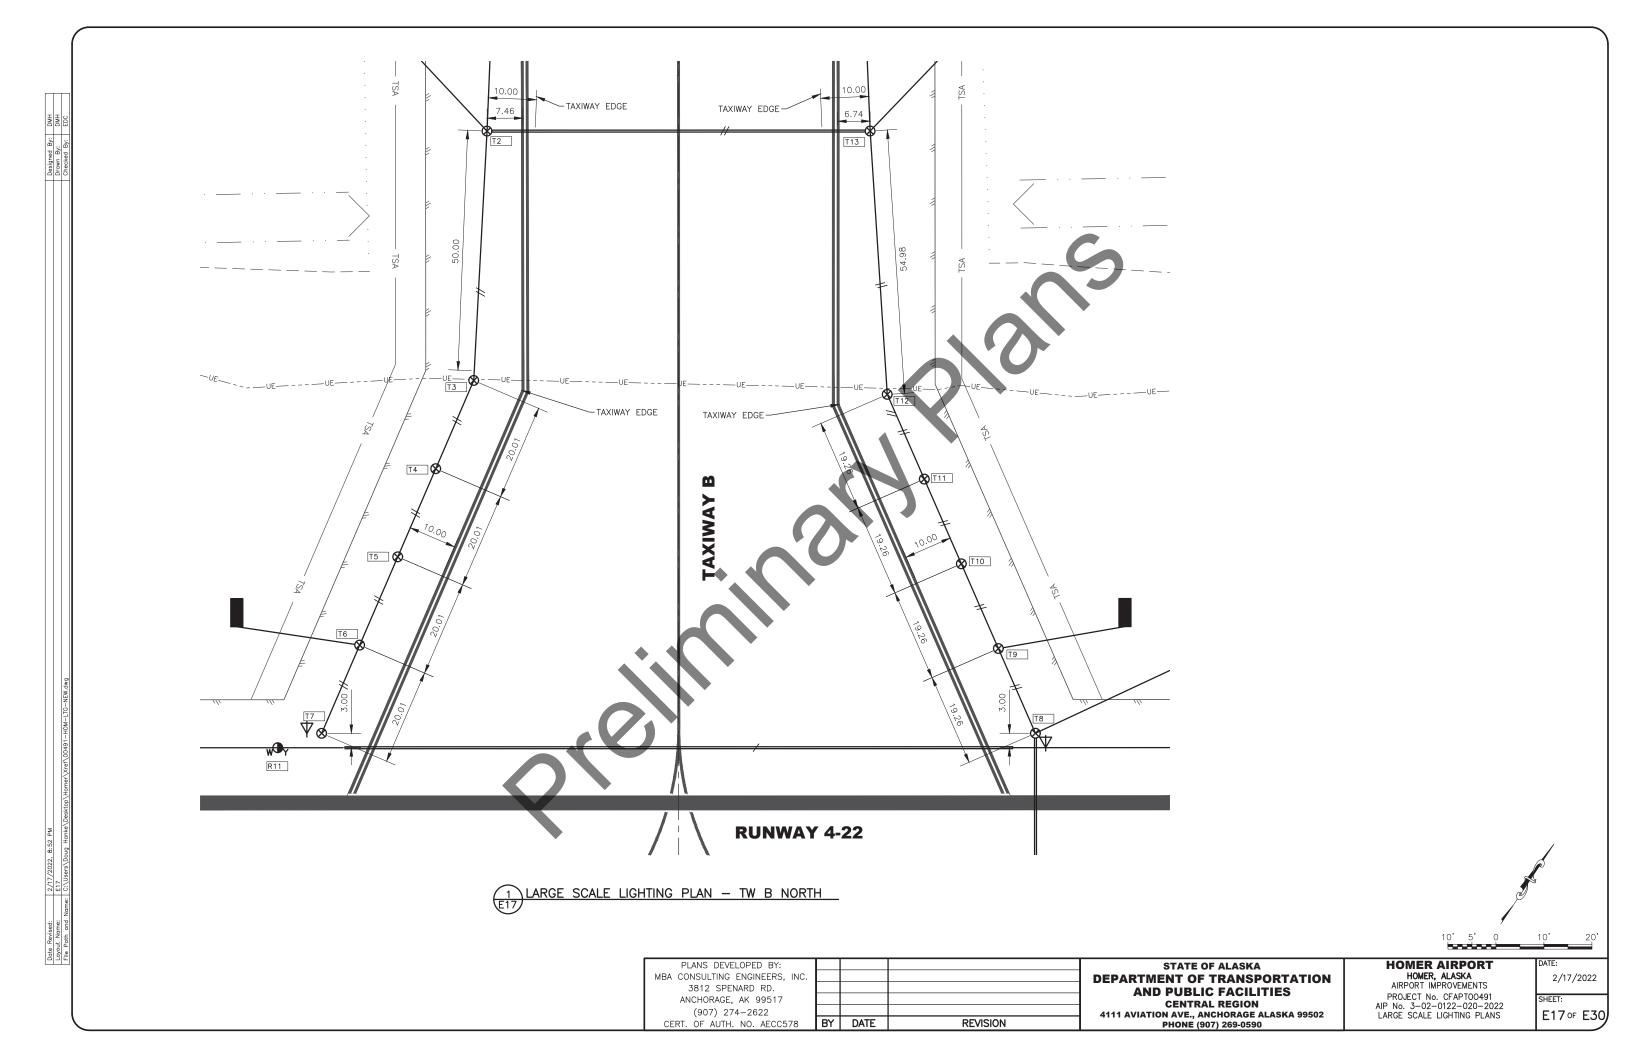


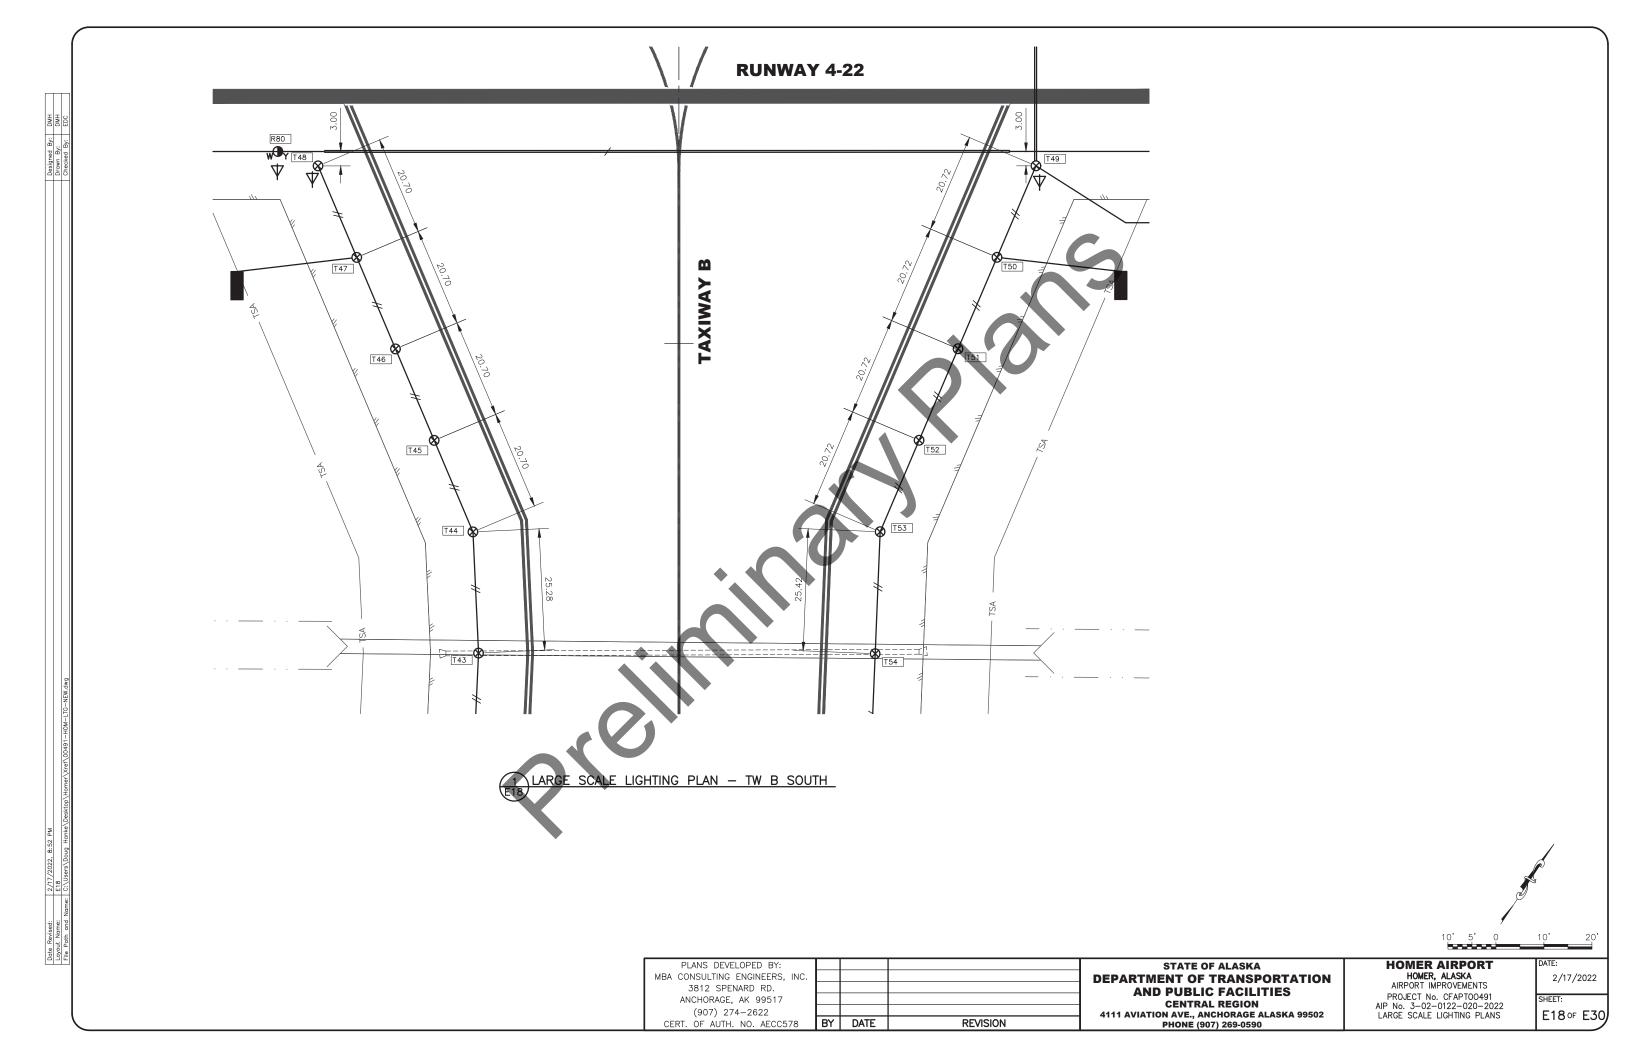

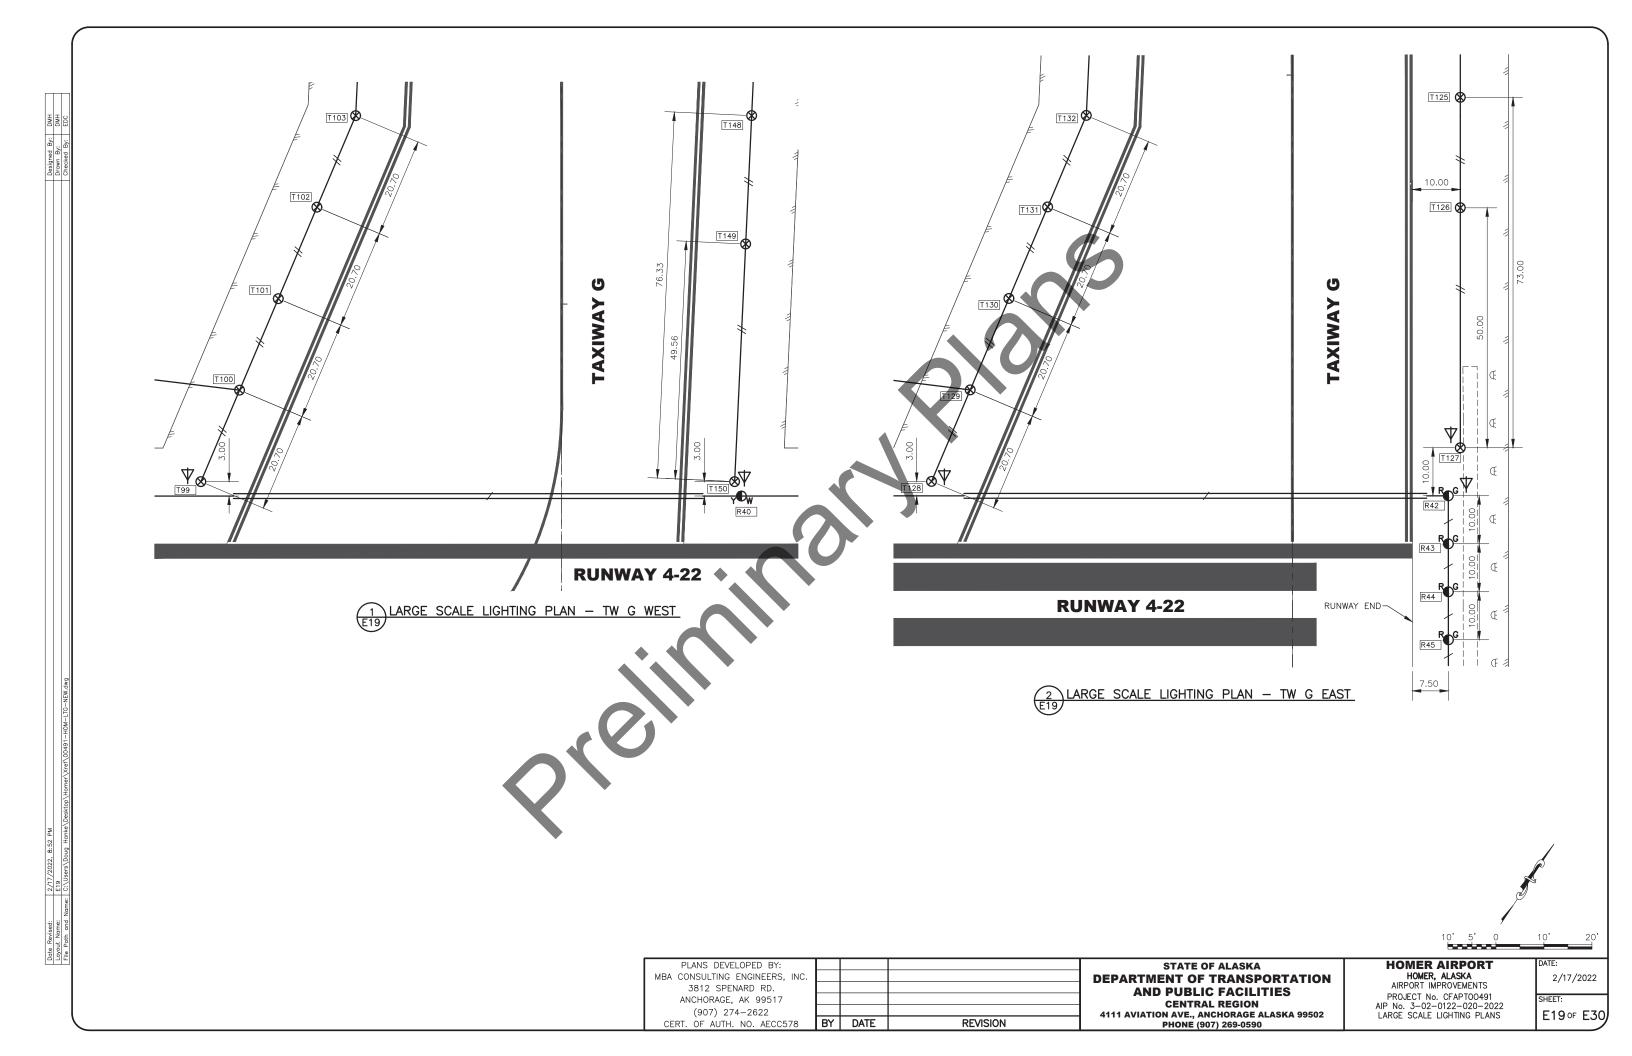

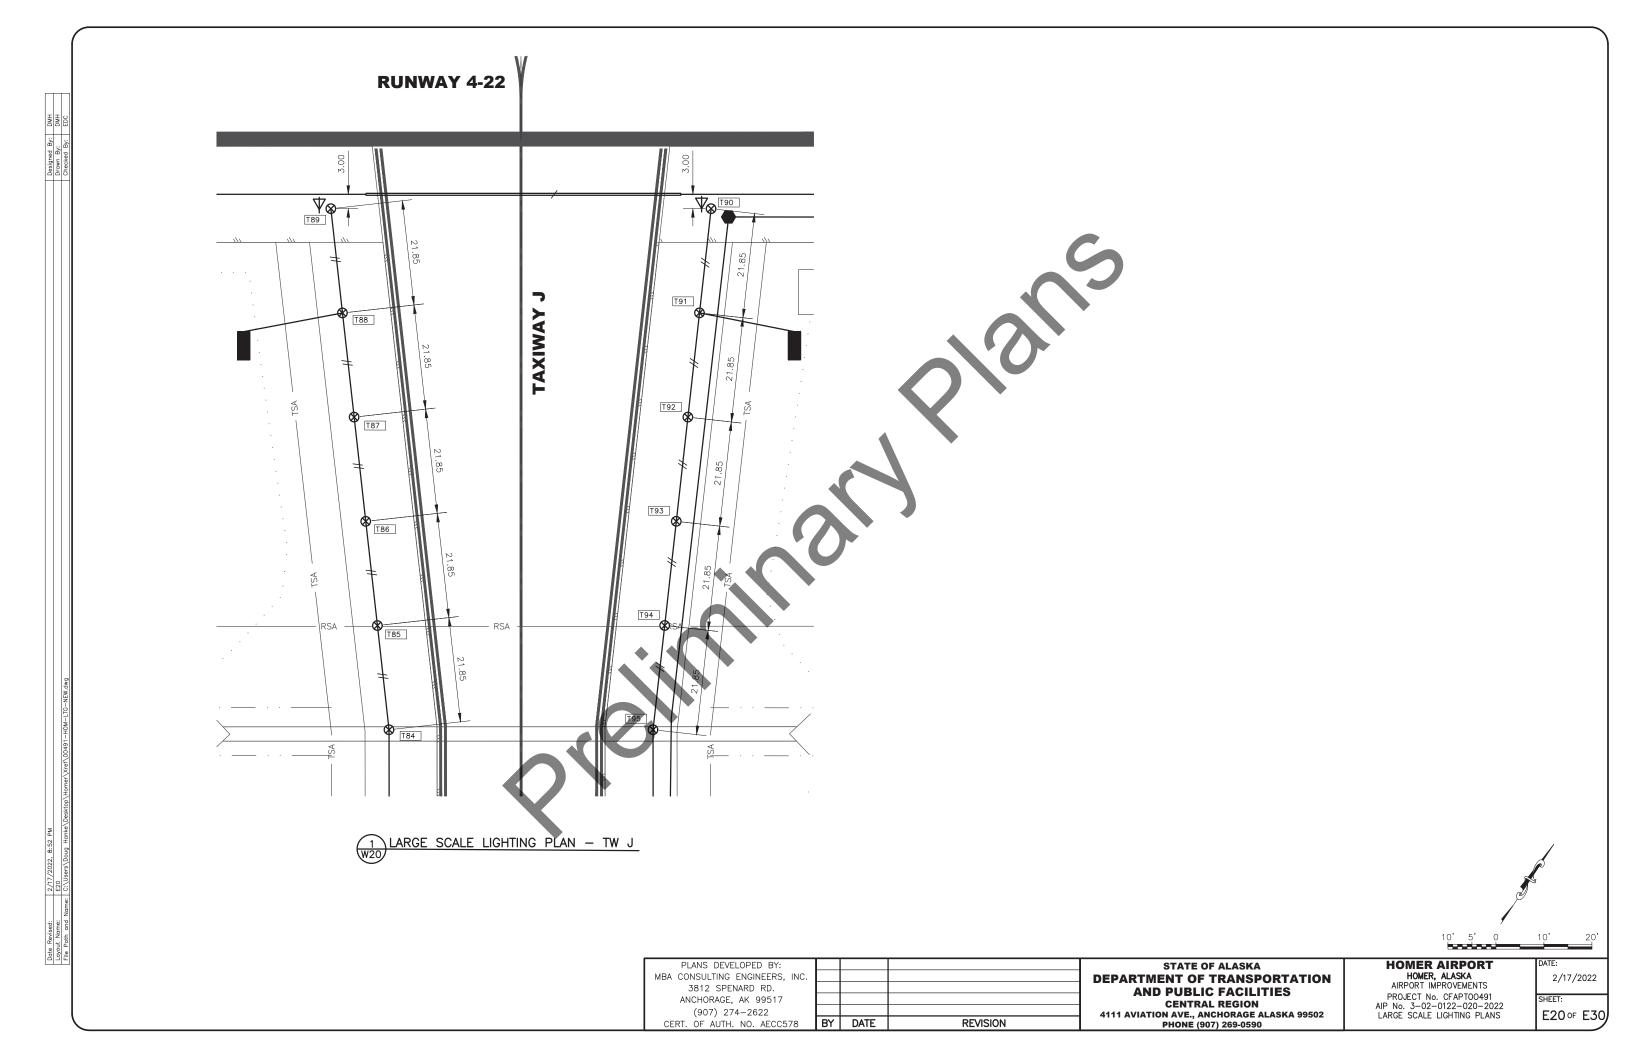

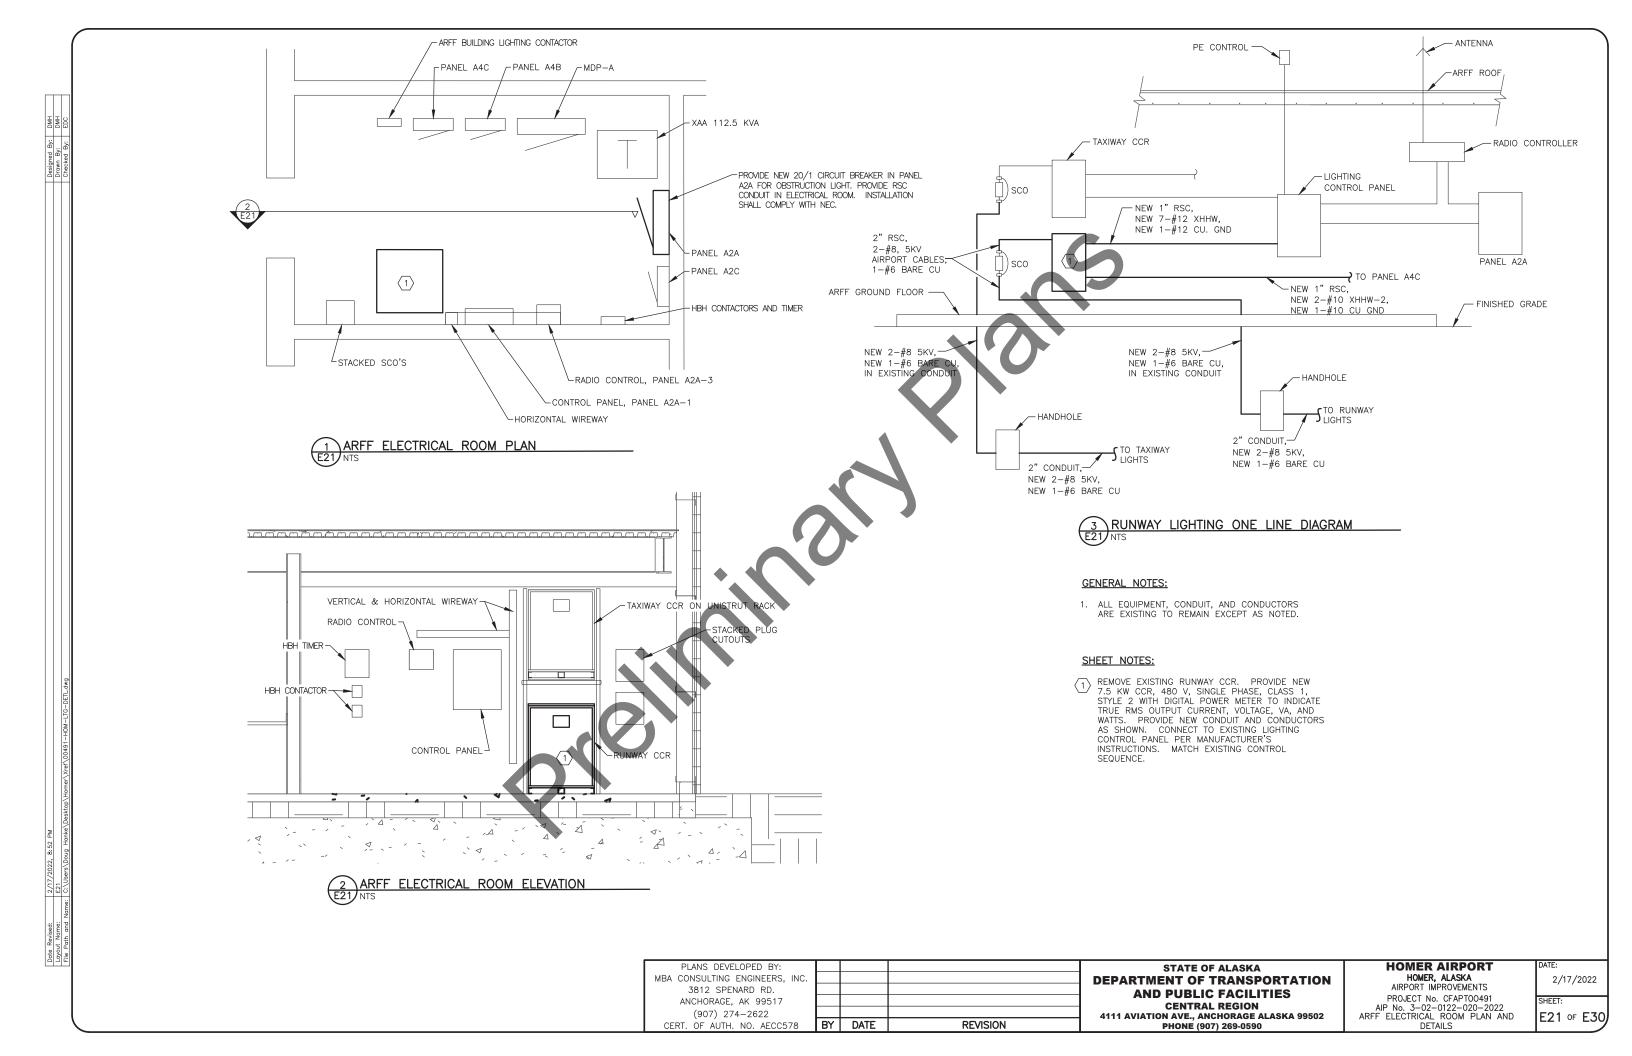

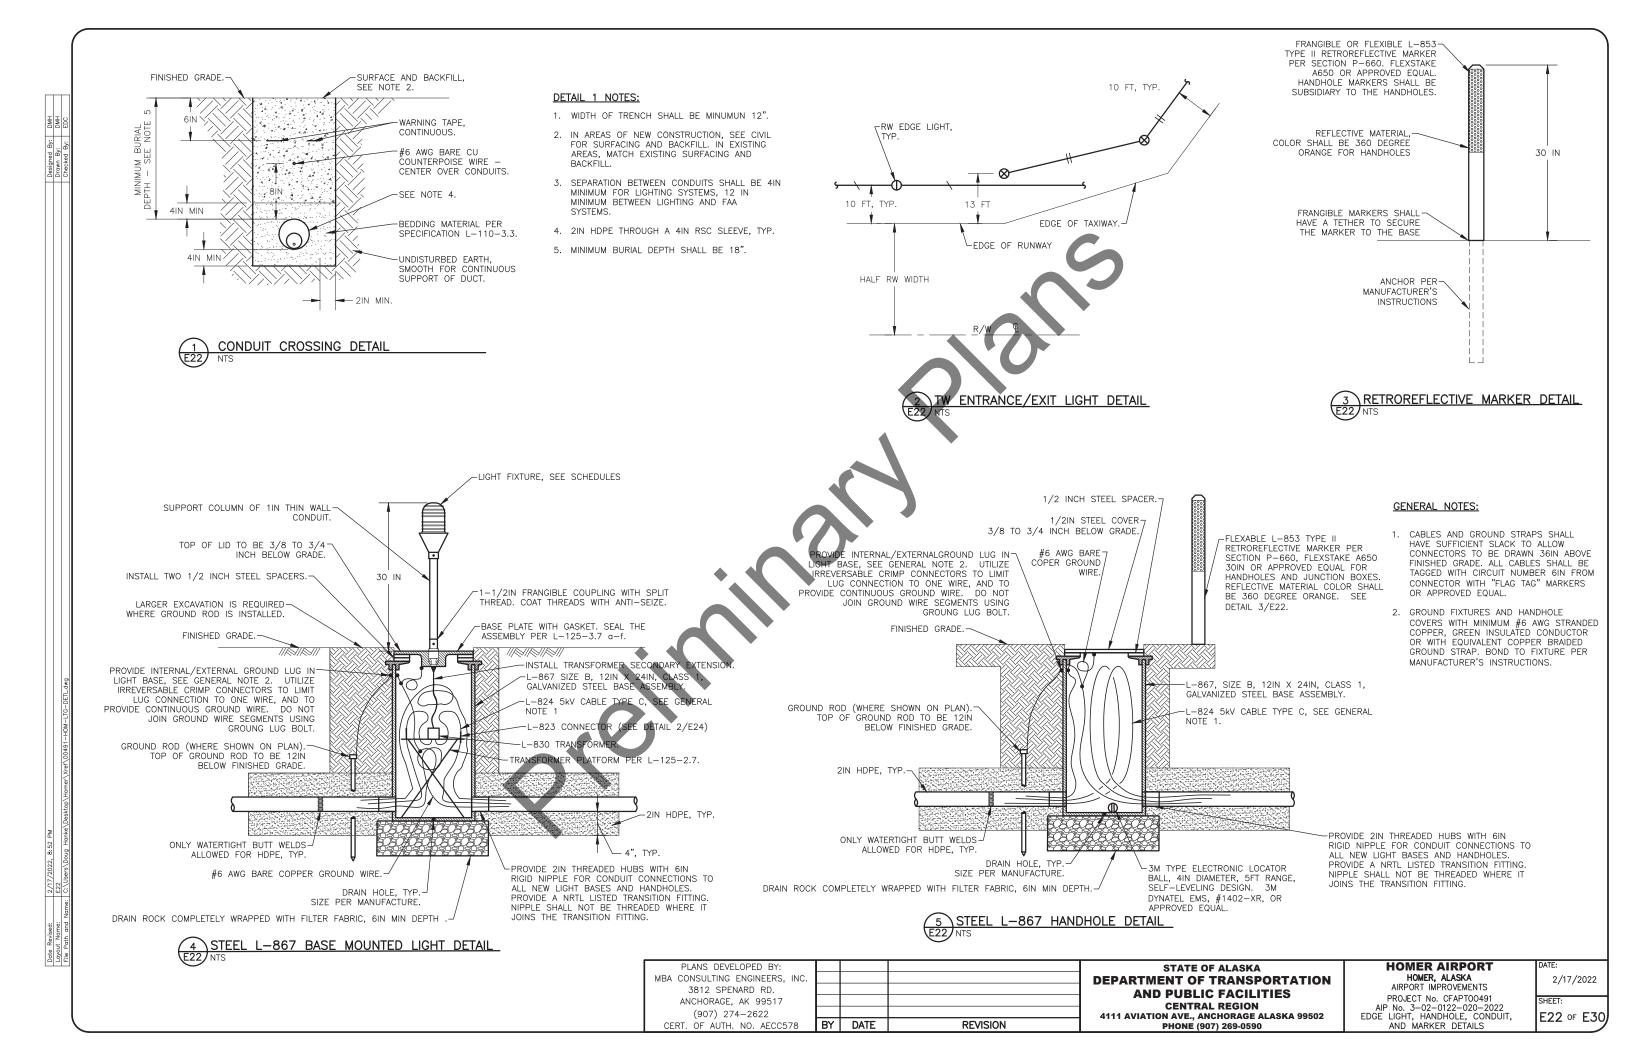


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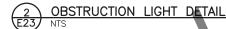
DRYWELLS SHALL BE CONSTRUCTED OUTSIDE OF PAVED SHOULDER UNLESS OTHERWISE INSTRUCTED BY THE ENGINEER.

- UNDISTURBED SOIL

- 2. OVERLAP GEOTEXTILE SEAMS 12 INCHES.
- 3. DRYWELLS SHALL BE PAID UNDER L110.240.0000.
- 4. DRAIN CONDUITS SHALL BE PAID UNDER L110.080.1002.






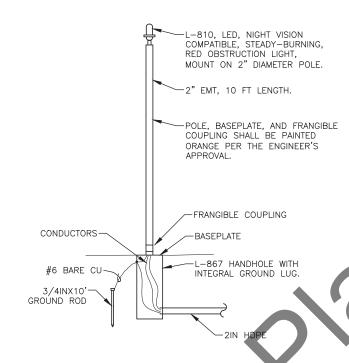


DETAIL NOTES:

, MOUNTING HARDWARE, L-867 RANGIBLE COUPLING, GROUND ROD CONDUIT (UNDERGROUND), RSC 1. POLE, OBSTRUCT HANDHOLES, BASEPLATE, AND #6 BARE CU, HDP SLEEVES (UNDERGROUNI SC (IN ARFF ELECTRICAL ROOM), WIRING, AND ALL OTHER INCIDENTALS REQUIRED TO R FUNCTIONING OBSTRUCTION LIGHT TO THE ENGINEER ARE SUBSIDIARY TO

- PRIMING PAINT FOR NON-GALVANIZED METAL SURFACES
 HALL BE A HIGH SOLIDS ALKYD PRIMER COMPATIBLE WITH
 THE MANUFACTURER'S RECOMMENDATIONS FOR THE
- PRIMING PAINT FOR GALVANIZED METAL SURFACES SHALL BE ZINC DUST-ZINC OXIDE PRIMER PAINT CONFORMING TO MIL-DTL-24441C/19C. USE MIL-24441 THINNER PER PAINT MANUFACTURER'S RECOMMENDATIONS.
- ORANGE PAINT FOR THE BODY AND THE FINISH COATS SHALL CONSIST OF A READY-MIXED NON-FADING PAINT PER MASTER PAINTER'S INSTITUTE (MPI) REFERENCE #9 (GLOSS). THE COLOR SHALL BE PER FEDERAL STANDARDS 595, INTERNATIONAL ORANGE, NUMBER 12197.
- D. FACTORY—APPLIED PAINT SHALL BE MANUFACTURER'S STANDARD PRIME AND FINISH COATS OR POWDER—COATED

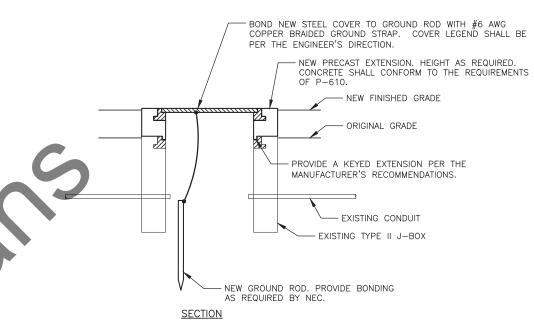

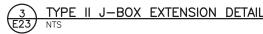

HANDHOLE NOTES:

- HANDHOLE EXTENSION VAULT FRAME AND COVER MUST BE RATED FOR AASHTO $H\!-\!20$ TRAFFIC LOADS.
- CONNECT GROUND CONDUCTORS WITH 2—HOLE LUGS, INSTALL PER MANUFACTURER'S INSTRUCTIONS. PROVIDE BONDING PER NEC REQUIREMENTS.

PLANS DEVELOPED BY: MBA CONSULTING ENGINEERS, INC. 3812 SPENARD RD. ANCHORAGE, AK 99517 (907) 274-2622 CERT. OF AUTH. NO. AECC578

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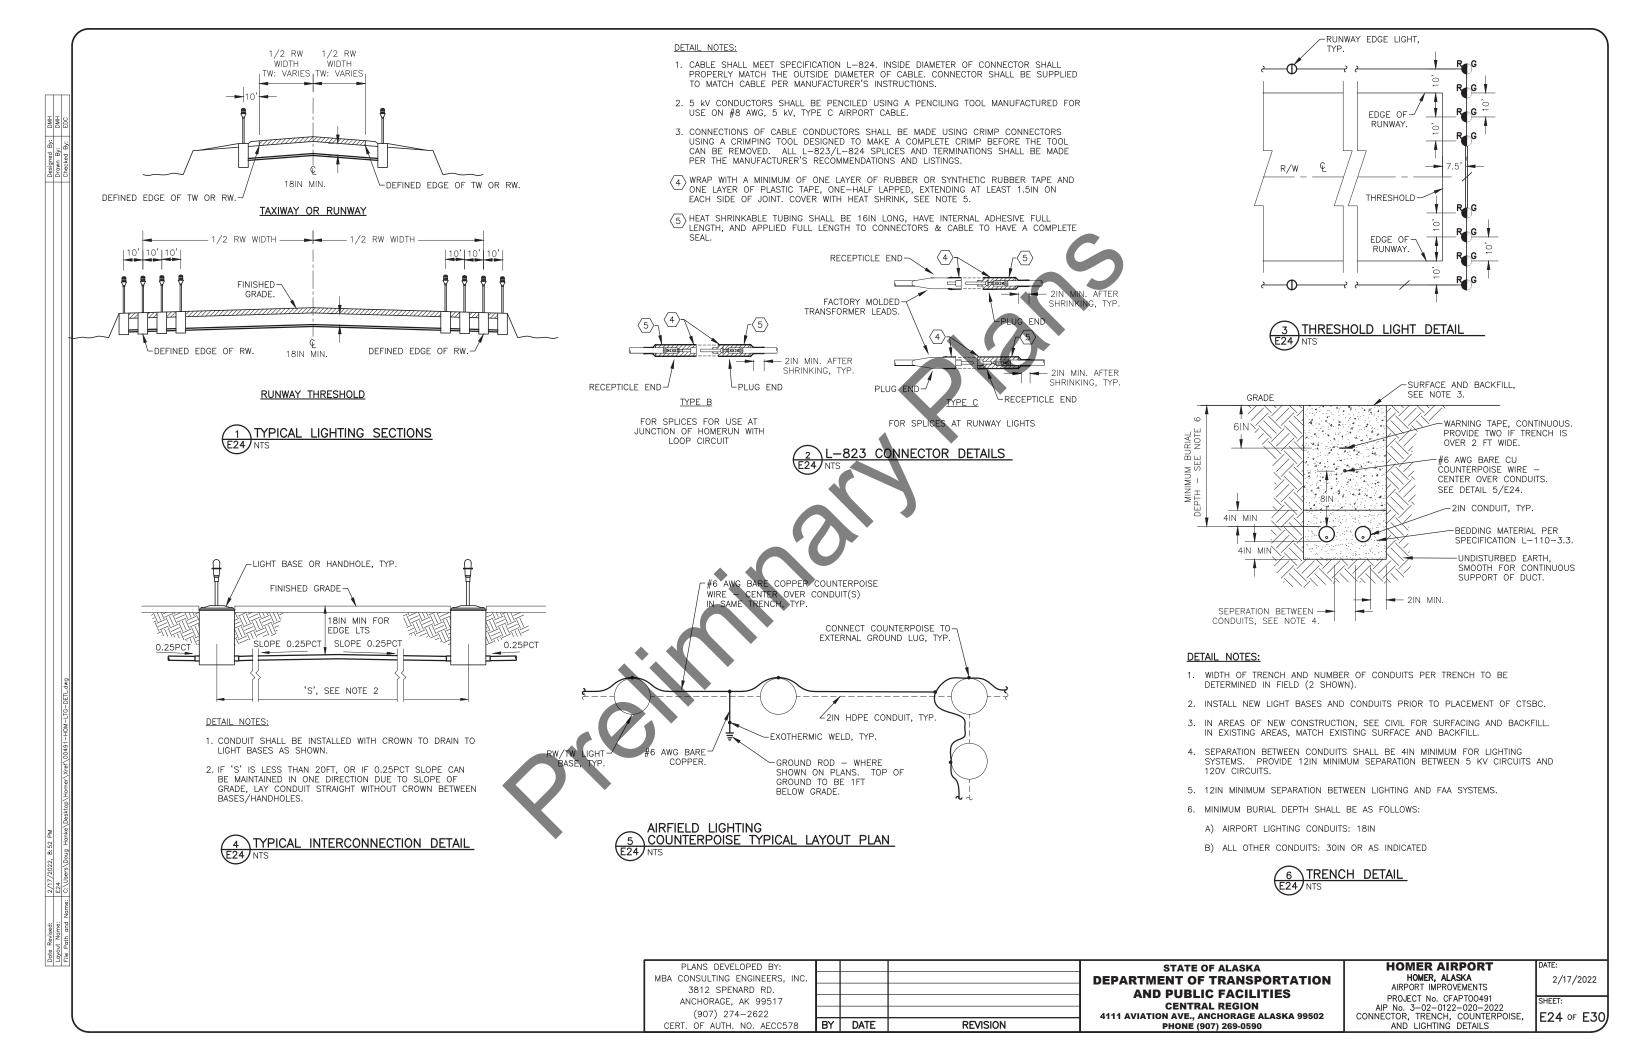
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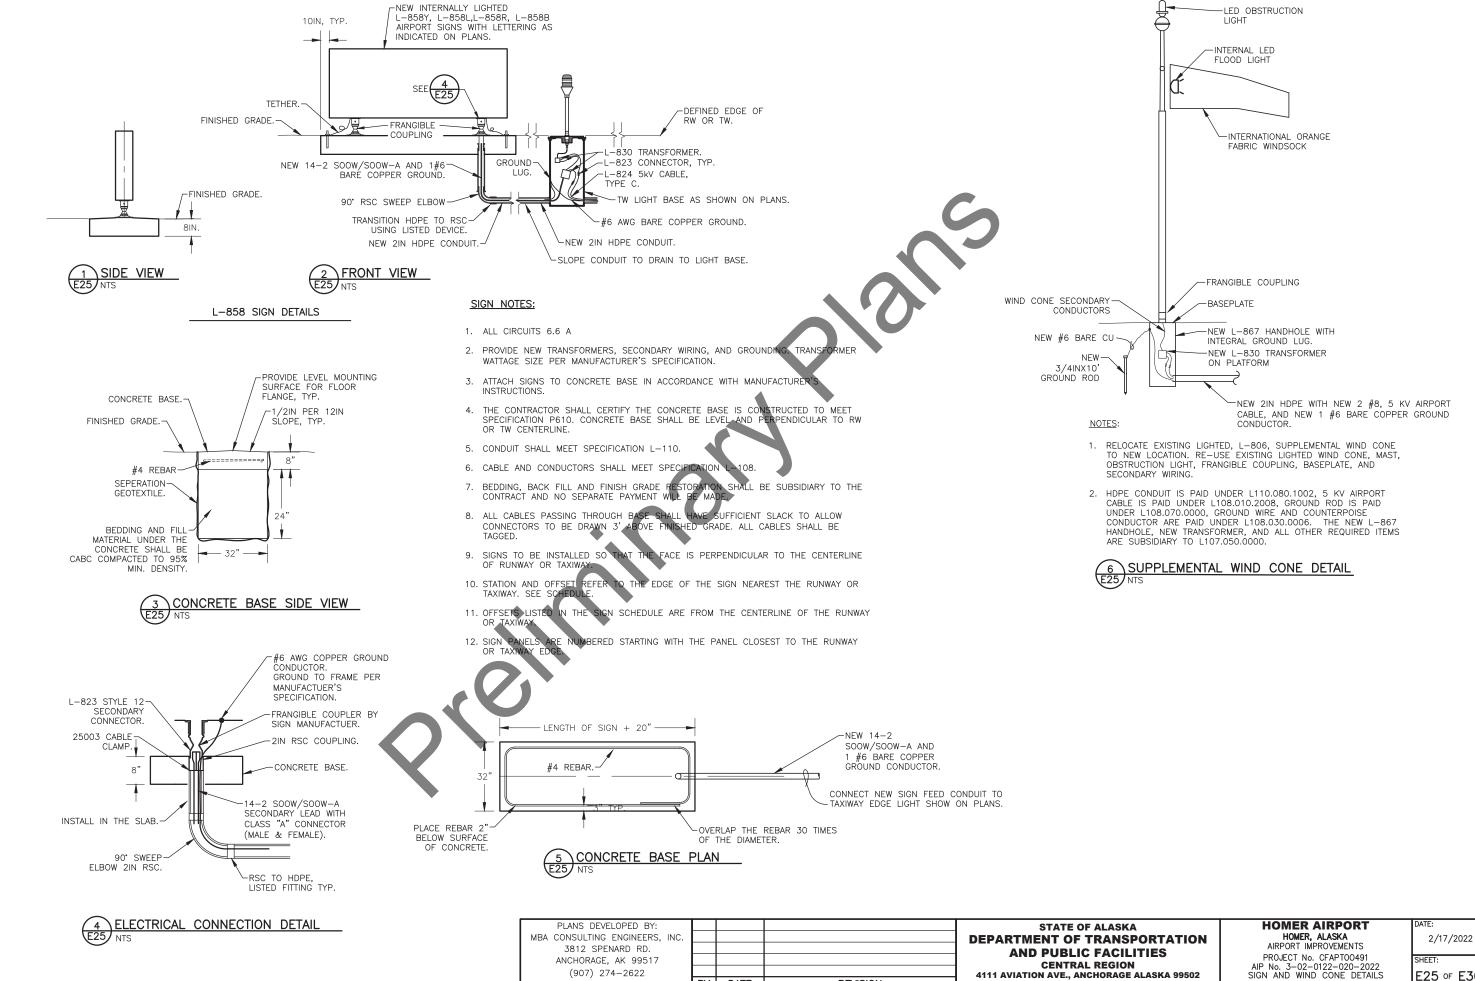
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HOMER AIRPORT HOMER, ALASKA AIRPORT IMPROVEMENTS PROJECT No. CFAPT00491 AIP No. 3-02-0122-020-2022 OBSTRUCTION LIGHT AND DRYWELL DETAILS

E23 of E30

2/17/2022





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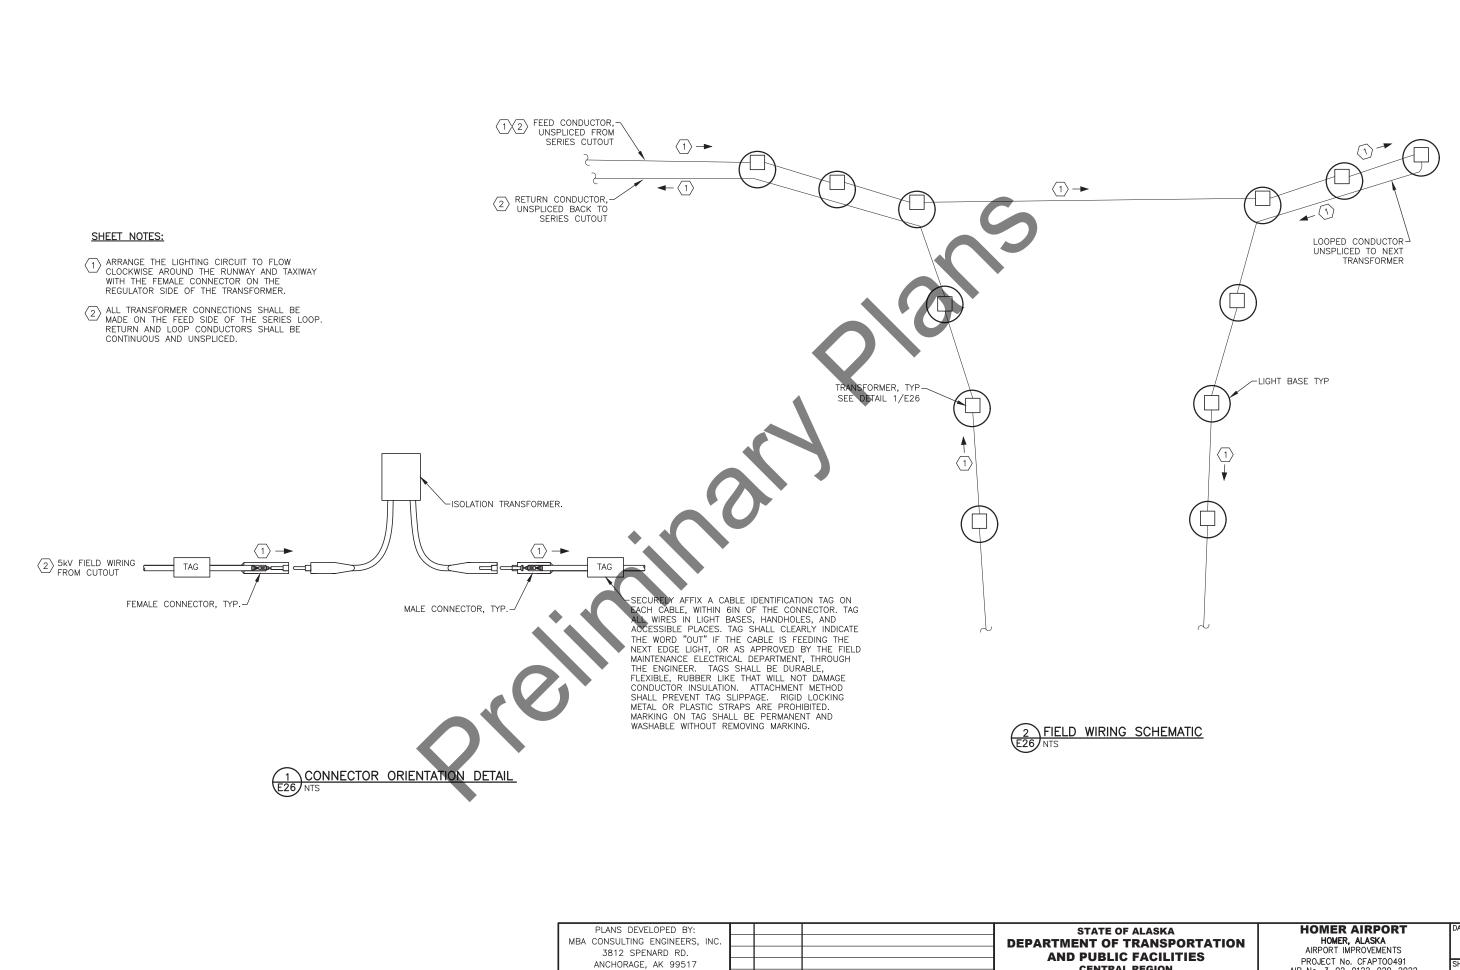
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E25 of E30



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2/17/2022 PROJECT No. CFAPT00491 AIP No. 3-02-0122-020-2022 WIRING DETAILS SHEET: E26 of E30

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T M	DMH	EDC
Designed By:	Drawn By:	Checked By:

Н	OMER HANDHOL	E SCHEDULE	- 5KV All	RPORT CABLE
UNIT #	SYSTEM	PAY ITEM	PAY UNIT	SHEET NUMBER AND NOTES
HH1	AIRFIELD LIGHTING HOMERUN	L125.150.0000	PER EACH	E16, NOTE 1
HH2	AIRFIELD LIGHTING HOMERUN	L125.150.0000	PER EACH	E16, NOTE 1
ннз	AIRFIELD LIGHTING HOMERUN	L125.150.0000	PER EACH	E16, NOTE 1
HH4	AIRFIELD LIGHTING HOMERUN	L125.150.0000	PER EACH	E16, NOTE 1
HH5	AIRFIELD LIGHTING HOMERUN	L125.150.0000	PER EACH	E15, NOTE 1
HH6	AIRFIELD LIGHTING HOMERUN	L125.150.0000	PER EACH	E15, NOTE 1
НН7	TAXIWAY G	L125.150.0000	PER EACH	E15, NOTE 1
НН8	TAXIWAY G	L125.150.0000	PER EACH	E16, NOTE 1
НН9	TAXIWAY G	L125.150.0000	PER EACH	E16, NOTE 1
HH10	TAXIWAY G	L125.150.0000	PER EACH	E16, NOTE 1
HH11	TAXIWAY G	L125.150.0000	PER EACH	E16, NOTE 1
HH12	TAXIWAY G	L125.150.0000	PER EACH	E17, NOTE 1
HH13	TAXIWAY G	L125.150.0000	PER EACH	E17, NOTE 1
HH14	TAXIWAY G	L125.150.0000	PER EACH	E17, NOTE 1
HH15	TAXIWAY G	L125.150.0000	PER EACH	E17, NOTE 1
HH16	TAXIWAY G	L125.150.0000	PER EACH	E18, NOTE 1
HH17	TAXIWAY G	L125.150.0000	PER EACH	E18, NOTE 1
HH18	TAXIWAY G	L125.150.0000	PER EACH	E18, NOTE 1
HH19	TAXIWAY G	L125.150.0000	PER EACH	E18, NOTE 1
HH20	SUPPLEMENTAL WIND CONE	L125.150.0000	PER EACH	E19, NOTE 1
HH21	SUPPLEMENTAL WIND CONE	L125.150.0000	PER EACH	E19, NOTE 1
HH22	SUPPLEMENTAL WIND CONE	L125.150.0000	PER EACH	E19, NOTE 1

NOTES:

1. FIELD LOCATE AND AS-BUILT LOCATION

		HOMER	AIRPORT	RUNWA	Y EDG	E LIGHT	SCHEDULE		
UNIT #	COLOR	TYPE	USED	WATTS	XFMR	ALIGNMEN T	STATION	OFFSET	NOTES
R1	R/G	L-861E	THRESHOLD	45	45	RW	7+92.5	60'R	
R2	R/G	L-861E	THRESHOLD	45	45	RW	7+92.5	50'R	
R3	R/G	L-861E	THRESHOLD	45	45	RW	7+92.5	40'R	
R4	R/G	L-861E	THRESHOLD	45	45	RW	7+92.5	30'R	
R5	R/G	L-861E	THRESHOLD	45	45	RW	7+92.5	30'L	
R6	R/G	L-861E	THRESHOLD	45	45	RW	7+92.5	40'L	
R7	R/G	L-861E	THRESHOLD	45	45	RW	7+92.5	50'L	
R8	R/G	L-861E	THRESHOLD	45	45	RW	7+92.5	60'L	
R9	W/Y	L-861	RW EDGE	45	45	RW	9+90.03	60'L	
R10	W/Y	L-861	RW EDGE	45	45	RW	11+87.56	60'L	
R11	W/Y	L-861	RW EDGE	45	45	RW	13+85.09	60'L	
R12	W/Y	L-861	RW EDGE	45	45	RW	15+82.62	60'L	
R13	W/Y	L-861	RW EDGE	45	45	RW	17+80.15	60'L	
R14	W/Y	L-861	RW EDGE	45	45	RW	19+77.68	60'L	
R15	W/Y	L-861	RW EDGE	45	45	RW	21+75.21	60'L	
R16	W/Y	L-861	RW EDGE	45	45	RW	23+72.73	60'L	
R17	W/Y	L-861	RW EDGE	45	45	RW	25+70.26	60'L	
R18	W/Y	L-861	RW EDGE	45	45	RW	27+67.79	60'L	
R19	W	L-861	RW EDGE	45	45	RW	29+65.32	60'L	
R20	W	L-861	RW EDGE	45	45	RW	31+62.85	60'L	
R21	W	L-861	RW EDGE	45	45	RW	33+60.38	60'L	
R22	W	L-861	RW EDGE	45	45	RW	35+57.91	60'L	
R23	W	L-861	RW EDGE	45	45	RW	37+55.42	60'L	
R24	W	L-861	RW EDGE	45	45	RW			
R25	W	L-861	RW EDGE	45	45	RW			
R26	W	L-861	RW EDGE	45	45	RW			
R27	W	L-861	RW EDGE	45	45	RW			
R28	W	L-861	RW EDGE	45	45	RW			
R29	W	L-861	RW EDGE	45	45	RW			
R30	W	L-861	RW EDGE	45	45	RW			
R31	W	L-861	RW EDGE	45	45	RW			
R32	Y/W	L-861	RW EDGE	45	45	RW			
R33	Y/W	L-861	RW EDGE	45	45	RW			
R34	Y/W	L-861	RW EDGE	45	45	RW			
R35	Y/W	L-861	RW-EDGE	45	45	RW			
R36	Y/W	L-861	RW EDGE	45	45	RW			
R37	Y/W	L-861	RW EDGE	45	45	RW			
R38	Y/W	L-861	RW EDGE	45	45	RW			
R39	Y/W	L-861	RW EDGE	45	45	RW			
R40	Y/W	L-861	RW EDGE	45	45	RW			
R41	Y/W	L-861	RW EDGE	45	45	RW			

	НОМ	ER AIRP	ORT RUNWA	Y EDG	E LIGI	HT SCHE	DULE CONTIL	NUED	
UNIT #	COLOR	TYPE	USED	WATTS	XFMR	ALIGNMEN T	STATION	OFFSET	NOTES
R42	G/R	L-861E	THRESHOLD	45	45	RW			
R43	G/R	L-861E	THRESHOLD	45	45	RW			
R44	G/R	L-861E	THRESHOLD	45	45	RW			
R45	G/R	L-861E	THRESHOLD	45	45	RW			
R46	G/R	L-861E	THRESHOLD	45	45	RW			
R47	G/R	L-861E	THRESHOLD	45	45	RW			
R48	G/R	L-861E	THRESHOLD	45	45	RW			
R49	G/R	L-861E	THRESHOLD	45	45	RW			
R50	Y/W	L-861	RW EDGE	45	45	RW			
R51	Y/W	L-861	RW EDGE	45	45	RW			
R52	Y/W	L-861	RW EDGE	45	45	RW			
R53	Y/W	L-861	RW EDGE	45	45	RW			
R54	Y/W	L-861	RW EDGE	45	45	RW			
R55	Y/W	L-861	RW EDGE	45	45	RW			
R56	Y/W	L-861	RW EDGE	45	45	RW			
R57	Y/W	L-861	RW EDGE	45	45	RW			
R58	Y/W	L-861	RW EDGE	45	45	RW			
R59	Y/W	L-861	RW EDGE	45	45	RW			
R60	W	L-861	RW EDGE	45	45	RW			
R61	W	L-861	RW EDGE	45	45	RW			
R62	W	L-861	RW EDGE	45	45	RW			
R63	W	L-861	RW EDGE	45	45	RW			
R64	W	L-861	RW EDGE	45	45	RW			
R65	W	L-861	RW EDGE	45	45	RW			
R66	W	L-861	RW EDGE	45	45	RW			
R67	W	L-861	RW EDGE	45 45	45 45	RW			
R68 R69	VV	L-861	RW EDGE	43	40	RW	NOT USED		
R70	W	L-861	RW EDGE	45	45	RW	NOT USED		
R71	W	L-861	RW EDGE	45	45	RW			
R72	W	L-861	RW EDGE	45	45	RW			
R73	W/Y	L-861	RW EDGE	45	45	RW			
R74	W/Y	L-861	RW EDGE	45	45	RW			
R75	W/Y	L-861	RW EDGE	45	45	RW			
R76	W/Y	L-861	RW EDGE	45	45	RW			
R77	W/Y	L-861	RW EDGE	45	45	RW			
R78	W/Y	L-861	RW EDGE	45	45	RW			
R79	W/Y	L-861	RW EDGE	45	45	RW			
R80	W/Y	L-861	RW EDGE	45	45	RW			
R81	W/Y	L-861	RW EDGE	45	45	RW			
R82	W/Y	L-861	RW EDGE	45	45	RW			

PLANS DEVELOPED BY: MBA CONSULTING ENGINEERS, INC. 3812 SPENARD RD. ANCHORAGE, AK 99517 (907) 274-2622 CERT. OF AUTH. NO. AECC578

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HOMER AIRPORT HOMER, ALASKA
AIRPORT IMPROVEMENTS
PROJECT No. CFAPT00491
AIP No. 3-02-0122-020-2022
RUNWAY EDGE LIGHT AND HANDHOLE
SCHEDULES

2/17/2022 SHEET: E27 of E30

HOMER AIRPORT TAXIWAY EDGE LIGHT SCHEDULE LIGHT # COLOR TYPE LAMP XFMR ALIGNMENT STATION OFFSET NOTES BLUE | L861T | LED | 10/15 | TW B NORTH BLUE | L861T | LED | 10/15 | TW B NORTH BLUE L861T LED 10/15 TW B NORTH BLUE | L861T | LED | 10/15 | TW B NORTH BLUE L861T LED 10/15 TW B NORTH BLUE | L861T | LED | 10/15 | TW B NORTH BLUE L861T LED 10/15 TW B NORTH BLUE L861T LED 10/15 TW B NORTH BLUE | L861T | LED | 10/15 | TW B NORTH BLUE | L861T | LED | 10/15 | TW B NORTH BLUE L861T LED 10/15 T 10 TW B NORTH BLUE L861T LED 10/15 TW B NORTH T 11 T 12 BLUE | L861T | LED | 10/15 | TW B NORTH T 13 BLUE L861T LED 10/15 TW B NORTH BLUE L861T LED 10/15 TW C BLUE L861T LED 10/15 T 15 TW C BLUE | L861T | LED | 10/15 | TW C T 16 T 17 BLUE | L861T | LED | 10/15 | TW C T 18 BLUE L861T LED 10/15 TW C T 19 BLUE | L861T | LED | 10/15 TW C T 20 BLUE L861T LED 10/15 TW C T 21 BLUE L861T LED 10/15 TW C BLUE | L861T | LED | 10/15 | T 22 TW C T 23 BLUE | L861T | LED | 10/15 | TW C T 24 BLUE L861T LED 10/15 TW D BLUE L861T LED 10/15 TW D BLUE L861T LED 10/15 TW D T 26 BLUE | L861T | LED | 10/15 | TW D T 27 T 28 BLUE | L861T | LED | 10/15 | TW D BLUE L861T LED 10/15 T 29 TW B SOUTH T 30 BLUE | L861T | LED | 10/15 | TW B SOUTH BLUE L861T LED 10/15 TW B SOUTH T 32 BLUE L861T LED 10/15 TW B SOUTH BLUE | L861T | LED | 10/15 | TW B SOUTH T 33 T 34 BLUE | L861T | LED | 10/15 | T 35 BLUE L861T LED 10/15 TW C T 36 BLUE | L861T | LED | 10/15 | TW C BLUE L861T LED 10/15 TW D T 37 BLUE | L861T | LED | 10/15 | TW D T 38 T 39 BLUE | L861T | LED | 10/15 | TW D BLUE L861T LED 10/15 TW B SOUTH T 40 T 41 BLUE | L861T | LED | 10/15 | TW B SOUTH BLUE L861T LED 10/15 TW B SOUTH BLUE L861T LED 10/15 TW B SOUTH T 43 T 44 BLUE L861T LED 10/15 TW B SOUTH L861T LED 10/15 TW B SOUTH T 46 BLUE L861T LED 10/15 TW B SOUTH T 47 BLUE L861T LED 10/15 TW B SOUTH T 48 BLUE L861T LED 10/15 TW B SOUTH BLUE L861T LED 10/15 TW B SOUTH T 49 T 50 BLUE L861T LED 10/15 TW B SOUTH

HOMER AIRPORT TAXIWAY						EDGE LIGH	T SCHEDULE	CONTINU	ED
LIGH	T #	COLOR	TYPE	LAMP	XFMR	ALIGNMENT	STATION	OFFSET	NOTES
Т	51	BLUE	L861T	LED	10/15	TW B SOUTH			
Т	52	BLUE	L861T	LED	10/15	TW B SOUTH			
Т	53	BLUE	L861T	LED	10/15	TW B SOUTH			
Т	54	BLUE	L861T	LED	10/15	TW B SOUTH			
Т	55	BLUE	L861T	LED	10/15	TW B SOUTH			
Т	56	BLUE	L861T	LED	10/15	TW B SOUTH			
Т	57	BLUE	L861T	LED	10/15	TW B SOUTH			
Т	58	BLUE	L861T	LED	10/15	TW B SOUTH			
Т	59	BLUE	L861T	LED	10/15	TW B SOUTH			
Т	60	BLUE	L861T	LED	10/15	TW B SOUTH			
Т	61	BLUE	L861T	LED	10/15	TW A			
Т	62	BLUE	L861T	LED	10/15	TW A			
Т	63	BLUE	L861T	LED	10/15	TW A			4
Т	64	BLUE	L861T	LED	10/15	TW A		4	
Т	65	BLUE	L861T	LED	10/15	TW A			
Т	66	BLUE	L861T	LED	10/15	TW A			
Т	67	BLUE	L861T	LED	10/15	TW A			
Т	68	BLUE	L861T	LED	10/15	TW A			
	69	BLUE	L861T	LED	10/15	TW A			
Т	70	BLUE	L861T	LED	10/15	TW A			
T	71	BLUE	L861T	LED	10/15	TW A			
	72	BLUE	L861T	LED	10/15	TW A			
	73	BLUE	L861T	LED	10/15	TW A			
Т	74	BLUE	L861T	LED	10/15	TW A	*		
т.	75	BLUE	L861T	LED	10/15	TW A			
T	76	BLUE	L861T	LED	10/15	TW. A			
	77	BLUE	L861T	LED	10/15	TW A			
	78	BLUE	L861T	LED	10/15	TW A			
	79	BLUE	L861T	E D	10/15	TW A			
т	80	BLUE	L861T	LED	10/15	TW A			
	81	BLUE	L861T	LED	10/15	TW J			
	82	BLUE	L861T	LED	10/15	TW J			
	83	BLUE	L861T	LED	10/15	TW J			
	84 4	BLUE	L861T	LED	10/15	TW J			
	85	BLUE	L861T	LED	10/15	TW J			
	86		£861T		10/15	TW J			
	87	BLUE	L861T	LED	10/15	TW J			
$\overline{}$	88	BLUE	L861T	LED	10/15	TW J			
	89	BLUE	L861T	LED	10/15	TW J			
	90	BLUE	L861T	LED	10/15	TW J			
	91	BLUE	L861T	LED	10/15	TW J			
_	92	BLUE	L861T	LED	10/15	TW J			
	93	BLUE		LED	10/15	TW J			
_	93	BLUE	L861T	LED	10/15	TW J			
	95	BLUE	L861T	LED	10/15	TW J			
	95 96		L861T		10/15				
		BLUE	L861T	LED		TW J			
	97	BLUE	L861T	LED	10/15	TW J			
	98	BLUE	L861T	LED	10/15	TW J			
	99	BLUE	L861T	LED	10/15	TW G			
Т	100	BLUE	L861T	LED	10/15	TW G			

	HON	/IER A	IRPORT	TAXIV	VAY EDO	E LIGHT	SCHEDULE	CONTINU	ED
LIGH	HT #	COLOR	TYPE	LAMP	XFMR	ALIGNMEN T	STATION	OFFSET	NOTES
Т	101	BLUE	L861T	LED	10/15	TW G			
Т	102	BLUE	L861T	LED	10/15	TW G			
Т	103	BLUE	L861T	LED	10/15	TW G			
Т	104	BLUE	L861T	LED	10/15	TW G			
Т	105	BLUE	L861T	LED	10/15	TW G			
Т	106	BLUE	L861T	LED	10/15	TW G			
Т	107	BLUE	L861T	LED	10/15	TW G			
Т	108	BLUE	L861T	LED	10/15	TW G			
Т	109	BLUE	L861T	LED	10/15	TW G			
Т	110	BLUE	L861T	LED	10/15	TW G			
Т	111	BLUE	L861T	LED	10/15	TW G			
Т	112	BLUE	L861T	LED	10/15	TW G			
Т	113	BLUE	L861T	LED	10/15	TW G			
Т	114	BLUE	L861T	LED	10/15	TW G			
Т	115	BLUE	L861T	LED	10/15	TW G			
Т	116	BLUE	L861T	LED	10/15	TW G			
Т	117	BLUE	L861T	LED	10/15	TW G			
Т	118	BLUE	L861T	LED	10/15	TW G			
Т	119	BLUE	L861T	LED	10/15	TW G			
Τ	120	BLUE	L861T	LED	10/15	TW G			
Т	121	BLUE	L861T	LED	10/15	TW G			
Т	122	BLUE	L861T	LED	10/15	TW G			
Т	123	BLUE	L861T	LED	10/15	TW G			
Т	124	BLUE	L861T	LED	10/15	TW G			
Т	125	BLUE	L861T	LED	10/15	TW G			
Т	126	BLUE	L861T	LED	10/15	TW G			
Т	127	BLUE	L861T	LED	10/15	TW G			
Т	128	BLUE	L861T	LED	10/15	TW G			
Т	129	BLUE	L861T	LED	10/15	TW G			
Т	130	BLUE	L861T	LED	10/15	TW G			
Т	131	BLUE	L861T	LED	10/15	TW G			
Т	132	BLUE	L861T	LED	10/15	TW G			
Т	133	BLUE	L861T	LED	10/15	TW G			
Т	134	BLUE	L861T	LED	10/15	TW G			
Т	135	BLUE	L861T	LED	10/15	TW G			
Т	136	BLUE	L861T	LED	10/15	TW G			
Т	137	BLUE	L861T	LED	10/15	TW G			
Т	138	BLUE	L861T	LED	10/15	TW G			
Т	139	BLUE	L861T	LED	10/15	TW G			
Т	140	BLUE	L861T	LED	10/15	TW G			
Т	141	BLUE	L861T	LED	10/15	TW G			
Т	142	BLUE	L861T	LED	10/15	TW G			
Т	143	BLUE	L861T	LED	10/15	TW G			
	144	BLUE	L861T	LED	10/15	TW G			
Т	145	BLUE	L861T	LED	10/15	TW G			
	146	BLUE	L861T	LED	10/15	TW G			
	147	BLUE	L861T	LED	10/15	TW G			
	148	BLUE	L861T	LED	10/15	TW G			
	149	BLUE	L861T	LED	10/15	TW G			
	150	BLUE	L861T	LED	10/15	TW G			
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PLANS DEVELOPED BY: MBA CONSULTING ENGINEERS, INC. 3812 SPENARD RD. ANCHORAGE, AK 99517 (907) 274-2622 CERT. OF AUTH. NO. AECC578

BY DATE **REVISION**

STATE OF ALASKA DEPARTMENT OF TRANSPORTATION AND PUBLIC FACILITIES CENTRAL REGION 4111 AVIATION AVE., ANCHORAGE ALASKA 99502 PHONE (907) 269-0590

HOMER AIRPORT HOMER, ALASKA AIRPORT IMPROVEMENTS PROJECT No. CFAPTO0491 AIP No. 3-02-0122-020-2022 TAXIWAY EDGE LIGHT SCHEDULES

2/17/2022 SHEET:

E28 of E30

\vdash	SIGN	c:==	0=::-	01 100			6:5=		HOMER SIGN SCHEDU		LEGEND	FACE	41.164		
	NUMBER	SIZE	STYLE	CLASS	MODE	STATUS	SIDE	TYPE	PURPOSE	LEGEND	COLOR	COLOR	ALIGNMENT	STATION	OF
							EAST			BLANK		BLACK	_		
	1	2	3	2	2	NEW	WEST	L-858Y(L)	TAXWIWAY DIRECTION SIGN	<-G	BLACK	YELLOW	RW		
							NORTH	L-858L(L)	TAXIWAY LOCATION SIGN	G	YELLOW	BLACK			
	2	2	3	2	2	NEW	NORTH	L-858R(L)	MANDATORY INSTRUCTION SIGN	22	WHITE	RED	RW		
							SOUTH			BLANK		BLACK			
_							NODTH	L-858L(L)	TAXIWAY LOCATION SIGN	G	YELLOW	BLACK			
	3	3	3	2	2	NEW	NORTH	L-858R(L)	MANDATORY INSTRUCTION SIGN	22	WHITE	RED	RW		
							SOUTH			BLANK		BLACK	-		
							EAST			BLANK		BLACK			
	4	2	3	2	2	NEW		L-858Y(L)	TAXWIWAY DIRECTION SIGN	<-G	BLACK	YELLOW	RW		
_							WEST		MANUAL DIRECTION SIGN		DEAGN	1			
_						DEI 00 1 T	EAST	L-858Y(L)	TAXIWAY DIRECTION SIGN	<-C	BLACK	YELLOW			
ı	5	2	3	2	2	RELOCATE D	WEST			BLANK		BLACK	RW		
							WLS			BLANK		BLACK			
						RELOCATE	NORTH			DLANK		BLACK			
	6	2	3	2	2	D	SOUTH	L-858L(L)	TAXIWAY LOCATION SIGN MANDATORY INSTRUCTION	С	YELLOW	BLACK	RW		
								L-858R(L)	SIGN	4	WHITE	RED			
						EXISTING	NORTH			BLANK	1	BLACK	_		
	7	2	3	2	2	TO REMAIN	SOUTH	L-858L(L)	TAXIWAY LOCATION SIGN	С	YELLOW	BLACK	RW		
_					A		300111	L-858R(L)	MANDATORY INSTRUCTION SIGN	4	WHITE	RED			L
							EAST			BLANK		BLACK			
	8	2	3	2	2	NEW		L-858Y(L)	TAXIWAY DIRECTION SIGN	<-B	BLACK	YELLOW	RW		
		4					WEST	L-858L(L) L-858Y(L)	TAXIWAY LOCATION SIGN TAXIWAY DIRECTION SIGN	D APRON->	YELLOW BLACK	BLACK YELLOW	1		
_							NORTH	L 0301(L)	TAXIWAT BIRLETION SIGN	BLANK	BLACK	BLACK			
	9	2	3	2	2	RELOCATE	NONTH	L-858L(L)	TAXIWAY LOCATION SIGN	В	YELLOW	BLACK	RW		
				_		D	SOUTH	L-858R(L)	MANDATORY INSTRUCTION	4-22	WHITE	RED	-		
١							NODTI		SIGN						
	10	2	3	2	2	RELOCATE	NORTH	1 050//	TAVIMAY LOCATION CON		VELLOW	DI ACIA	RW		
		_				D	SOUTH	L-858L(L) L-858R(L)	TAXIWAY LOCATION SIGN MANDATORY INSTRUCTION	A 4-22	YELLOW WHITE	BLACK RED	-		
	▼							L-858Y(L)	SIGN TAXIWAY DIRECTION SIGN	4-22 <-A	BLACK	YELLOW			\vdash
	11	2	3	2	2	RELOCATE	EAST	, ,					RW		
						D	WEST			BLANK		BLACK	-		
							EAST			BLANK		BLACK			
	12	2	3	2	2	RELOCATE D	WEST	L-858Y(L)	TAXIWAY DIRECTION SIGN	A->	BLACK	YELLOW	RW		
								L-858Y(L)	TAXIWAY DIRECTION SIGN	<-B	BLACK	YELLOW			
	13	2	3	2	2	RELOCATE D	EAST			BLANK		BLACK	RW		
							WEST						1		

PLANS DEVELOPED BY:

MBA CONSULTING ENGINEERS, INC.

3812 SPENARD RD.

ANCHORAGE, AK 99517

(907) 274-2622

CERT. OF AUTH. NO. AECC578

BY DATE REVISION

STATE OF ALASKA
DEPARTMENT OF TRANSPORTATION
AND PUBLIC FACILITIES
CENTRAL REGION
4111 AVIATION AVE., ANCHORAGE ALASKA 99502
PHONE (907) 269-0590

HOMER AIRPORT
HOMER, ALASKA
AIRPORT IMPROVEMENTS
PROJECT NO. CFAPTO0491
AIP No. 3-02-0122-020-2022
SIGN SCHEDULE #1

2/17/2022 SHEET:

E29 of E30

	HOMER HANDHOLE SCHEDULE - OBSTRUCTION LIGHT											
UNIT #	SYSTEM	PAY ITEM	PAY UNIT	SHEET NUMBER AND NOTES								
H01	OBSTRUCTION LIGHT	L119.010.0000	LUMP SUM	E12, NOTE 1								
H02	OBSTRUCTION LIGHT	L119.010.0000	LUMP SUM	E12, NOTE 1								
Н03	OBSTRUCTION LIGHT	L119.010.0000	LUMP SUM	E12, NOTE 1								
H04	OBSTRUCTION LIGHT	L119.010.0000	LUMP SUM	E12, NOTE 1								
H05	OBSTRUCTION LIGHT	L119.010.0000	LUMP SUM	E12, NOTE 1								
H06	OBSTRUCTION LIGHT	L119.010.0000	LUMP SUM	E13, NOTE 1								
H07	OBSTRUCTION LIGHT	L119.010.0000	LUMP SUM	E13, NOTE 1								
Н08	OBSTRUCTION LIGHT	L119.010.0000	LUMP SUM	E13, NOTE 1								
H09	OBSTRUCTION LIGHT	L119.010.0000	LUMP SUM	E13, NOTE 1								
H010	OBSTRUCTION LIGHT	L119.010.0000	LUMP SUM	E14, NOTE 1								
H011	OBSTRUCTION LIGHT	L119.010.0000	LUMP SUM	E14, NOTE 1								
H012	OBSTRUCTION LIGHT	L119.010.0000	LUMP SUM	E14, NOTE 1								
H013	OBSTRUCTION LIGHT	L119.010.0000	LUMP SUM	E14, NOTE 1								
H014	OBSTRUCTION LIGHT	L119.010.0000	LUMP SUM	E15, NOTE 1								
H015	OBSTRUCTION LIGHT	L119.010.0000	LUMP SUM	E15, NOTE 1								
H016	OBSTRUCTION LIGHT	L119.010.0000	LUMP SUM	E15, NOTE 1								
H017	OBSTRUCTION LIGHT	L119.010.0000	LUMP SUM	E15, NOTE 1								

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1. FIELD LOCATE AND AS-BUILT LOCATION

							HOMER	R SIGN SCHEDULE CO	NTINUED					
SIGN NUMBER	SIZE	STYLE	CLAS S	MODE	STATUS	SIDE NUMBER	TYPE	PURPOSE	LEGEND	LEGEND COLOR	FACE COLOR	ALIGNMENT	STATION	OFFSET
						EAST			BLANK		BLACK			
14	2	3	2	2	RELOCATED		1 0500(1)	TANGULA SIDESTIAN SIST		51.101	VEL 1 0 W	RW		
						WEST	L-858Y(L)	TAXIWAY DIRECTION SIGN	B->	BLACK	YELLOW	-		
							L-858L(L)	TAXIWAY LOCATION SIGN	В	YELLOW	BLACK			
15	2	3	2	2	EXISTING	NORTH	L-858R(L)	MANDATORY INSTRUCTION SIGN	4-22	WHITE	RED	RW		
15	4			2	TO REMAIN	COLLELL	L-858Y(L)	TAXIWAY DIRECTION SIGN	APRON	BLACK	YELLOW	- KW		
						SOUTH								
						EAST			BLANK		BLACK			
16	2	3	2	2	NEW		L-858Y(L)	TAXIWAY DIRECTION SIGN	<-B	BLACK	VELLOW	RW		
						WEST	L-6561(L)	LAXIWAY DIRECTION SIGN	<-B	BLACK	YELLOW	-		
							L-858Y(L)	TAXIWAY DIRECTION SIGN	B->	BLACK	YELLOW			
17	2	3	2	2	NEW	EAST						RW		
17	2			2	INEW	WEST			BLANK		BLACK] ""		
								·						
						NORTH						_		
18	2	3	2	2	NEW		L-858L(L)	TAXIWAY LOCATION SIGN	J	YELLOW	BLACK	RW		
					•	SOUTH	L-858R(L)	MANDATORY INSTRUCTION	4-22	WHITE	RED			
							. ,							
						EAST	2 0001(2)	TAXIMAT BIRECTION SIGN		BEAGN	TELEOW			
19	2	3	2	2	NEW	WEST			BLANK		BLACK	RW		
						WEST			_					
						EAST			BLANK		BLACK	1		
20	2	3	2	2	NEW		1-858Y(1)	TAXIWAY DIRECTION SIGN	.1–>	BLACK	YELLOW	RW		
						WEST	2 0001(E)	TAXINAT DIRECTION SIGN	0 /	BLACK	1111011	1		
19	2	3	2	2	NEW	WEST EAST	L-858Y(L) L-858Y(L) L-858Y(L)	SIGN TAXIWAY DIRECTION SIGN TAXIWAY DIRECTION SIGN	<-J	BLACK BLACK	YELLOW	RW RW		

PLANS DEVELOPED BY:			
MBA CONSULTING ENGINEERS, INC.			
3812 SPENARD RD.			
ANCHORAGE, AK 99517			
(907) 274-2622			
CERT. OF AUTH. NO. AECC578	BY	DATE	

REVISION

STATE OF ALASKA **DEPARTMENT OF TRANSPORTATION** AND PUBLIC FACILITIES **CENTRAL REGION** 4111 AVIATION AVE., ANCHORAGE ALASKA 99502 PHONE (907) 269-0590

HOMER AIRPORT HOMER, ALASKA AIRPORT IMPROVEMENTS PROJECT No. CFAPT00491 AIP No. 3-02-0122-020-2022 SIGN SCHEDULE #2

2/17/2022 SHEET:

E30 of E30